236-248 EAST 3rd STREET DEVELOPMENT APPLICATION

Civic Address: 236-248 East 3rd Street, City of North Vancouver Legal Description: Lots 22-25,Block 131, DL 274, G1, NWD, plan 878

Zoning: RT-1



North Building Elevation

Reflected Elevation North

Reflected Elevation East

Architectural Precedents

Contex Sections & Site Plan

Ground Level Area Overlay

Perspectives

Shadow Study

View Impact Study

View Impact Study

Level 1 Area Overlay

Level 2 Area Overlay

Level 3 Area Overlay

Level 6 Area Overlay

Roof Area Overlay

Level 4-5 Area Overlay

A4.03

A4.04

A4.04

A5.02

A5.03

A5.04

A5.05

A6 01

A6.02

A6.03

A6.04

A6.05

VIEWS ANALYSIS

AREA OVERLAY

DRAWING LIST

ARCHITE	CTURAL
A0.00	Cover Sheet
A0.01	Design Rationale
A0.02	Project Summary
A0.03	Site Context and Photos

SITE PLAN A1.01

11 Site Plan / Roof Plan

FLOOR PLANS

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A2.02 Level 1 Floor Plan
A2.03 Level 2 Floor Plan
A2.04 Level 3 Floor Plan
A2.05 Level 4 Floor Plan
A2.06 Level 6 Floor Plan
A2.07 Roof Plan
A2.08 Level 2 Adaptable Unit Plan

SECTIONS

A3.01 Building Section A-A
A3.02 Building Section B-B
A3.03 Building Section C-C

ELEVATIONS

A4.01 South Building Elevation
A4.02 East & West Building Elevations

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221 Esplanade West

LANDSCAPE ARCHITECTS

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236-248 EAST 3RD

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Sheet Title

COVER SHEET

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Approved		
Date 201	7.09.29	Revision •

236-248 East 3rd Street North Vancouver Architectural Design Rationale

Overview

- This low-rise residential project is proposed for a site situated along the north side of East 3rd Street. This area and in particular 3rd Street has experienced a significant amount of redevelopment in recent years as a part of the City's vision to provide higher density housing options close to the downtown core.
- The proposal is for a market condominium development with 60 units

City and Regional Planning Context

- OCP "In 2031, the City of North Vancouver will be a vibrant, diverse, and highly livable community that is resilient to climate or other changes, and sustainable in its ability to prosper without sacrifice to future aenerations".
- The building design takes into consideration the future widening of East 3rd Street right-of-way to enable potential future transit expansion.

Site Planning Context

- There are currently four houses located on the four lots that make up
 the proposed development site. The existing three buildings to the
 west are all multi-unit residential buildings. The multi-family building
 on the most eastern lot was recently severely damaged by fire. All
 buildings will be demolished to accommodate the proposed building.
- Third Street has seen extensive development in recent years with larger scale low rise buildings being built along this future transit corridor. Redevelopment of this street is expected to continue over time.
- The Street has been identified as a future transit corridor and as such may need to be widened. In order to accommodate this a new property line is required 3m north of the existing reducing the development site area.
- Surrounding properties to the north are a mix of multi-level townhouses and older single family residences.
- Retaining walls, staircases and terraced landscaping is characteristic
 of existing developments on the north side of the 3rd Street in
 addressing the steep topography.

The Site

- The site steeply slopes from a high point along the lane to the north down approximately 4.5m (14.7ft) to East 3rd Street.
- All new vehicular access to the site is restricted to the lane to the north which is at the highest site elevation.
- Newer 4 and 5-storey multifamily residential buildings are located across 3rd to the South.
- Setbacks provided as required:
- o Front: 3m o Side: 2.4m
- o Rear: 1.6m

Design Rationale

Project Massing

- The project is a low-rise market condominium development with 57 residential units located on a steeply sloping site.
- The building massing is broken down into three main components: a series of highly articulated three storey expression with two storey townhouses and entry lobby that form the base; a middle section with strong alternating cantilevered slab pattern, and a terraced top with large south-facing rooftop terraces.
- Unit plans on typical floors are arranged to maximize privacy between units by limiting the number of balconies adjacent to each
- The upper floor is recessed further back from the street allowing for larger roof terraces, and minimizing the scale of the building when viewed from the street.

Design Response / Architectural Character

- The building is designed to be a contemporary response to this
 evolving architectural character in the neighbourhood; characterized
 by clean lines, simple geometries, as well as a layering of materials
 and use of colour and pattern.
- The surrounding natural environment of mountains, ocean and trees also influences the building character.
- Inspiration from these sources becomes evident in the architectural language:
- Asymmetry in the composition of the lower floors provides areas
 of exuberance such as at the entry contrasted with areas of visual
 quiet of the background walls.
- o Vertical wall planes contrast with large expanses of glass that together frame, direct and at times edit views.
- An alternating pattern of balcony slabs are used to accentuate the horizontal nature of the middle of the building, as well as providing shading.
- o Interior spaces are oriented to maximize daylight, views and control unwanted solar gain.
- Interior public corridors enjoy access to natural light at opposite ends of the building, while the two exit stairs are located to encourage their use by again providing natural light while opening up to southern views.
- There is a strong integration of indoor and outdoor spaces with all roof areas (below the main roof) being designed as private outdoor terraces.

Colour and Materials

- The colours and materials for the project seek to reinforce the unique architectural contemporary character of the building. The overall colour palette is relatively light restrained, and plays a secondary role to the highly articulated facade.
- The townhouses and the lower floors of the building employ a darker richer colour palette than the upper floors.
- Smooth brick is laid in a geometric 'Flemish' pattern with alternating projecting bricks for added texture and visual interest.
- Townhouse entry doors are charcoal coloured and feature a vertical pattern
- The upper floors of the building are predominantly off-white metal panels. Darker grey panels are used at the top floor to visually recede.

A metallic rust colour is used as an accent on some of the spandrel glass, while remaining spandrel glass is predominantly a contrasting charcoal colour.

- A decorative laser cut screen of corten steel is proposed for above the main entry and is layered over the indoor amenity spaces, while framing the common amenity terrace.
- Silver window mullions are used throughout the building with the exception of the townhouses on the lower two floors where they are

Sustainability

Environmental Sustainability

- The development density provides an efficient use of the site
- Solar orientation and shading technologies have been incorporated into the design where feasible
- · A Storm water management strategy is being developed
- Drought resistant and native planting
- Use energy star appliances
 Use energy efficient lighting
- Use various recycled materials in the construction process where
 provible.
- Follow appropriate recycling practices in the construction process
- Use low flow nlumbing fixtures
- Purchase locally for building materials where possible
- Include fly-ash into the locally produced concrete
- Use motion sensors and timers where possible
- Employ enhanced indoor environmental measures such as low emission materials and operable windows
- Refer to Sustainable Development Guideline/checklist for additional information.

Social / Cultural Sustainability

- The development provides a mix of market residential units ranging from smaller one bedroom suites to larger 2 bedroom townhouses and 3 bedroom penthouses.
- Provides the opportunity for some residents to walk to their employment
- A multipurpose amenity room and fitness facility are provided for residents
- Exit stairs have windows and access to views to encourage their use

Economic Sustainability

 Both temporary construction related jobs and permanent jobs in the commercial portion will be provided.


Landscape Design Rationale

The landscape design for this new residential development is based on a concept of creating a landscape that is both fitting with the local neighbourhood context, and fitting the project into a site with a significant grade change from lane to street. A focus on attractive private entries and spaces is halanced with attractive street and lane frontage improvements.

The grade changes from the street to the lane set up a series of terraced levels. On the 3rd Avenue side, this sets up a raised entry access level for the lobby and townhomes. This creates an unique condition for the front entries in relation to the street, which we take advantage of for expressing attractive front entry stoops. Plantings layer at the base of walls to provide a lush green frontage along 3rd Avenue. The landscape palette will include rich and interesting paving materials and furnishings at the tower lobby.

The lane edges are also layered with green at several layers to provide a very attractive rear of the building for both residents and neighbours. Trees are provided in the lane and at mid-level patios to maximize the planted appearance, and provide privacy for residents and neighbours. Plantings occur as high as the 6th level, but don't include trees that would block views or be higher than the building.

Clean and simple materials will be fitting to the style of the architecture, and help reduce maintenance demands. Plant materials will be simple and durable, creating a strong evergene. People will be able to enjoy a low-maintenance, detailed, and attractive landscape that serves both the residential aspects and provides a strong street and lane image. The landscape design will establish an attractive, functional, and easily maintained quality. Drought tolerant plantings with a good range of seasonal interest and texture will help to set the character of the development

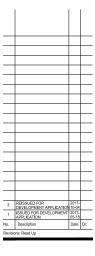



236-248 EAST 3RD

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DESIGN RATIONALE

| Jan No. 1611-000 | Sheet No. | Sheet No.

SITE STATISTICS

Address	Street	Site Area (SM)		FSR (from OCP)	FSR Area(SM)	
		sq.m	sq.ft.		sq.m	sq.ft.
236-248	East 3rd	2,232	24,025	2.6	5,803	62,466
Developable Densit	y (Allow FSR Area)				5,803	62,466
Proposed				2.56	5,725	61,619
Net Area					4,741	51,027

BLDG. SETB	ACKS	Proposed
Front Lot Li	ne	3 (9.8ft)
Rear Lot Lin	e	1.6 (5.2ft)
Site Lot Line	j	2.4 (7.9ft)
Site Covera	ge	68%

BUILDING AREAS

GR	OSS AREA		FSR EXCLUSI	IONS									FSR	AREA				BALCONIES/OP	EN CORRIDORS
Levels	Gross	s Area	Level 2 Ada	ptable Units	Am	enity	Services	/Parking	Storage	e/Lobby	Exterior	Cladding			Net Area (SM)		Suite Count	not inc. ro	of terraces
	sq.m	sq.ft.	sq.m.	sq.ft.	sq.m.	sq.ft.	sq.m.	sq.ft.	sq.m.	sq.ft.	sq.m.	sq.ft.	sq.m.	sq.ft.	sq.m.	sq.ft.		sq.m.	sq.ft.
G	1370	14,747	0	0	63	678	258	2,777	501	5,393	9	97	539	5,802	384	4,133	6	0	0
1	1524	16,404	0	0	62	667	982	10,570	0	0	9	97	471	5,070	327	3,520	0	36	388
2	1480	15,931	0	0	0	0	940	10,118	0	0	11	118	529	5,694	385	4,144	7	36	388
3	1164	12,529	9.5	102	0	0	0	0	0	0	19	205	1136	12,223	984	10,586	13	0	0
4	1164	12,529	9.5	102	0	0	0	0	0	0	19	205	1136	12,223	984	10,586	13	85	915
5	1164	12,529	9.5	102	0	0	0	0	0	0	19	205	1136	12,223	984	10,586	13	85	915
6	790	8,504	0	0	0	0	0	0	0	0	11	118	779	8,385	694	7,470	5	122	1,313
Roof	31	334	0	0	0	0	31	334	0	0	0	0	0	0	0	0	0	0	0
Totals	8,687	93,507	29	307	125	1,346	2,211	23,799	501	5,393	97	1,044	5,725	61,619	4,741	51,027	57	364	3,918
					< 5%GFA=439 s	g.m.			< 0.1FSR or 109	6GFA								% of GFA	4%

BICYCLE STORAGE	Required	Proposed
Secure @ 1.5	86	86
Short-Term	6	6
STORAGE LOCKERS		86

PARKING		No. Units	Required	Bike Room Reduction	Total
Resident @ 1.0	1.00	57	57	9	48
Visitor @ 0.2	0.20	57	11	5	6
Total Required			68	14	54
Total Provided					62
including:	Small Car (r	nax. 35%)			15
	HC Parking	Stalls			4

SUITE MIX	Size sq.ft.	Suite %	Suite Count	Level 2 Adaptable Units
1B+D	589-738	54%	31	9
2B	723	5%	3	0
2B+D	991-1293	26%	15	3
3B	1063-1360	7%	4	0
3B+D	1595-1574	7%	4	3
		TOTAL	57	15

ADAPTAE	BLE UNITS	HC Parking Stalls
Level 1	42	2
Level 2	15	2
TOTAL	57	4

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2	REISSUED FOR DEVELOPMENT APPLICATION	2017-	
1	ISSUED FOR DEVELOPMENT APPLICATION	2017 05-18	
lo.	Description	Date	Dr.




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Smeat Tale

SUMMARY STATISTICS

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(1) KEY PLAN 1:1000

2 EXISTING STREET VIEWS



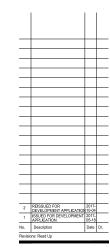



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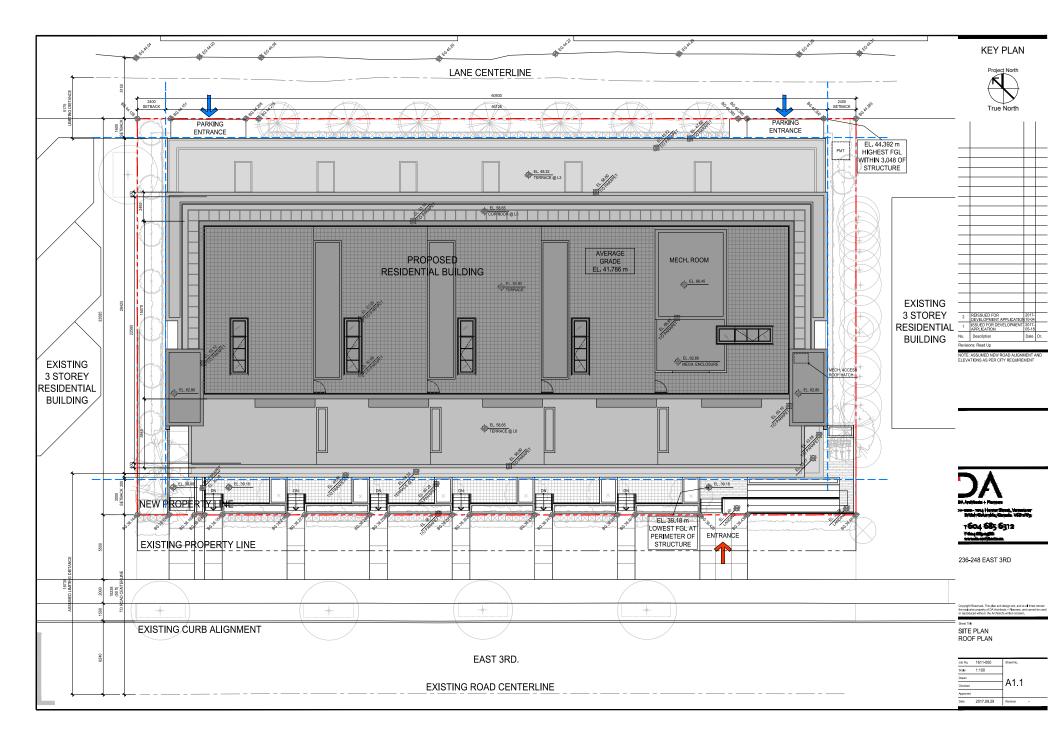
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Shoot Tide SITE CONTEXT & PHOTOS


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Date	2017.09.29	Revision -

 $\underbrace{4}_{\text{A0.3}} \text{EAST 3RD ST - LOOKING NORTH PROPOSED}$

(C) FACT ARR CT. LOOVING COUTH EVICTING	


5 EAST 3RD ST. - LOOKING SOUTH EXISTING



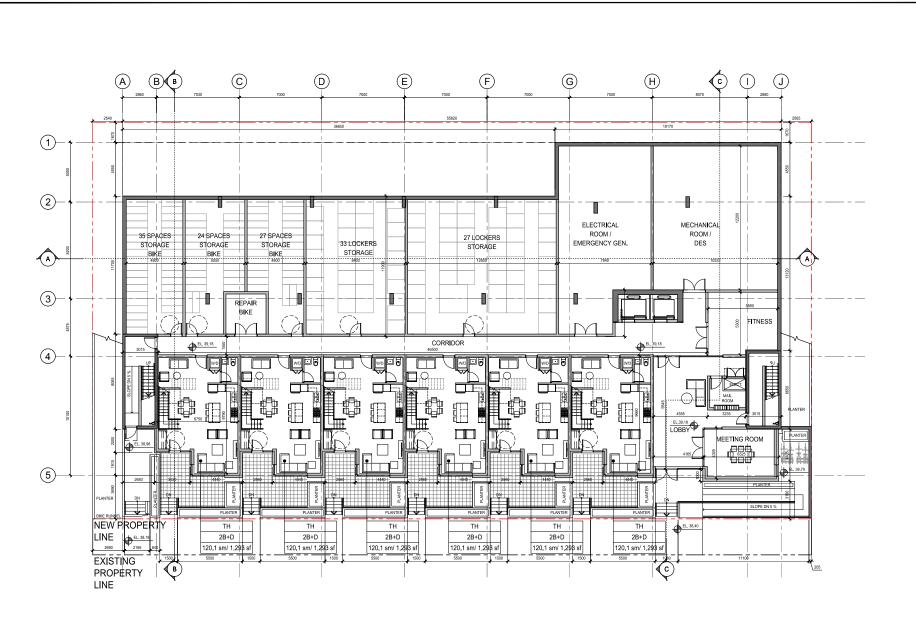

KEY PLAN



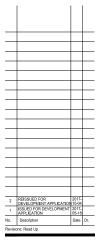



236-248 EAST 3RD


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GROUND LEVEL FLOOR PLAN

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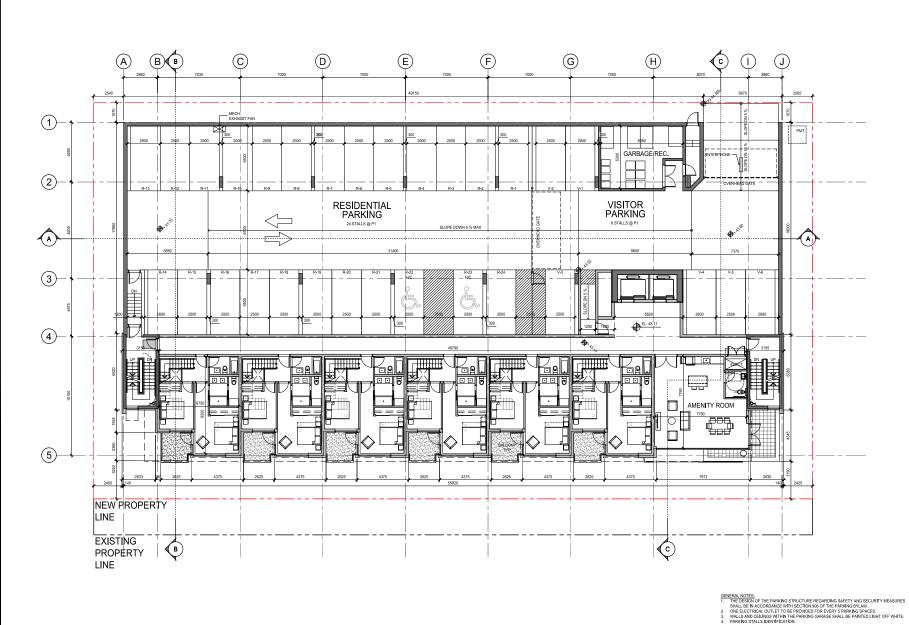




LEVEL 1 FLOOR PLAN


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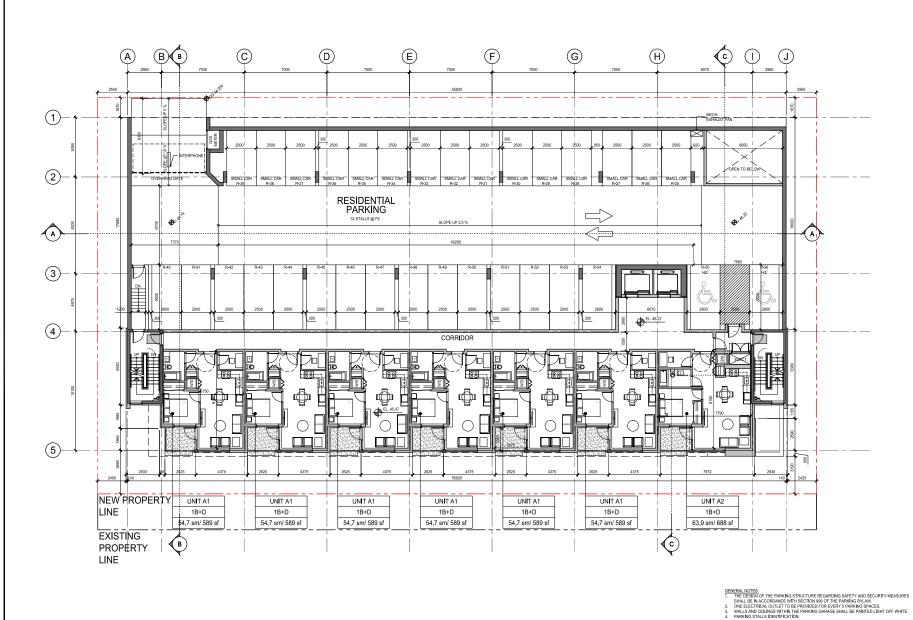


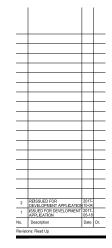

LEVEL 2 FLOOR PLAN

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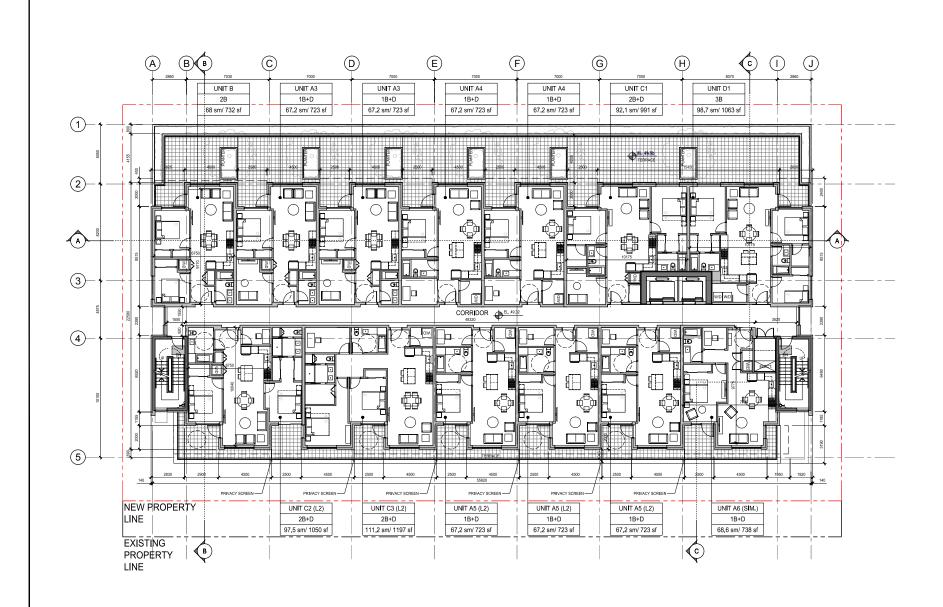
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LEVEL 3 FLOOR PLAN


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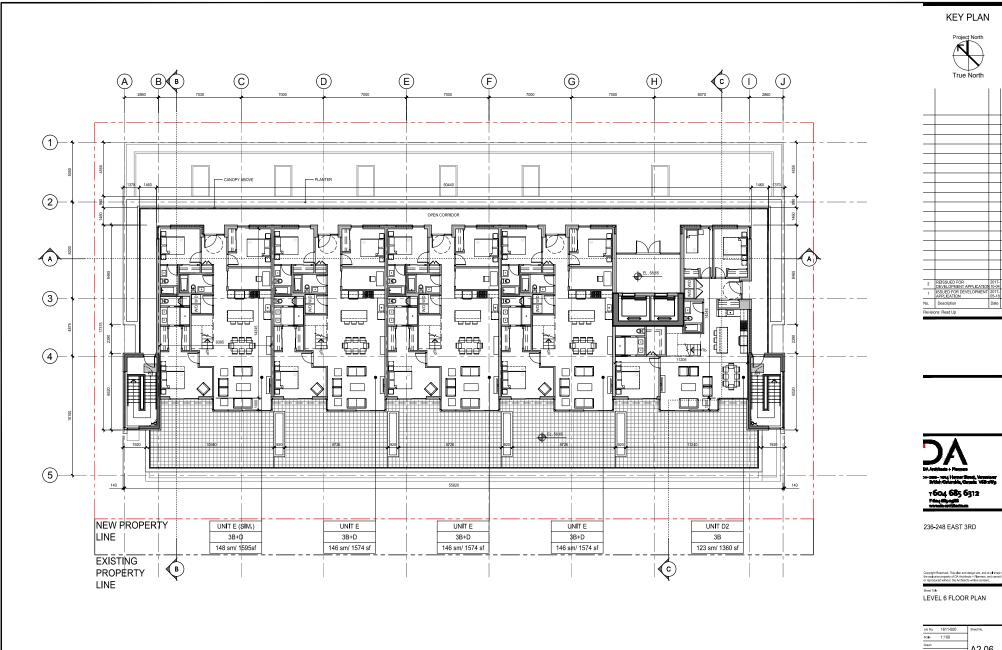
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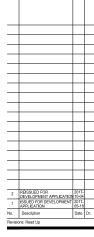


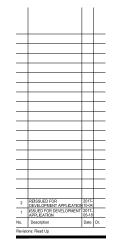LEVEL 4-5 FLOOR PLAN

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Date 2017.09.29 Revision







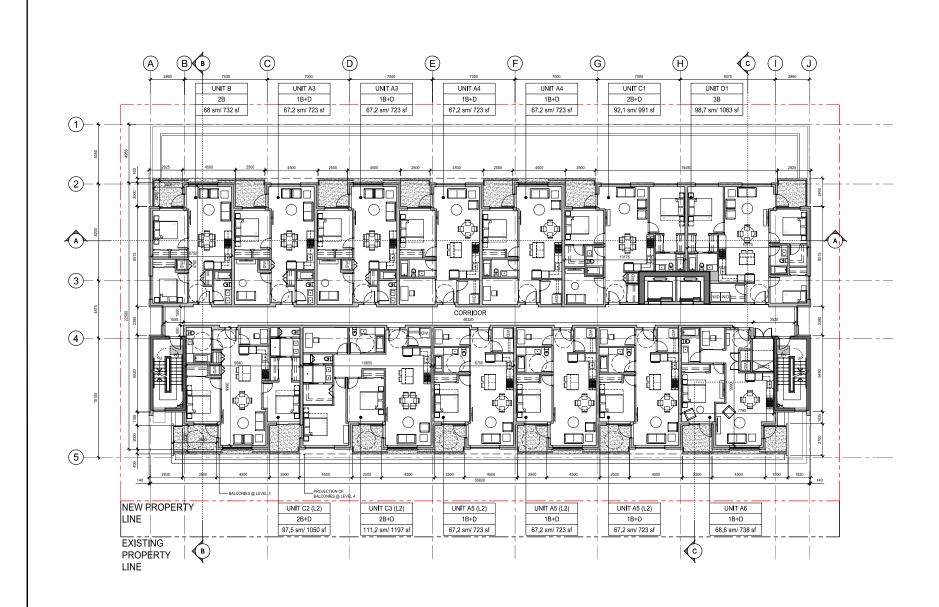






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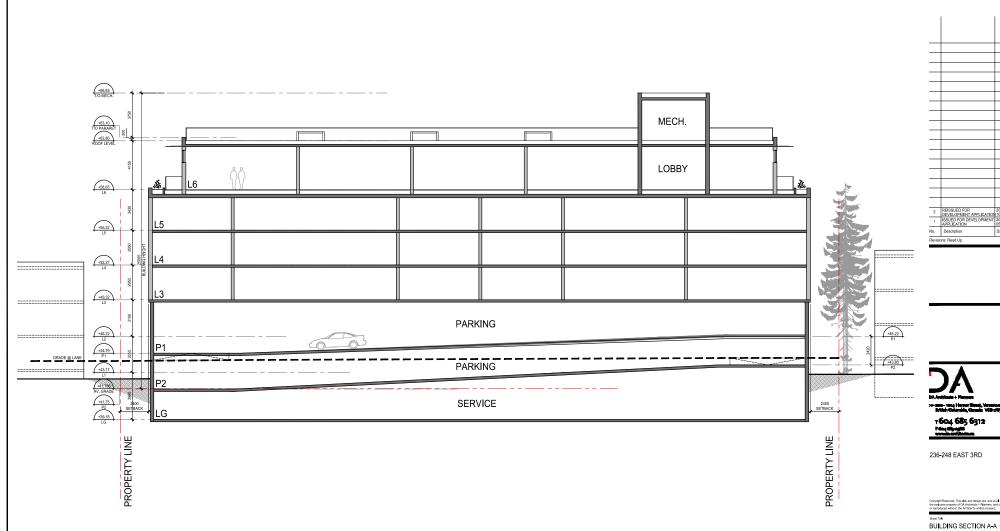


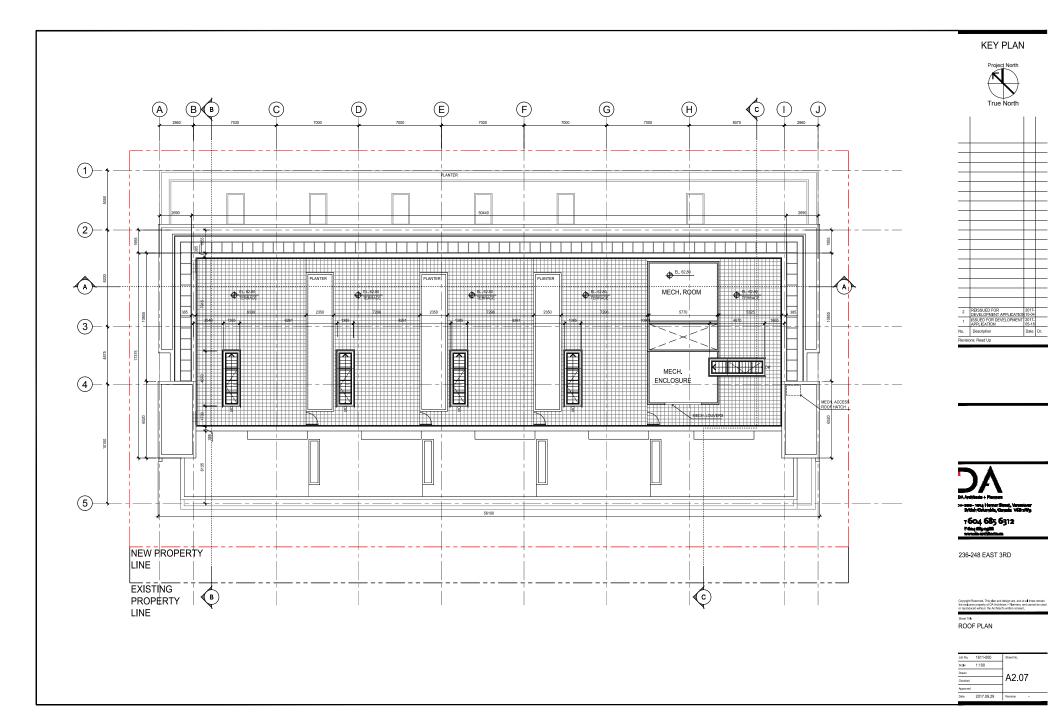

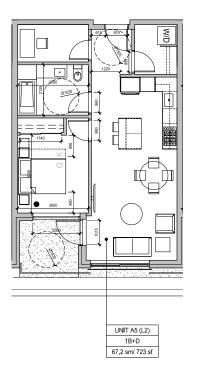


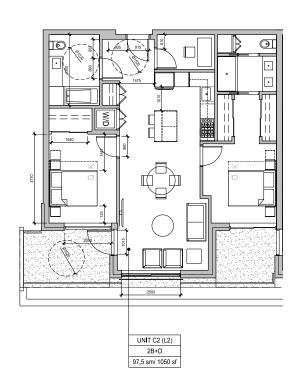Shoot Tale
LEVEL 2 ADAPTABLE UNIT PLAN
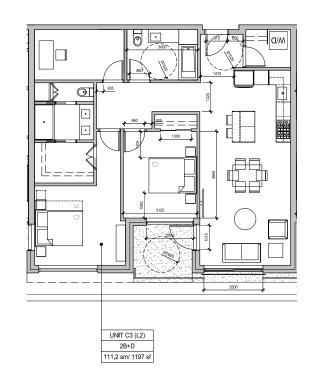
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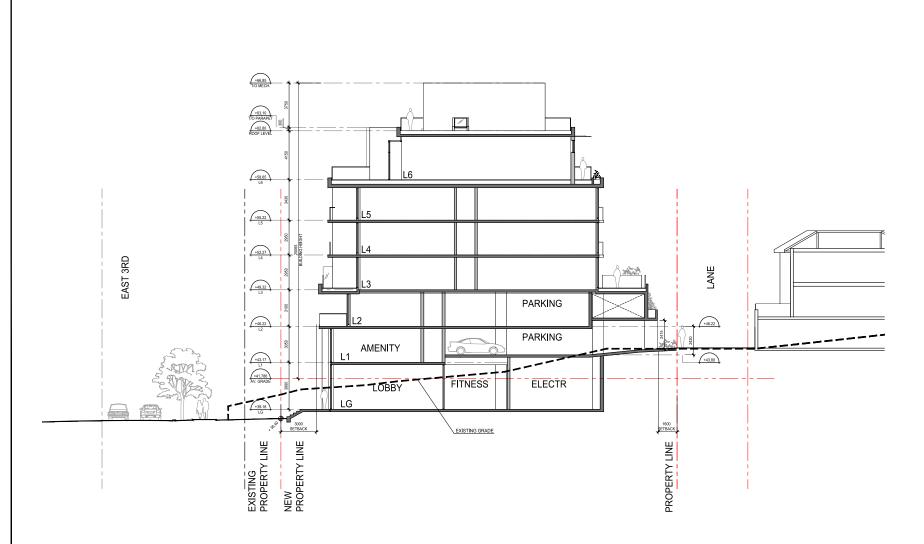
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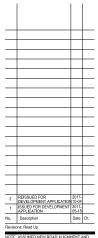
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236-248 EAST 3RD

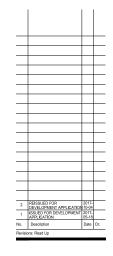Street Tible
BUILDING SECTION B-B

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NOTE: ASSUMED NEW ROAD ALISNMENT AND ELEVATIONS AS PER CITY REQUIREMENT
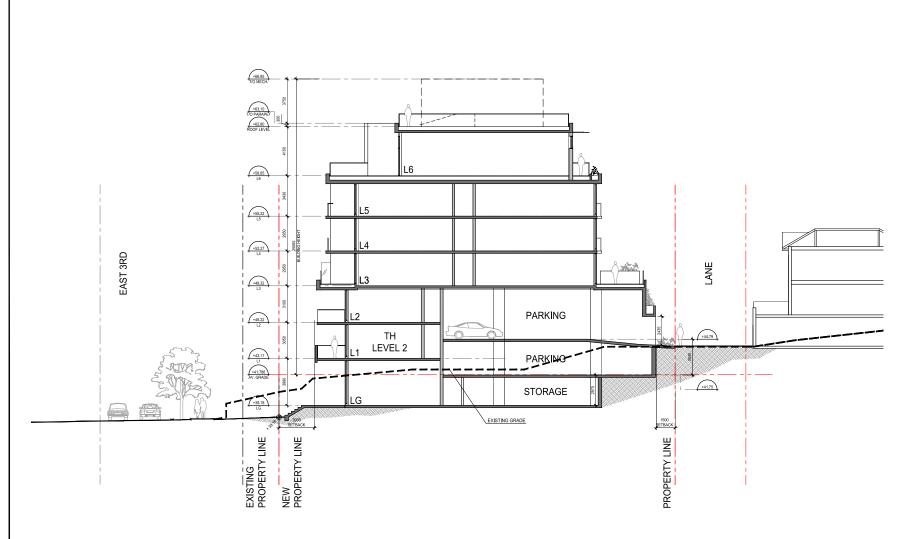
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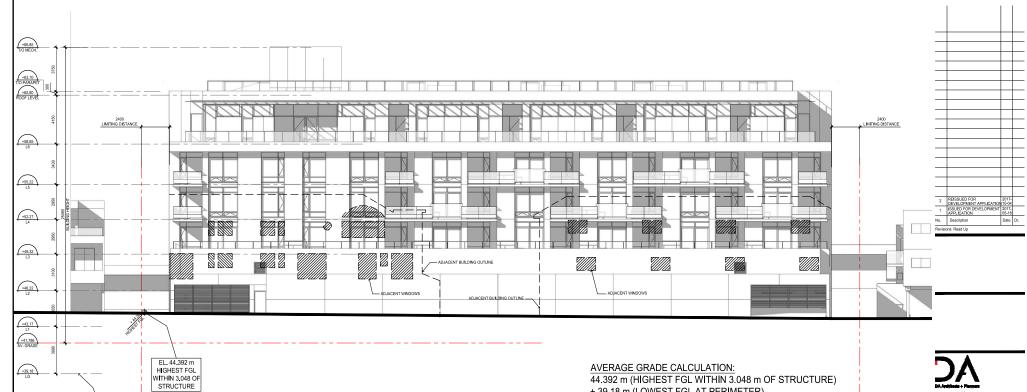
Street Table
BUILDING SECTION C-C

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44.392 m (HIGHEST FGL WITHIN 3.048 m OF STRUCTURE)

+ 39.18 m (LOWEST FGL AT PERIMETER)

/2 = 41.786 m

1604 685 6312 Final States

236-248 EAST 3RD


REFLECTED ELEVATION NORTH HEIGHT CALCULATION


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1 NORTH ELEVATION

EL. 39.18 m LOWEST FGL AT PERIMETER OF STRUCTURE

PROPERTY LINE



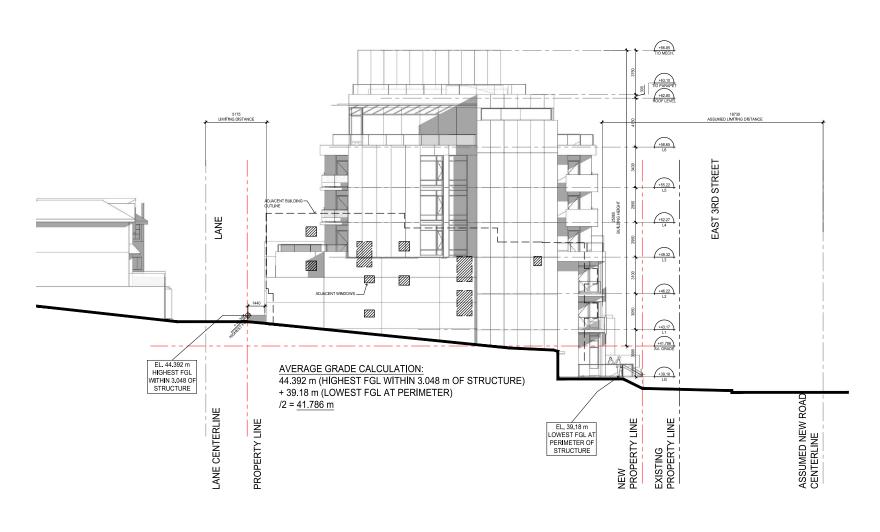

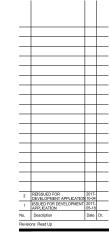236-248 EAST 3RD

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STOREST TERM
REFLECTED ELEVATION EAST HEIGHT CALCULATION

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Date	2017.09.29	Revision •



KEY PLAN







HIGHLY ARTICULATED EDGES STEPPING OF THE BUILDING







DAYLIT STAIRCASE

















RICHNESS OF MATERIALS AND COLOURS INSPIRED BY NATURE





FEATURE WALL PATTERN AND DETAIL

>>-see-1014 Homer Street, Vancouver British Columbia, Canada VEB villa
British Columbia, Consula VGB sWg
⊤604 685 6312
Pday digages

236-248 EAST 3RD

Street Title
ARCHITECTURAL PRECEDENT

Job No.	1611-000	Sheet No.	
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3 LANE VIEW LOOKING EAST

 $\underbrace{\text{1}}_{\text{N/A}} \text{STREET VIEW LOOKING NORTH}$









KEY PLAN

 $\underbrace{ \text{2} }_{\text{N/A}} \text{STREET VIEW LOOKING WEST}$


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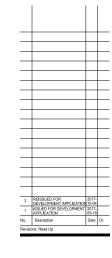
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Sheet Title
PERSPECTIVES

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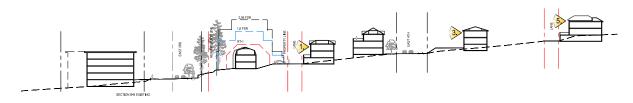





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Street Tale
VIEW IMPACT STUDY
CONTEXT SECTIONS &
SITE PLAN

Job No.	1611-000	Sheet No.
Scale	1:500	
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Date	2017 09 29	Revision

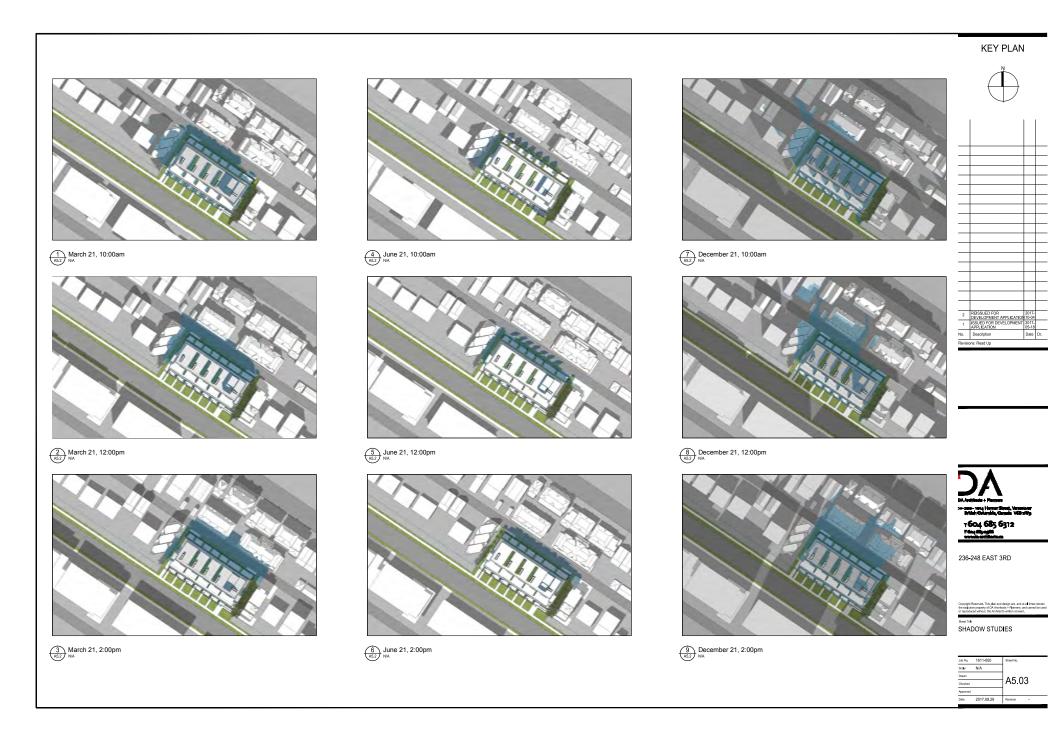

SECTION B-B

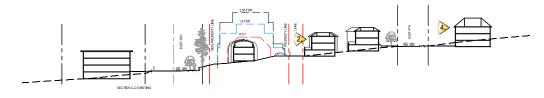

3 SECTION C-C



CURRENT VIEW



2.56 FSR

 $\overbrace{^{\text{A5.05}}_{\text{NTS}}}^{\text{VIEW}}$ FROM THE NEIGHBOURS (BLDG NO. 4)


CURRENT VIEW

1.6 FSR

2.56 FSR

 $\overbrace{5}_{\text{NTS}}$ VIEW FROM THE NEIGHBOURS (BLDG NO. 5)



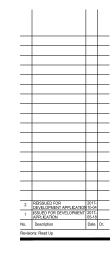




236-248 EAST 3RD

VIEW IMPACT STUDY

A5.05 Approved
Date 2017.09.29 Revision

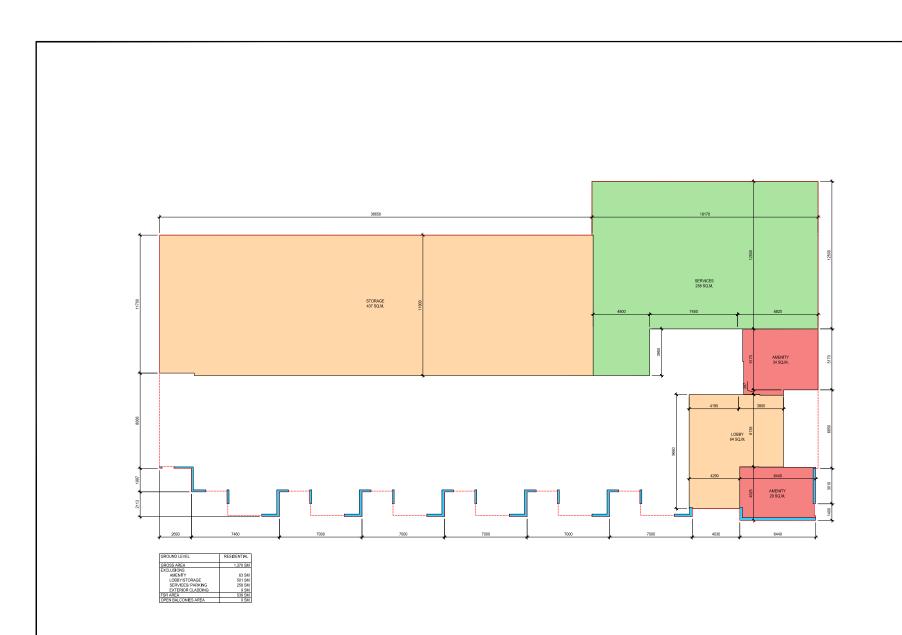

KEY PLAN



	I		1
2	REISSUED FOR DEVELOPMENT APPLICATION	2017- 10-04	
1	ISSUED FOR DEVELOPMENT APPLICATION	2017- 05-18	
No.	Description	Date	Dr.
Revisi	ons: Read Up		




236-248 EAST 3RD

GROUND LEVEL FLOOR PLAN AREA OVERLAY

Job No.	1611-000	Sheet No.
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Checked		A6.01
Approved		
Date	2017 09 29	Revision -






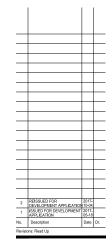




Street Title
LEVEL 1 FLOOR PLAN
AREA OVERLAY

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Date	2017 09 29	Revision -

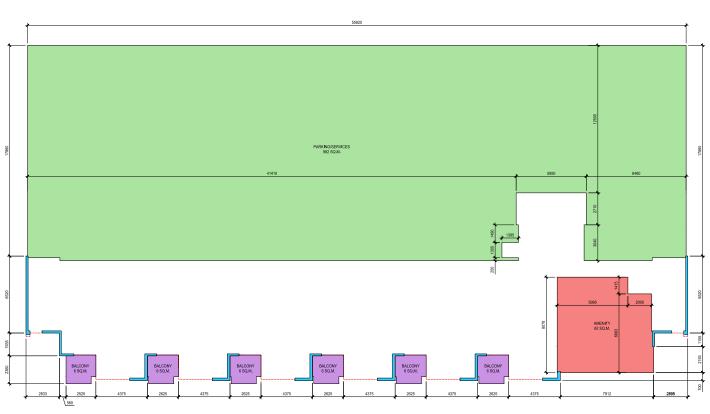

LEVEL 1	RESIDENTIAL
GROSS AREA	1,524 SM
EXCLUSIONS	
AMENITY	62 SM
LOBBY/ STORAGE	0 SM
SERVICES/ PARKING	982 SM
EXTERIOR CLADDING	9 SM
FSR AREA	471 SM

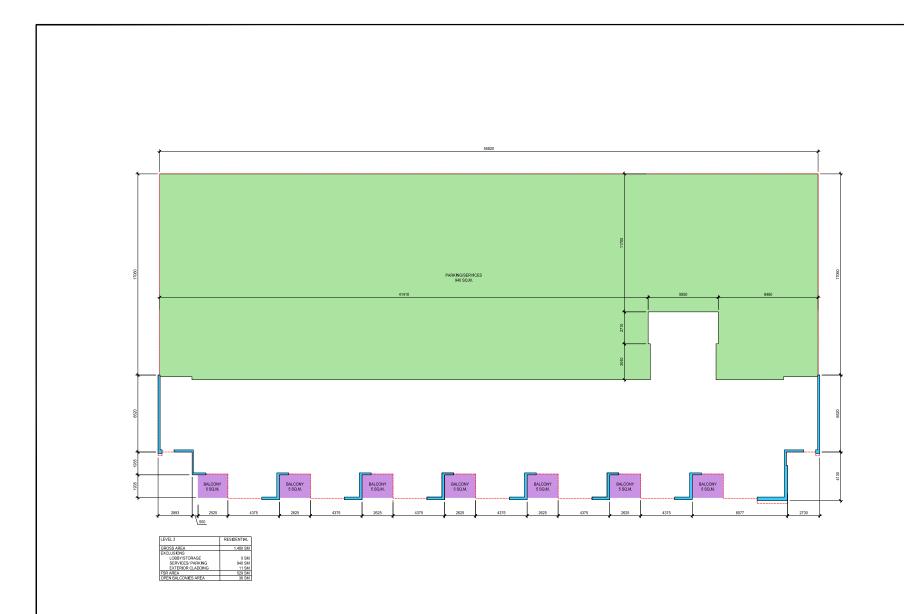






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Street Table
LEVEL 2 FLOOR PLAN
AREA OVERLAY

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Approved		7
Date	2017.09.29	Revision •

KEY PLAN



LΕ	/EL 3	RESIDENTIAL
GR	OSS AREA	1,164 SM
EX	CLUSIONS	
	LOBBY/ STORAGE	0 SM
	SERVICES/ PARKING	0 SM
	EXTERIOR CLADDING	19 SM
5x	LEVEL 2 ADAPTABLE UNIT	9.5 SM
FSR AREA		1136 SM
OP	EN BALCONIES AREA	0 SM

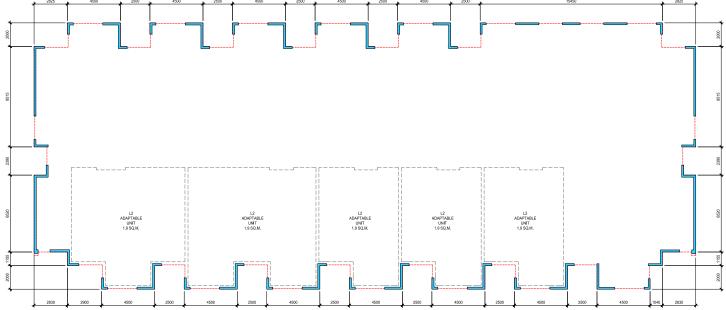

1604 685 6312


236-248 EAST 3RD

Street Table
LEVEL 3 FLOOR PLAN
AREA OVERLAY

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Date	2017 09 29	Revision -






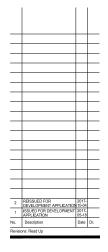



Street Title
LEVEL 4-5 FLOOR PLAN
AREA OVERLAY


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Date	2017.09.29	T	Revision •

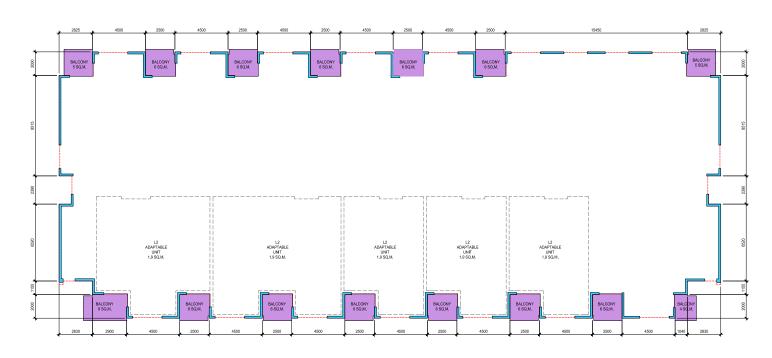

LEVEL 4-5	RESIDENTIAL
GROSS AREA	1,164 SM
EXCLUSIONS	
LOBBY	0 SM
SERVICES	0 SN
EXTERIOR CLADDING	19 SM
5x LEVEL 2 ADAPTABLE UNIT	9.5 SM
FSR AREA	1136 SM
OPEN BALCONIES AREA	85 SN






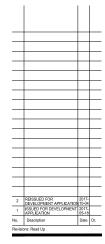



Street Title
LEVEL 6 FLOOR PLAN
AREA OVERLAY


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Date	2017.09.29	Revision -

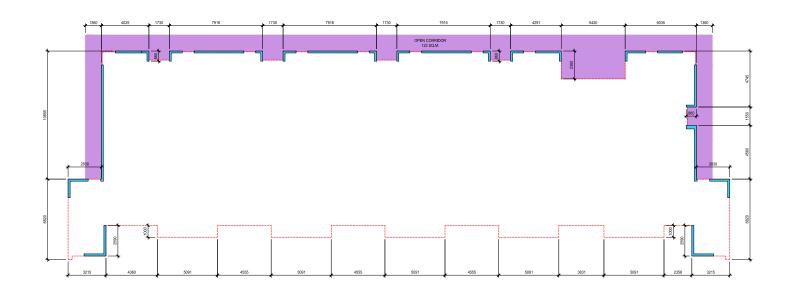

LEVEL 6	RESIDENTIAL
GROSS AREA	790 SM
EXCLUSIONS	
LOBBY/STORAGE	0 SM
SERVICES/PARKING	0 SM
EXTERIOR CLADDING	11 SM
FSR AREA	779 SM
OPEN BALCONIES AREA	122 SM





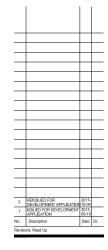




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Short Tab.

ROOF PLAN


AREA OVERLAY

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Date	2017,09,29	Revision -

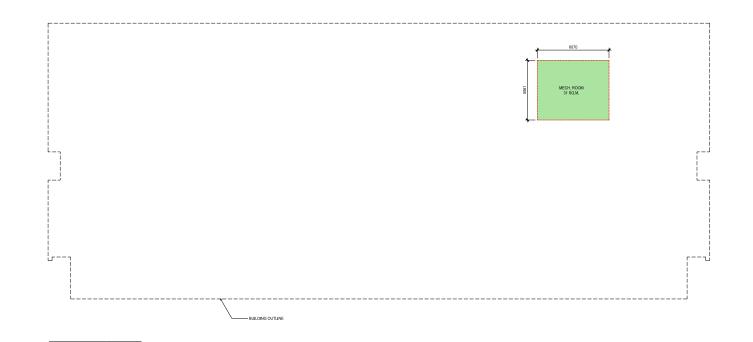

GROSS AREA
EXCLUSIONS
LOBBY: STORAGE
SERVICES! PARKING
EXTERIOR CLADDING
FOR AREA
OPEN BALCONIES AREA

0 SM 31 SM 0 SM 0 SM

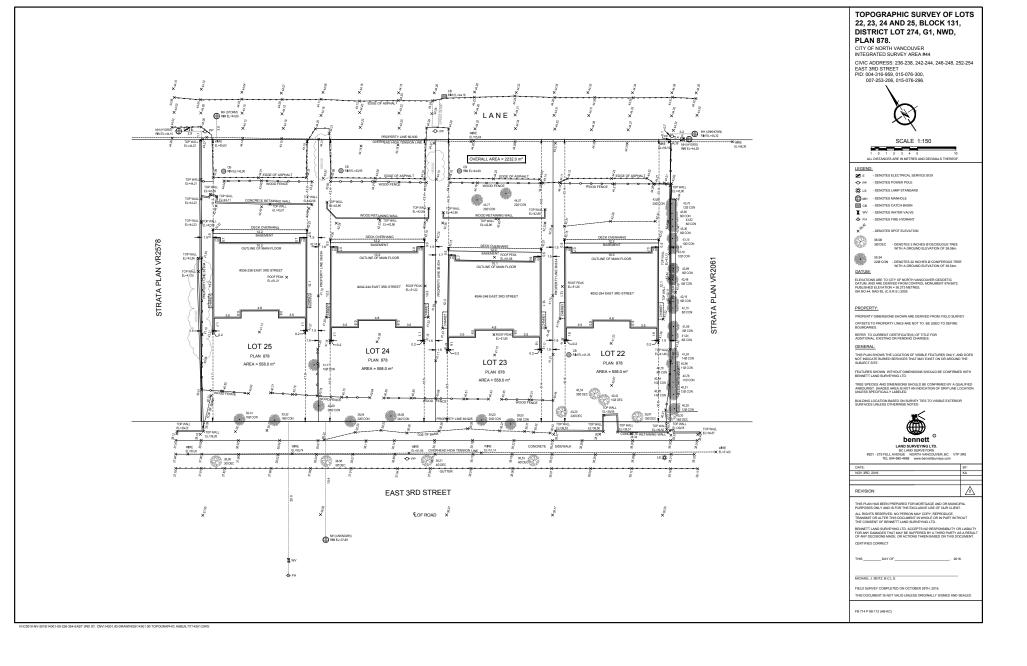

EAST 3RD STREET

LANDSCAPE SET: ISSUED FOR DP OCTOBER 3, 2017

LANDSCAPE DRAWING INDEX

SHEET No.	SHEET NAME
L 0.0	COVER SHEET AND DRAWING LIST
L 1.0	LANDSCAPE LAYOUT - GROUND LEVEL
L 1.1	LANDSCAPE LAYOUT - LEVEL 3
L 1.2	LANDSCAPE LAYOUT - LEVEL 6
L 1.3	LANDSCAPE LAYOUT - ROOF
L 1.4	LANDSCAPE SECTION
L 1.5	LANDSCAPE LIGHTING - GROUND LEVEL
L2.0	PLANT MATERIALS
L2.1	PLANTING PLAN - GROUND LEVEL
L2.2	PLANTING PLAN - LEVEL 3
L2.3	PLANTING PLAN - LEVEL 6
L2.4	PLANTING PLAN - ROOF
L3.0	DETAILS - SOFTSCAPE
L3.1	DETAILS - HARDSCAPE
L3.2	DETAILS - FURNISHINGS

GENERAL NOTES

ALL LANDSCAPE ARCHITECTURAL DRAWINGS IN THIS PACKAGE SHALL BE READ IN CONJUNCTION WITH ALL OTHER LANDSCAPE ARCHITECTURAL DRAWINGS, DETAILS, SPECIFICATIONS, AND OTHER CORRESPONDANCE THAT MAY BE ISSUED DURING THE COURSE OF THE CONTRACT.

IF A DISCREPANCY OCCURS BETWEEN THE DRAWINGS AND THE SPECIFICATIONS OR ANY OTHER DOCUMENT ASSOCIATED WITH THE PROJECT, THE CONFLICT SHALL BE REPORTED IN WRITING TO THE LANDSCAPE ARCHITECT TO OBTAIN CLARIFICATION AND APPROVAL BEFORE PROCEEDING WITH WORKS.

ALL EXISTING INFORMATION IS BASED ON AVAILABLE RECORDS AND SHALL NOT BE CONSTRUED TO BE COMPLETE OR ACCURATE.

ALL PLANTING SHALL BE IN ACCORDANCE WITH BC LANDSCAPE STANDARD, LATEST EDITION.

CONNECT LANDSCAPE ARCHITECTURE INC. DOES NOT GUARANTEE THE EXISTENCE, LOCATION, AND ELEVATION OF UTILITIES OR CONCEALED STRUCTURES AT THE PROJECT SITE.

FINAL SELECTION AND APPROVAL OF ALL STREET TREES TO BE DONE BY THE CITY OF VANCOUVER.





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EAST 3RD STREET

North Vancouver, British Columbia

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LANDSCAPE LAYOUT GROUND

L1.0





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EAST 3RD STREET

North Vancouver, British Columbia

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LANDSCAPE LAYOUT GROUND

L1.0



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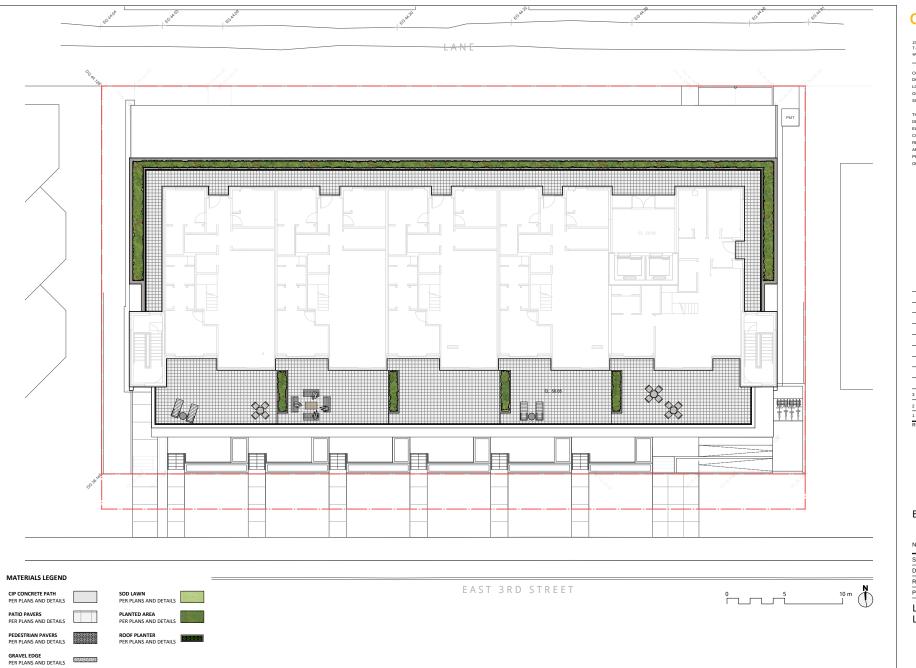
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EAST 3RD STREET

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LANDSCAPE LAYOUT LEVEL 3



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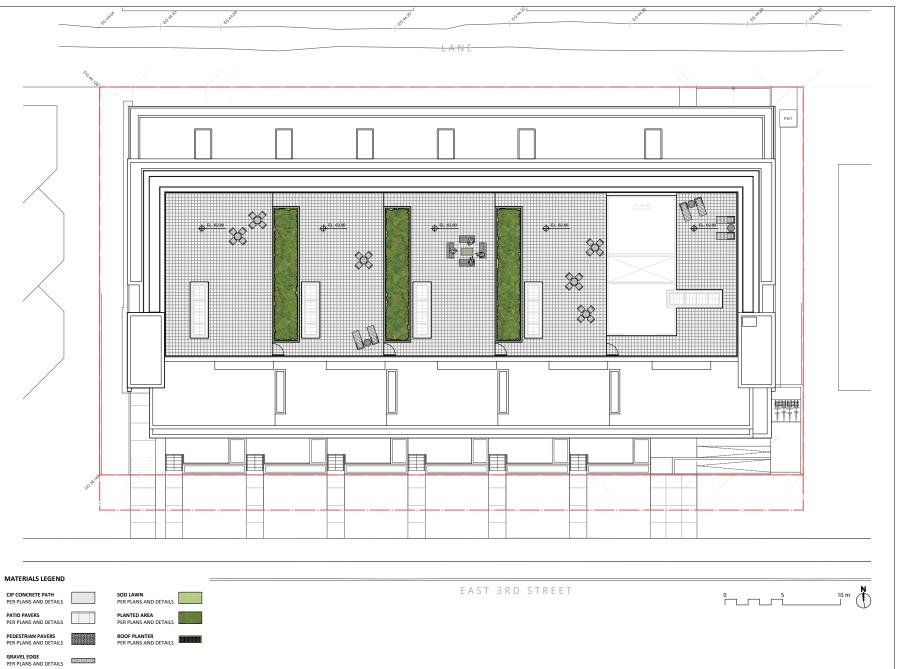
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EAST 3RD STREET

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LANDSCAPE LAYOUT LEVEL 6



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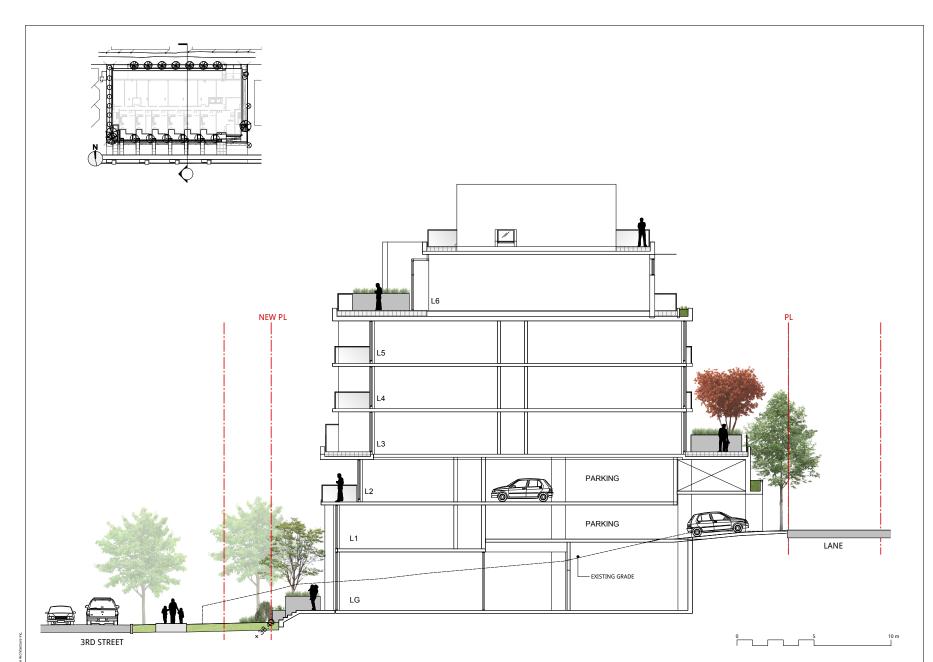
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LANDSCAPE LAYOUT ROOF





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EAST 3RD STREET

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LANDSCAPE SECTION



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EAST 3RD STREET

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LANDSCAPE LIGHTING GROUND







Prunus laurocerasus 'Zabeliana'
Zabel Laurel





Rubus calycinoides Emerald Carpet



LAYERED STREETSCAPE







Hemerocalis fulva Day Lily





Taxus x media 'Hicksii" Hick's Yew

PLANT LIST

	~~~	QTY. TREE	BOTANICAL NAME S	COMMON NAME	SIZE	SPACING
	ر مرکسی	6	Acer palmatum 'Osakazuki'	Japanese Maple	5cm cal., B&B	as shown
		<del>-</del> 7	Fagus sylvatica 'Dawyck'	Purple Beech	5cm cal., B&B	as shown
The state of the s		9	Liquidambar styracifula	Sweet Gum	5cm cal., B&B	as shown
		— 4	Stewartia pseudocamellia	Japanese Stewartia	5cm cal., B&B	as shown
4	{ ו	6	Styrax japonicus	Snowbell Tree	5cm cal., B&B	as shown
( +	+	_	Existing Tree to Remain			
		_	Existing Tree to Remove			
	_`	SHRU	IBS			
	0	116	Cornus sericea 'Kelseyi'	Dwarf Kelsyi Dogwood	#3 pot	24" o.c
	$\odot$	185	Cotoneaster dammeri	Little-Leaf Cotoneaster	#2 pot	24" o.c
	$\bigcirc$	104	Pieris japonica 'Forest Flame'	Lily-of-the-Valley Shrub	#5 pot	36" o.c
	₩	49	Polystichum munitum	Western Sword Fern	#2 pot	24" o.c
	₩	53	Prunus laurocerasus 'Zabeliana'	Zabel Laurel	#2 pot	24" o.c
		66	Rhododendron 'Scarlet Wonder'	Scarlet Rhododendron	#2 pot	24" o.c
	0	132	Spiraea x bumulda 'Goldflame'	Goldflame Spiraea	#3 pot	24" o.c
	<b>⊙</b>	74	Skimmia japonica	Japanese skimmia	#3 pot	24" o.c
	$\boxtimes$	173	Taxus x media 'Hicksii'	Hick's Yew - 1.2m high	#5 pot	24" o.c
		GROL	JND COVERS AND VINES			
	(OX	174	Oxalis oregana	Redwood Spurge	4"(10cm) pot	15" o.c

## O 16 Hemerocallis fulva

PLANTING NOTES

835 Rubus calycinoides

Oxalis oregana

P 20 Parthenocissus quinquefolia

1. PLANTING SHALL BE IN ACCORDANCE WITH BC LANDSCAPESTANDARD, LATEST EDITION. IN CASE OF DISCREPANCY BETWEEN PLANT NUMBERS. THIS LIST AND ON THE PLAN, THE LATTER SHALL PREVAIL.

Redwood Spurge

Virginia Creeper

Emerald Carpet

Day I Ily

4"(10cm) pot 15" o.c

4"(10cm) pot 12" o.c

4"(10cm) pot 18" o.c

4"(10cm) pot

15" o.c

2. ALL PLANTING PLANS TO BE READ IN CONJUNCTION WITH THE LANDSCAPE DETAILS AND SPECIFICATIONS.

235 Pachysandra terminalis (50/50 mix) Japanese spurge

PERENNIALS, BULBS, AND ANNUALS

- 3. CONTRACTOR TO LAYOUT TREES FOR APPROVAL BY THE CONSULTANT AND/OR THE CITY OF COQUITLAM PRIOR TO COMMENCEMENT OF WORK.
- 4. ALL PLANTING BEDS TO BE MULCHED, SMOOTHED, AND RAKED IN ACCORDANCE WITH SPECIFICATIONS.
- 5. ALL UTILITIES ARE TO BE IDENTIFIED AND STAKED OUT BY CONTRACTOR BEFORE CONSTRUCTION. CONFLICTING UTILITIES TO BE PROTECTED BY CONTRACTOR PRIOR TO PLANTING.
- 6. ALL EXISTING TREES TO BE PROTECTED PER DRAWINGS AND CITY OF NORTH VANCOUVER REQUIREMENTS.
- 7. DAMAGE TO EXISTING VEGETATION TO BE REPLACED AND REPAIRED.
- 8. ALL PLANTING IS TO BE COMPLETED IN SUCH A MANNER AS TO PREVENT THE RELEASE OF SILT, SEDIMENT, OR SEDIMENT LADEN WATER, OR ANY OTHER DELETERIOUS SUBSTANCES INTO ANY STREET OR STORM SEWER.
- 9. ALL PLANTING BEDS TO BE MULCHED WITH 2" (50MM) OF ANSWER GARDEN PRODUCTS 'HUMUS BUILDER' OR APPROVED EQUAL. 10. ALL AREAS NOT INDICATED AS PLANTED OR HARDSCAPE (INCLUDING UNIT PAVING, GRAVEL, CONCRETE, AND ASPHALT) TO BE



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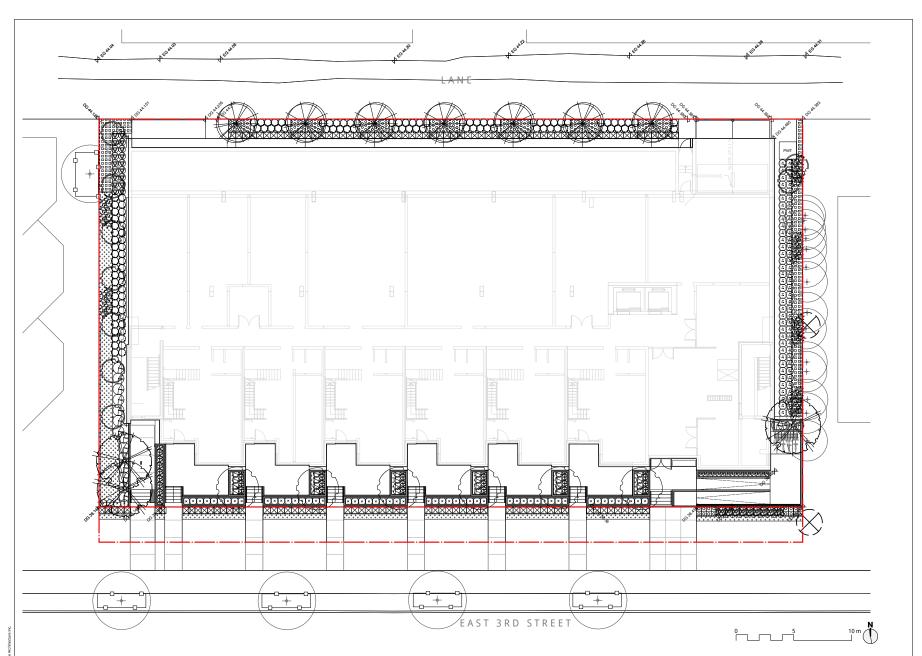
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#### **EAST 3RD STREET**

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PLANT MATERIALS



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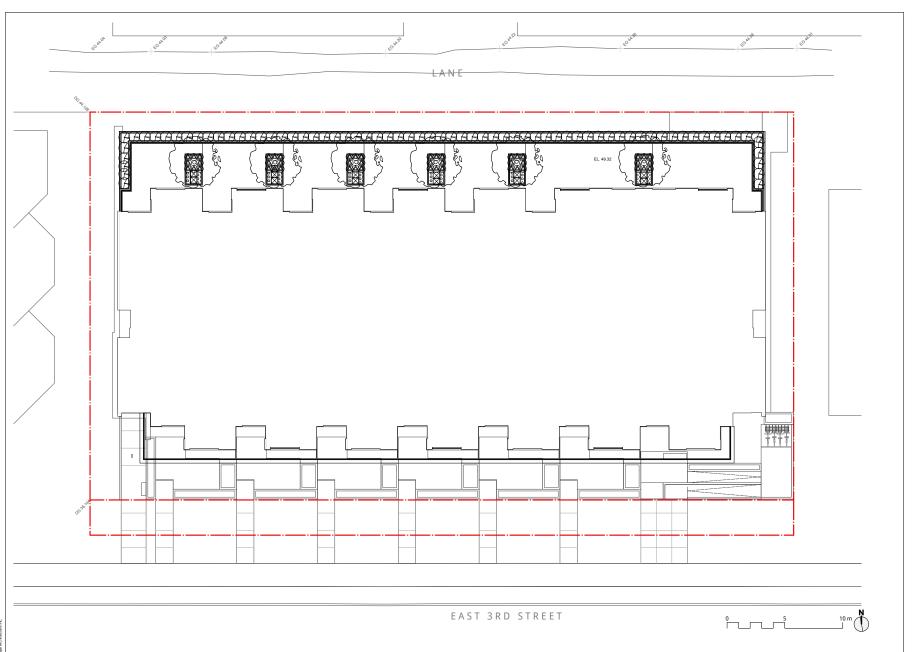
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#### EAST 3RD STREET

North Vancouver, British Columbia

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#### PLANTING PLAN GROUND



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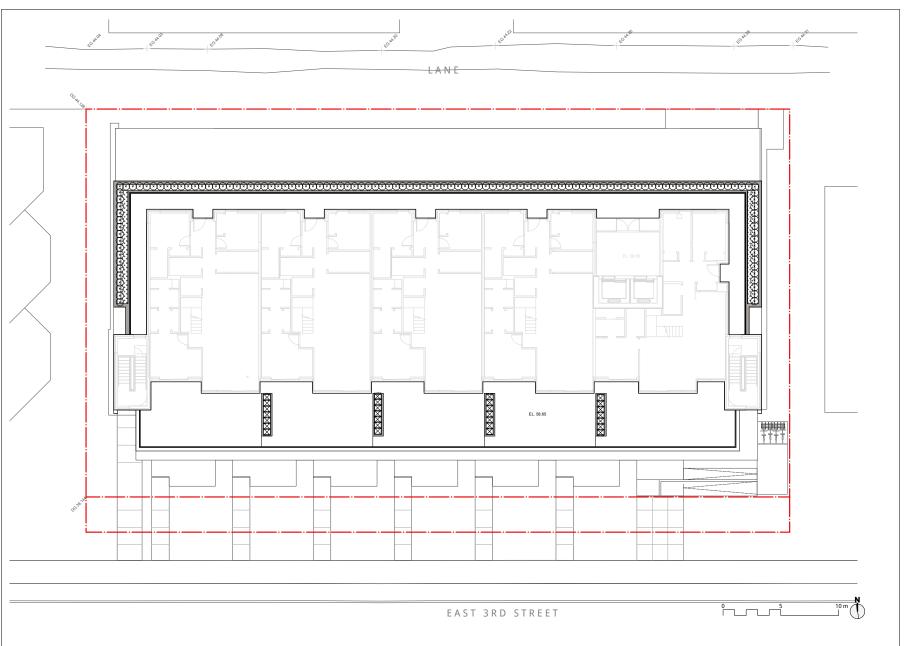
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#### EAST 3RD STREET

North Vancouver, British Columbia

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PLANTING PLAN LEVEL 3



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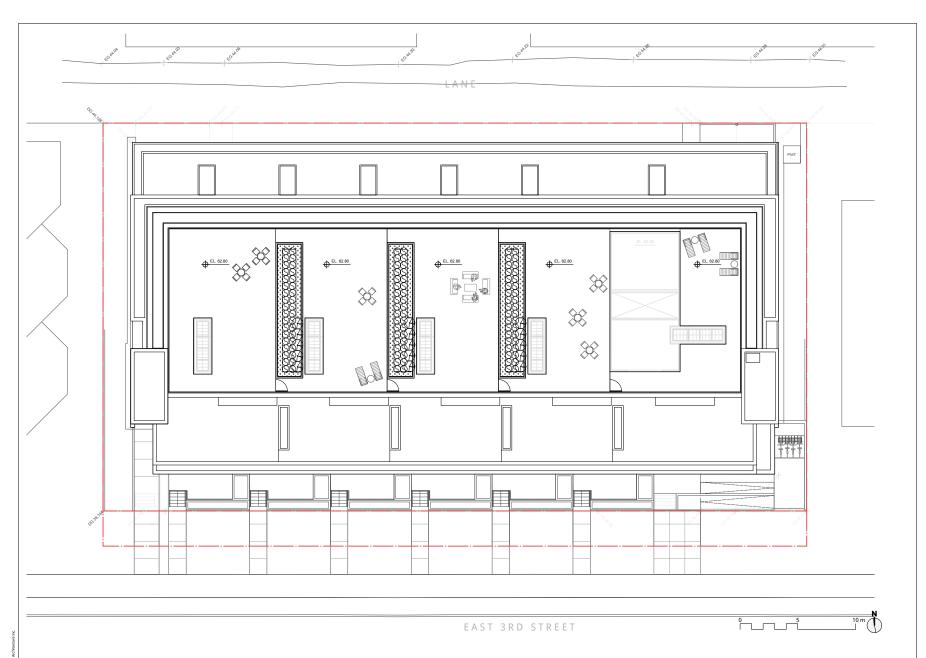
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#### EAST 3RD STREET

North Vancouver, British Columbia

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PLANTING PLAN LEVEL 6



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SITE

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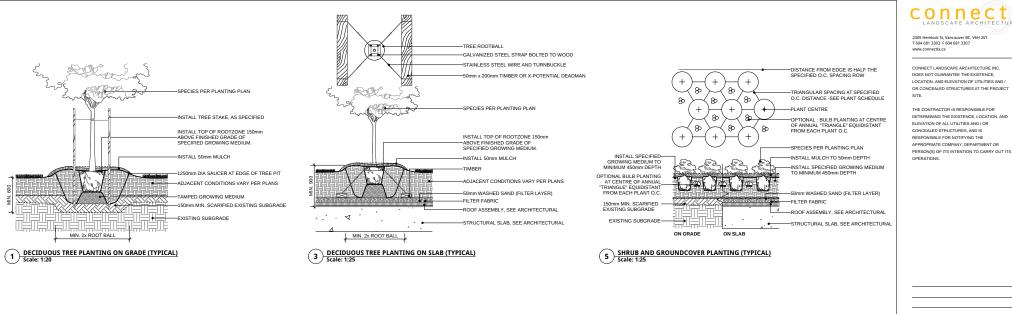
3 REISSUED FOR DP 17-10-03
2 REISSUED FOR DP 17-08-25
1 ISSUED FOR DP 17-05-17
REVISIONS

#### EAST 3RD STREET

North Vancouver, British Columbia

Scale:	1:100
Drawn:	KE
Reviewed:	DS
Project No.	06-527

#### PLANTING PLAN ROOF



SOD AS PER SPECIFICATIONS

250mm DEPTH, AS SPECIFIED

-FILTER FABRIC

SAND BASED GROWING MEDIUM TO

50mm WASHED SAND (FILTER LAYER)

-ROOF ASSEMBLY, SEE ARCHITECTURAL

STRUCTURAL SLAB, SEE ARCHITECTURAL

17-08-25 REISSUED FOR DP ISSUED EOD DD 17-05-17 REVISIONS


**EAST 3RD STREET** 


North Vancouver, British Columbia

Scale:	AS SHOWN
Drawn:	KD
Reviewed:	DS
Project No.	06-527

LANDSCAPE DETAILS SOFTSCAPE

L3.0

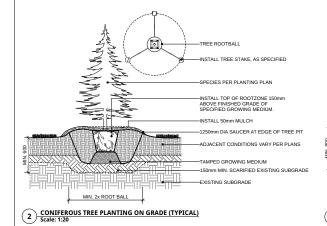

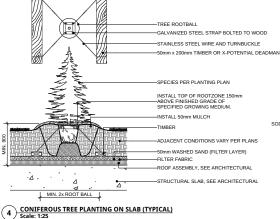


EXISTING SUBGRADE-6 SOD LAWN (TYPICAL)
Scale: 1:10

SOD AS PER SPECIFICATIONS

SAND BASED GROWING

MEDIUM TO 100mm DEPTH, AS SPECIFIED

POSITIVE DRAINAGE

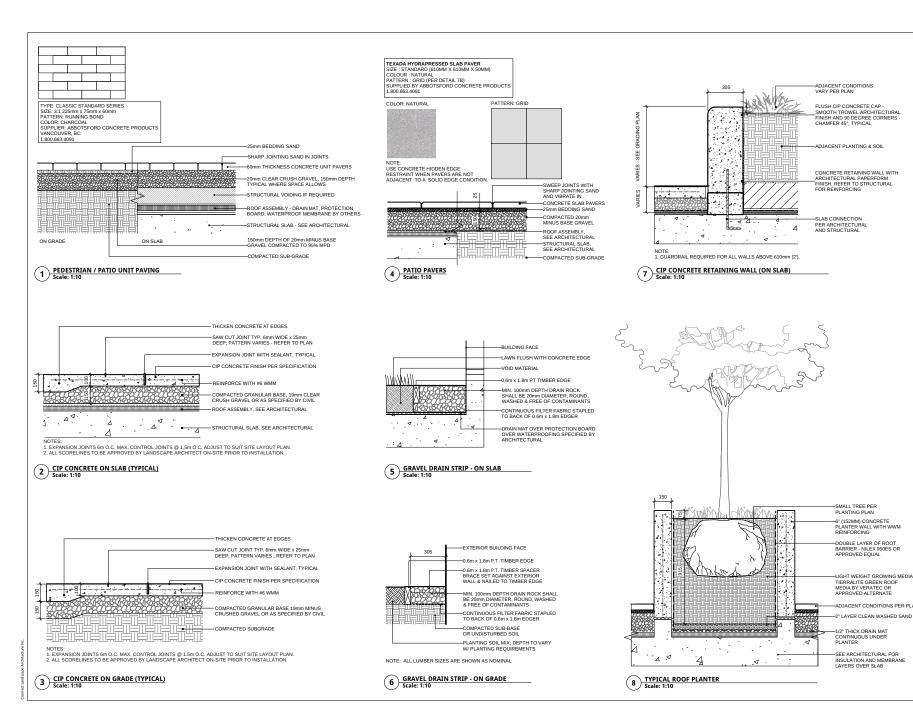

2305 Hemlock St, Vancouver BC, V6H 2V T 604 681 3303 F 604 681 3307 www.connectla.ca

CONNECT LANDSCAPE ARCHITECTURE INC. DOES NOT GUARANTEE THE EXISTENCE, LOCATION, AND ELEVATION OF UTILITIES AND OR CONCEALED STRUCTURES AT THE PROJECT SITE

THE CONTRACTOR IS RESPONSIBLE FOR DETERMINING THE EXISTENCE, LOCATION, AND FLEVATION OF ALL LITILITIES AND / OR CONCEALED STRUCTURES, AND IS RESPONSIBLE FOR NOTIFYING THE APPROPRIATE COMPANY, DEPARTMENT OR PERSON(S) OF ITS INTENTION TO CARRY OUT ITS OPERATIONS.

17-10-03

17-08-25

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3 REISSUED FOR DP

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REVISIONS

LIGHT WEIGHT GROWING MEDIA

ADJACENT CONDITIONS PER PLAN


1/2" THICK DRAIN MAT

#### **EAST 3RD STREET**

North Vancouver, British Columbia

Scale:	AS SHOWN
Drawn:	KD
Reviewed:	DS
Project No.	06-527

#### LANDCAPE DETAILS HARDSCAPE

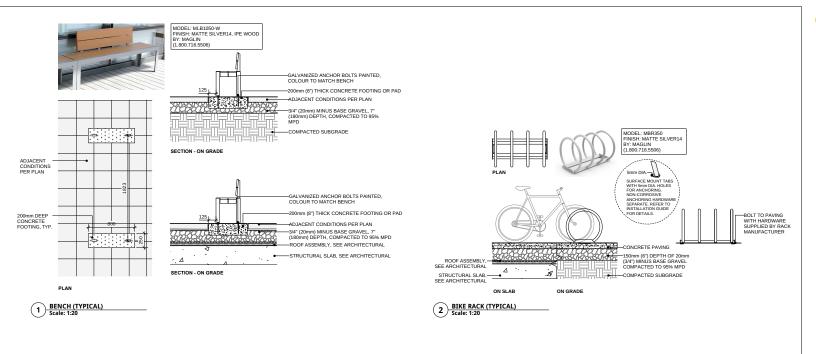

connect
LANDSCAPE ARCHITECTURE

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CONNECT LANDSCAPE ARCHITECTURE INC.
DOES NOT GUARANTEE THE EXISTENCE,
LOCATION, AND ELEVATION OF UTILITIES AND /
OR CONCEALED STRUCTURES AT THE PROJECT
SITE

THE CONTRACTOR IS RESPONSIBLE FOR DETERMINING THE EXISTENCE, LOCATION, AND ELEVATION OF ALL UTILITIES AND / OR CONCEALED STRUCTURES, AND IS RESPONSIBLE FOR NOTIFYING THE APPROPRIATE COMPANY, DEPARTMENT OR PERSON(S) OF ITS INTENTION TO CARRY OUT ITS OPERATION.

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1	ISSUED FOR DP	17-05-17

#### EAST 3RD STREET

REVISIONS

North Vancouver, British Columbia

Scale:	AS SHOWN
Drawn:	KD
Reviewed:	DS
Project No.	06-527

### LANDCAPE DETAILS FURNISHINGS

L3.2



Civil Engineers & Project Managers
#610 EAST TOWER - 221 ESPLANADE WEST, NORTH VANCOUVER BC, V7M3J3
Phi: 604.087, 0070


PROJECT:

# 236-248 EAST 3RD ST. CITY OF NORTH VANCOUVER, BC


CLIENT:


# INNOVISION DEVELOPMENT CORP.


	Drawing List	
Dwg No.		
BG-1	BUILDING GRADES	5696U
SERV-1	SERVICING PLAN	%%U
SMP-1	STORM WATER MANAGEMENT	50%0

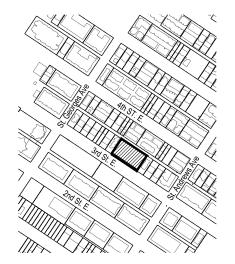

2017-10-04 REISSUED FOR DP

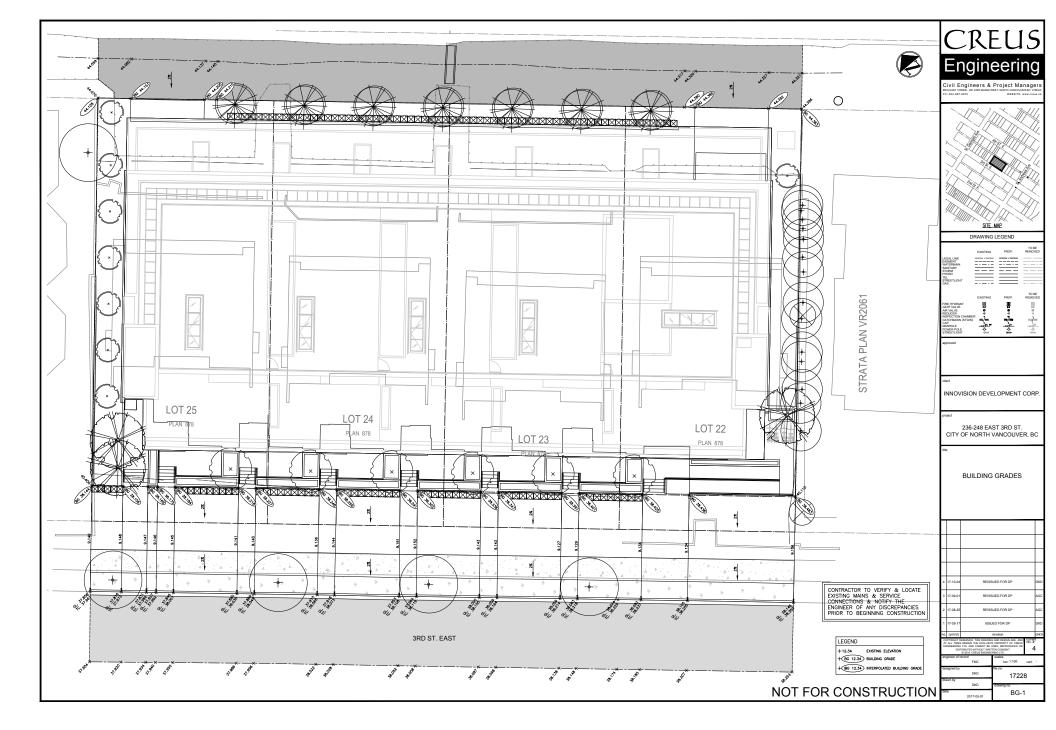

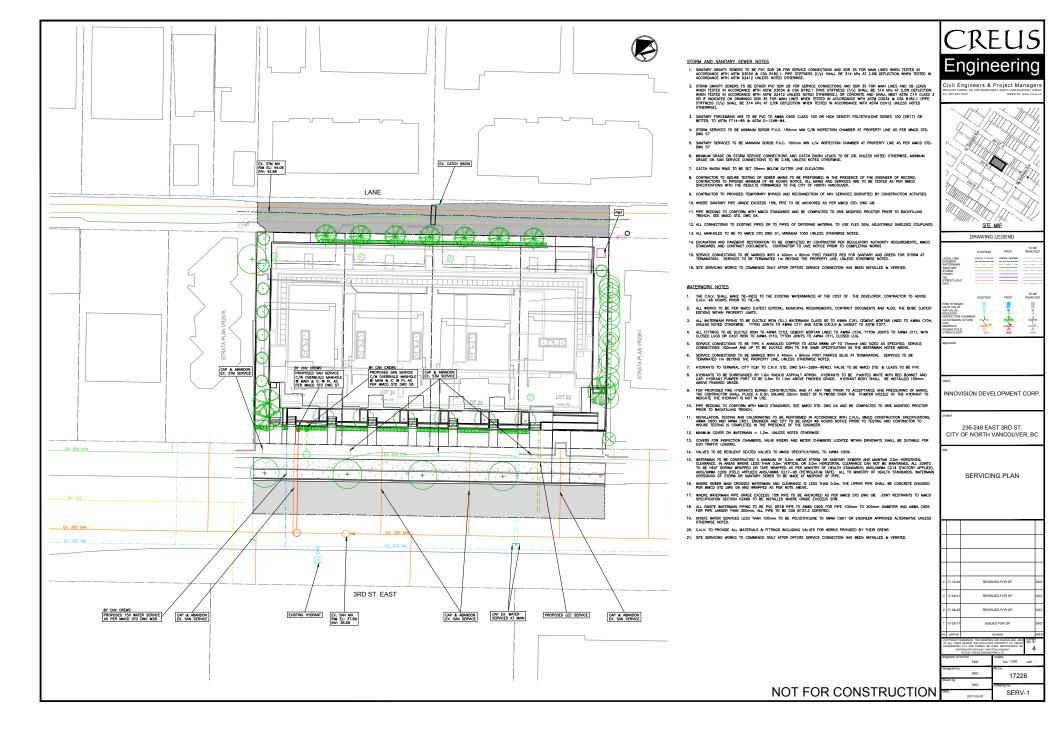

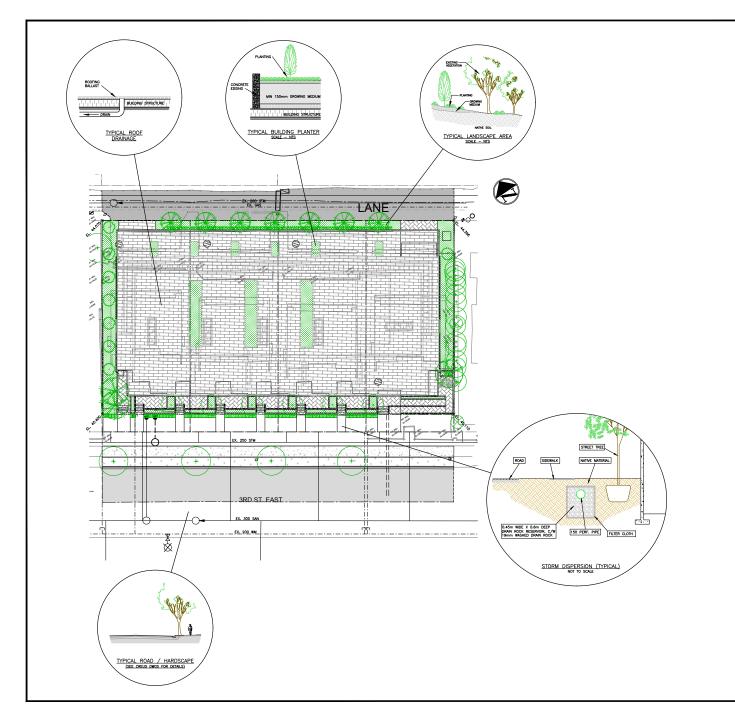

Engineering

Civil Engineers & Project Managers

S: TE GRADES

SITE GRADES SHOWN FOR REFERENCE ONLY.
DETAILED SITE GRADING BY OTHERS
 SITE DRAINAGE SHOWN RELIES TO STORMWAI
MANAGEMENT ONLY. CONTRACTOR TO ENSURE
ADEQUATE DRAINAGE PROVIDED.

ADEQUATE DRAINAGE PROVIDED.

3. ALL WORKS TO CONFORM TO CURRENT MUNICIPAL AND BC BUILDING & PLUMBING CODE REQUIREMENTS.

4. INFILTRATION TRENCH LOCATIONS AND EXTENTS TO BE COORDINATED IN FIELD WITH ENGINEER.



CONTRACTOR TO VERIFY & LOCATE
EXISTING MAINS & SERVICE
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ENCINEER OF ANY DISCREPANCIES
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