# 401 WEST 16th STREET

# Design Rationale

#### Background

This application is in support of a rezoning application located at 401 West 16th Steet, currently zoned RS-1, to a Comprehensive Development Designation to allow for the construction of a new three unit residential building. The site is a rectangular shape, approximately 8,403.4 square feet (780.68 square metres) in area. It is 60' wide and 140' deep with a gradual grade fall from the north east to south west loot corner. The lot topography is consistent through the entire neighborhood. The lot currently accomodates a single family residence. This proposal is consistent with The City of North Vancouver's housing strategy and the current OCP designation of the site is R-2 allowing for a range of ground oriented housing, located in areas between detached and more intense residential or mixed use areas in the form of duplexes with suites, triplexes and row houses, the adjacent property to the east is zoned RT-1 with a built duplex and to the west is zoned CD with a built triplex. The site is within walking distance to schools, shops and services on Lonsdale and a wide range of recreational facilities. The site is located on the southern edge of the newly renovated Mahon Park and track, Pickle Ball Courts, open park and trails. It is a short walk to the Police Station and Lions Gate Hospital and major transportation services making the entire lower mainland accessable without the need of a car.

#### Development Strategy

The owner of the property envisions the development of a Trilplex built on a basement and a detached garage. Building three units as opposed to one creates a more affordable building form for young families by distributing the highest building cost, land, between three units. This proposal is a Contemporary design intended to add to the character of an already diverse streetscape.

The building design is a direct response to existing site conditions and orientation. The building shape and massing are intended to reduce the exterior envelope area and building energy intensity while allowing for daylight and ventilation needs. Each unit features livable floor plans and private outdoor living spaces. All units have robust main entrances that are visible from the street. All unit identification and ownership are well defined while providing ample opportunity for social interaction between units at the front and back yards. A three car garage and three additional on grade parking stalls provide ample parking for residents and guests and accessable from the lane.

#### Open Space

Open space is perhaps the greatest challenge in site devleopment, providibng a clear definition between public and private spaces. Unit 409 has its dedicated open space off of West 16th Street. We have that private space with fencing and landscaping. The front yard dedication is maximized by capturing an optimal area while retaining an open space for access to the two rear units 407 and 411. Unit access is complicated on the north east corner by the need to access parking by both units 407 and 409. In an effort to reduce the volume of hard surfaces, access from the 16th Street sidewalk is offset from ht ewestrly crossing to allow for the space to be broken up with landscaping.

#### Crime Prevention

OPTED issues are addessed by a clearly defined deliniation between private and public spaces. Landscaping is low and there are no conceled corners in our building design that could otherwise offer spaces for intruders. Landscape lighting and open spaces facilitate easy monitoring of areas surrounding the building.

#### Sustainable Building Strategy

The overall sustainable strategy that will be integrated in the design process and decisions are as follows

#### Sustainable Site

Sedimentation control environmental strategies will be employed during construction

Implimentation of alternative transportation strategy by being adjacent to major transportation and cycling routes. Garages have ample area for bicycle storage.

Use of permeable surfaces in parking areas.

Landscaping and civil designs optimize storm water management

#### Water Efficiency

High performance/efficient plumbing features including low-flow toilets, showers and faucets.

Drought toloerant landscaping

#### Energy Efficiency

Solar heated water potential is provided Abundance of natural light with large windows

Energy star appliances

Energy efficient LED lighting throughout the project

Energy modelling to assess and verify energy performance and to mkeet Step Code standards

Heat recovery ventilation system

In floor radian floor heating

#### Material and Resource & Durable Construction

Rain screen envelope design with environmentally freindly materials that provide more sustainable development will be used such as fiber cement panels (durable, rot resistant with recycled content and fly ash concrete) and locally sourced Engineered Edge Glued Solid Wood Panel (ex. Silva Panel)

#### Passive Design Strategy

High performane windows (Arbgo filled with low-e film)

Maximizing window area on the south elevation to increase solar gain in th ewinter while reducing solar gain in summer due to generous roof overhangs

Minimizing window area on the eat and west building faces to reduce unneccesary SHG in th esummer and to reduce heat loss in the winter.

Air and moisture tight building enevelope design

Mixed mode ventilation using HRV during the winter only and passive ventilation using operable windows to allow control over indoor thermal comfort and cross ventilation



# Drawing Index

Foundation/Below-Grade Walls & Slabs Slabs (Construction - Effects Politics) | Wall: 8" concrete, 2x4 @ 16" o/c R-14 Batt - effective R-21.34 | Slab : 3" R-12 FPS (Tvne II) rinid fnam Slab : Below RT 1 above Prost Line AND Heated OR Unheated Windows, Doors & Skylights | Windows: double-glazed, low-e coating, argon gas fill, vinyl frame | Doors: fiberglass-insulated core; USI 1.4 SHGC 0.25 (USI 2.4 for skylight Space Conditioning (System Type, Fast Source, Performance Rating)

AFUE

Natural gas condensing boiler with in-floor radiant heating 95% AFUE Ventilation (Design basis according to Section 9.29) Heat recovery ventilator with 65% SRE @ 0 degrees C, 60 cfm min. Hot Water Heating (System Type, Fael Source, Performance Plating) Air Barrier System & Location 6mm interior poly vapour barrier Other Energy Impacting Features | Exposed Floor (cantilevered): Floor joist as per structural R-28 Batt - effective R-28.84

Exterior Walls (Construction + Effective R-Value) Cladding, rainscreen, 2x6 @ 16" o/c R-24 Batt - effective R-19.64

ENERGY EFFICIENCY
COMPLIANCE DOCUMENTATION
CONTROL VANCOUVER
VANCOUVER
West vancouver
VANCOUVER
West vancouver HOUSE PERFORMANCE REPORT (PRE-CONSTRUCTION) Instructions 1. Effective December 12, 2019
2. To be submitted at the time of Building Permit application, accompanied with supporting documentation

Building Type: ☐ Coach House ☐ Single-family ☐ Duplex ■ Rowhouse/Townhome ☐ Apartment <4 storeys ☐ Other ■ 9.36.6 (Energy Step Cools) - Step Pursued: 3 (SECTION A+C) loor Area of Conditioned Space: 168.13 \_\_\_m² [\_\_\_\_\_\_ uilding Height: 2 storeys Rezoning, and/or DP Commitment Required Performance Metric: Building Permit #: Required Permit #: Based on drawings dated 09/24/2020

Exterior Walls (Construction + Effective R-Value) Cladding, rainscreen, 2x6 @ 16" o/c R-24 Batt - effective R-19.64 Roof/Attic (Construction + Effective R-Value)

Roof joiet as per etructural, R-28 Batt - effective R-24.75 Foundation/Below-Grade Walls & Wall: 8" concrete, 2" XPS, 2x4 @ 16" o/c R-14 Batt - effective R-31 34: Slabs Slabs (Construction + Efficient Pollute) Slab Is: Below R0 I Above Frost Line Alph Belated OR □ Unheated Windows, Doors & Skylights (Tipe+Ownal U-Value) Windows: double-glazed, low-e coating, argon gas fill, vinyl frame Doors: fiberglass-insulated core; USI 1.4 SHGC 0.25 (USI 2.4 for skyligh Space Conditioning (System Type, Fast Source, Performance Rating)

Natural gas condensing boiler with in-floor radiant heating 95% AFUE Ventitation (Design basis according to Stockers 12) Heat recovery ventillator with 65% SRE @ 0 degrees C, 60 cfm min. Air Barrier System & Location 6mm interior polyvapour barrier

Other Energy Impacting Features | Exposed Floor (cantilevered): Floor joist as per structural R-28 Batt -

ENERGY EFFICIENCY
COMPLIANCE DOCUMENTATION
ONDER THE VANCOUVER West Vancouver
VANCOUVER West Vancouver

for 9.36.5 or 9.36.6 (Energy Step Code) Energy Performance Compliance
Last updated March 10, 2020

Building Type: ☐ Coach House ☐ Single-family ☐ Duplex ■ Rowhouse/Townhome ☐ Apartment <4 storeys ☐ Othe ■ 9.36.6 (Energy Step Code) - Step Pursued: 3 (SECTION A+C) floor Area of Conditioned Space: 192.36 \_\_m² Building Height: 2 storeys Rezoning, and/or DP Commitment Required Performance Metric:

Based on drawings dated 09/24/2020 Exterior Walls (Construction + Effective R-Natural) Cladding, rainscreen, 2x6 @ 16" o/c R-24 Batt - effective R-19.64 Roof/Attic (Construction + Effective R-Value) Roof joist as per structural, R-28 Batt - effective R-24.75

Windows, Doors & Skylights
(Type+Overal U-Value)
Windows: double-glazed, low-e coating, argon gas fill, vinyl frame
Doors: fiberglass-insulated core; USI 1.4 SHGC 0.25 (USI 2.4 for skylight) Space Conditioning (System Type, Faid Source, Performance Palling)

Natural gas condensing boiler with in-floor radiant heating 95% AFUE

Ventilation (Design basis according to Section 9.29) Heat recovery ventilator with 65% SRE @ 0 degrees C, 75 cfm min. Hot Water Healing (System Type, Fast Source, Performance Rising)

Combo with boiler (50 US gal. indirect-fired storage tank)

Other Energy Impacting Features [Dissign basis] Exposed Floor (cantilevered): Floor joist as per structural R-28 Batt - effective R-28.84

# 401 WEST 16th STREET

Sheet	Drawing Title
1	Title Sheet
2	Context
3	Site Plan
4	Main Floor Plan
5	Lower Floor Plan
6	Upper Floor Plan
7	Garage Plans
8	Elevations
9	Elevations
10	Colour Elevations
11	Colour Elevations
12	Sections
13	Sections
14	Renderings
15	Shyadows
16	Reflected Windows
17	Civil, Erosion and Sediment Control
18	Civil, Grades
19	Civil. Services
20	Civil, Storm Water Management
21	Landscape Plan
	G

Survey

SITE DEVELOPMENT DATA

LEGAL DESCRIPTION

BLOCK DISTRICT LOT 547

EXISTING ZONE PROPOSED ZONING:

LOT AREA: 8,409.0 SQUARE FEET

SITE COVERAGE

PERMITTED: 2,943.15 SQUARE FEET (35%) |PROPOSED : 2,889.07 SQUARE FEET (34.4%)

FLOOR SPACE RATIO :

PERMITTED: 4,204.5 SQUARE FEET (50%) PROPOSED : 4,198.00 SQUARE FEET (50%)

GARAGE:

AREA ALLOWED: 840 SQUARE FEET AREA PROPOSED : 104,9 SQUARE FEET

PARKING: REQUIRED : 5 STALLS PROVIDED : 6 STALLS

ELEYATIONS:

ROOF RIDGE	240.32
#409 TOP OF UPPER FL. WALL	238.66
#407 & 411 TOP OF UPPER WALL	236.82
#409 UPPER FLOOR #401 & 411 UPPER FLOOR	228.66
#401 & 411 UPPER FLOOR	227.74
MAIN FLOOR	217.53
LOWER FLOOR	207.32

GARAGE:

ROOF RIDGE	
TOP OF WALL	
TOP OF SLAB	210.7

-THE GENERAL CONTRACTOR SHALL VERIFY ALL DIMENSIONS AND CONDITIONS PRIOR TO COMMENCING ANY WORK AND REPORT ANY DESCREPANCIES TO THE DESIGNER. -THE DESIGNER WILL NOT BE RESPONSABLE FOR COSTS INCURRED TO THE OWNER OR CONTRACTOR THROUGH ERRORS OR OMISSIONS ON PLANS OR SPECIFICATIONS AFTER THE BUILDING PERMIT HAS BEEN ISSUED -THESE PLANS AND CONCEPTS ARE PROTECTED BY COPYRIGHT AND MAY NOT BE REPRODUCED IN WHOLE OR IN PART WITHOUT THE WRITTEN CONSENT OF THE DESIGNER, THESE PLANS ARE THE PROPERTY OF THE DESIGNER AND NO PLAN OR PART THEREOF SHALL BE COPIED DISCLOSED TO OTHERS OR USED FOR ANY OTHER PROJECT WITHOUT THE WRITTEN CONSENT OF THE DESIGNER YISUAL CONTACT WITH THESE DRAWINGS SHALL CONSTITUTE CONCLUSIVE

#### Phone 604-986-4550 Fax 604-986-4555 billcurtisdesign@gmail.com **Harbourfront Business Centre** 5th Floor, 224 West Esplanade

North Vancouver, BC V7M 3M6

Design Ltd.

consultants

INSPIRATION DESIGN

October 27, 2020 Issued for Rezoning Application





TITLE SHEET

Drawn By B.C. Date MARCH 2020

Project





SOUTH SIDE OF WEST 16th



NORTH SIDE OF WEST 16th



WEST 16th looking WEST



INSPIRATION DESIGN



LANE looking EAST




NORTH SIDE OF LANE




SOUTH SIDE OF LANE




LANE looking WEST

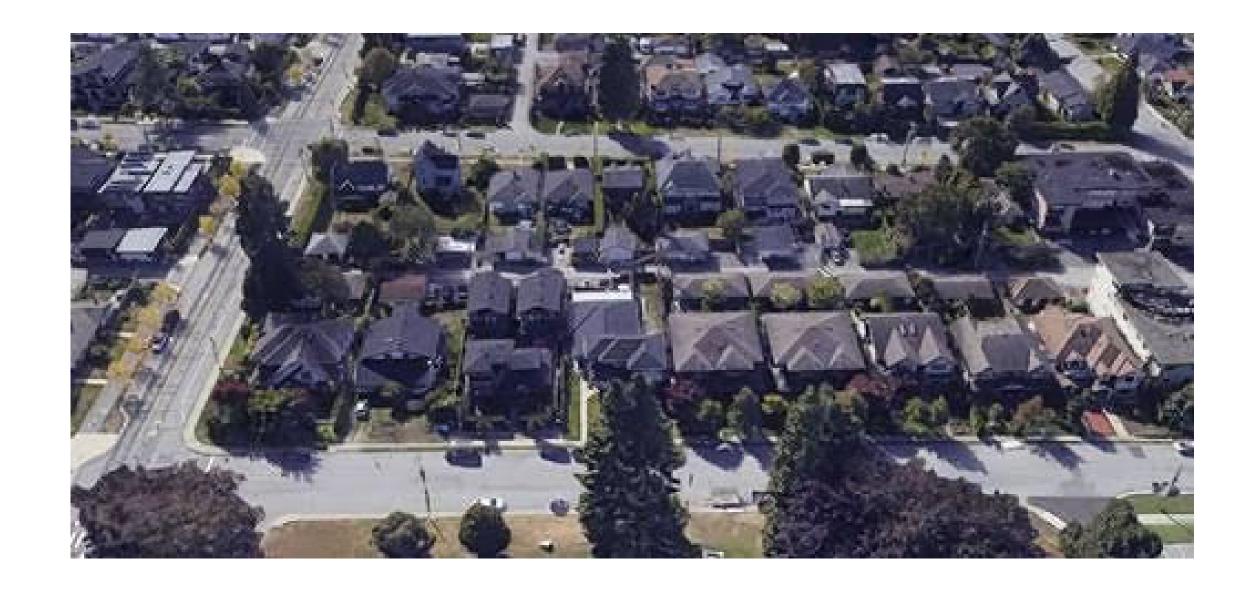

BIRDS EYE VIEW LOOKING SOUTH

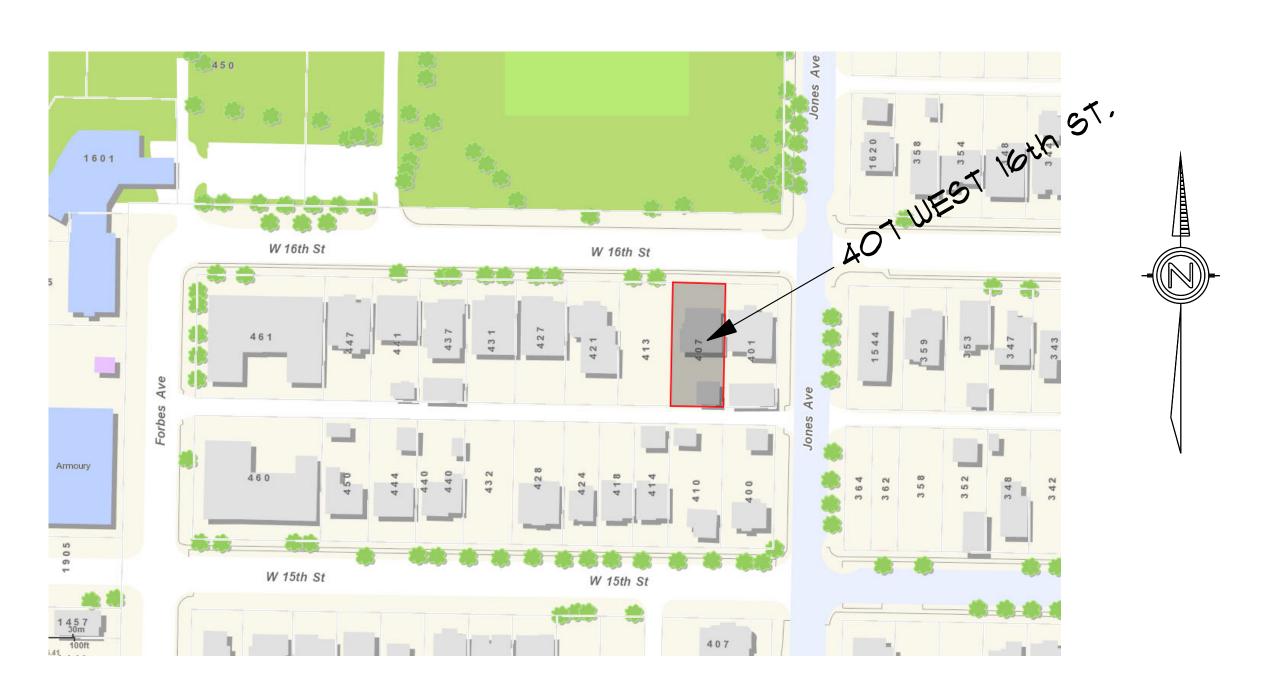

CONTEXT PLAN

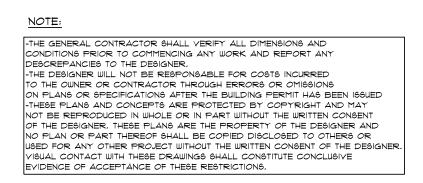



CONTEXT

Drawn By B.C. Date MARCH 2020

401 WEST 16th STREET of NORTH YANCOUYER









WEST 16th looking WEST



WEST 16th looking EAST

SOUTH SIDE OF WEST 16th



LANE looking WEST



LANE looking EAST

NORTH SIDE OF LANE

SOUTH SIDE OF LANE



Drawn By B.C. Date MARCH 2020


THE GENERAL CONTRACTOR SHALL VERIFY ALL DIMENSIONS AND CONDITIONS PRIOR TO COMMENCING ANY WORK AND REPORT ANY DESCREPANCIES TO THE DESIGNER.

"THE DESIGNER WILL NOT BE RESPONSABLE FOR COSTS INCURRED TO THE OWNER OR CONTRACTOR THROUGH ERRORS OR OMISSIONS ON PLANS OR SPECIFICATIONS AFTER THE BUILDING PERMIT HAS BEEN ISSUED THESE PLANS AND CONCEPTS ARE PROTECTED BY COPYRIGHT AND MAY NOT BE RESPONDED. NOT BE REPRODUCED IN WHOLE OR IN PART WITHOUT THE WRITTEN CONSENT OF THE DESIGNER, THESE PLANS ARE THE PROPERTY OF THE DESIGNER AND OF THE DESIGNER, THESE PLANS ARE THE PROPERTY OF THE DESIGNER AND NO PLAN OR PART THEREOF SHALL BE COPIED DISCLOSED TO OTHERS OR USED FOR ANY OTHER PROJECT WITHOUT THE WRITTEN CONSENT OF THE DESIGNER, VISUAL CONTACT WITH THESE DRAWINGS SHALL CONSTITUTE CONCLUSIVE EVIDENCE OF ACCEPTANCE OF THESE RESTRICTIONS,

401 WEST 16th STREET NORTH VANCOUVER

CONTEXT

# WEST 16th STREET

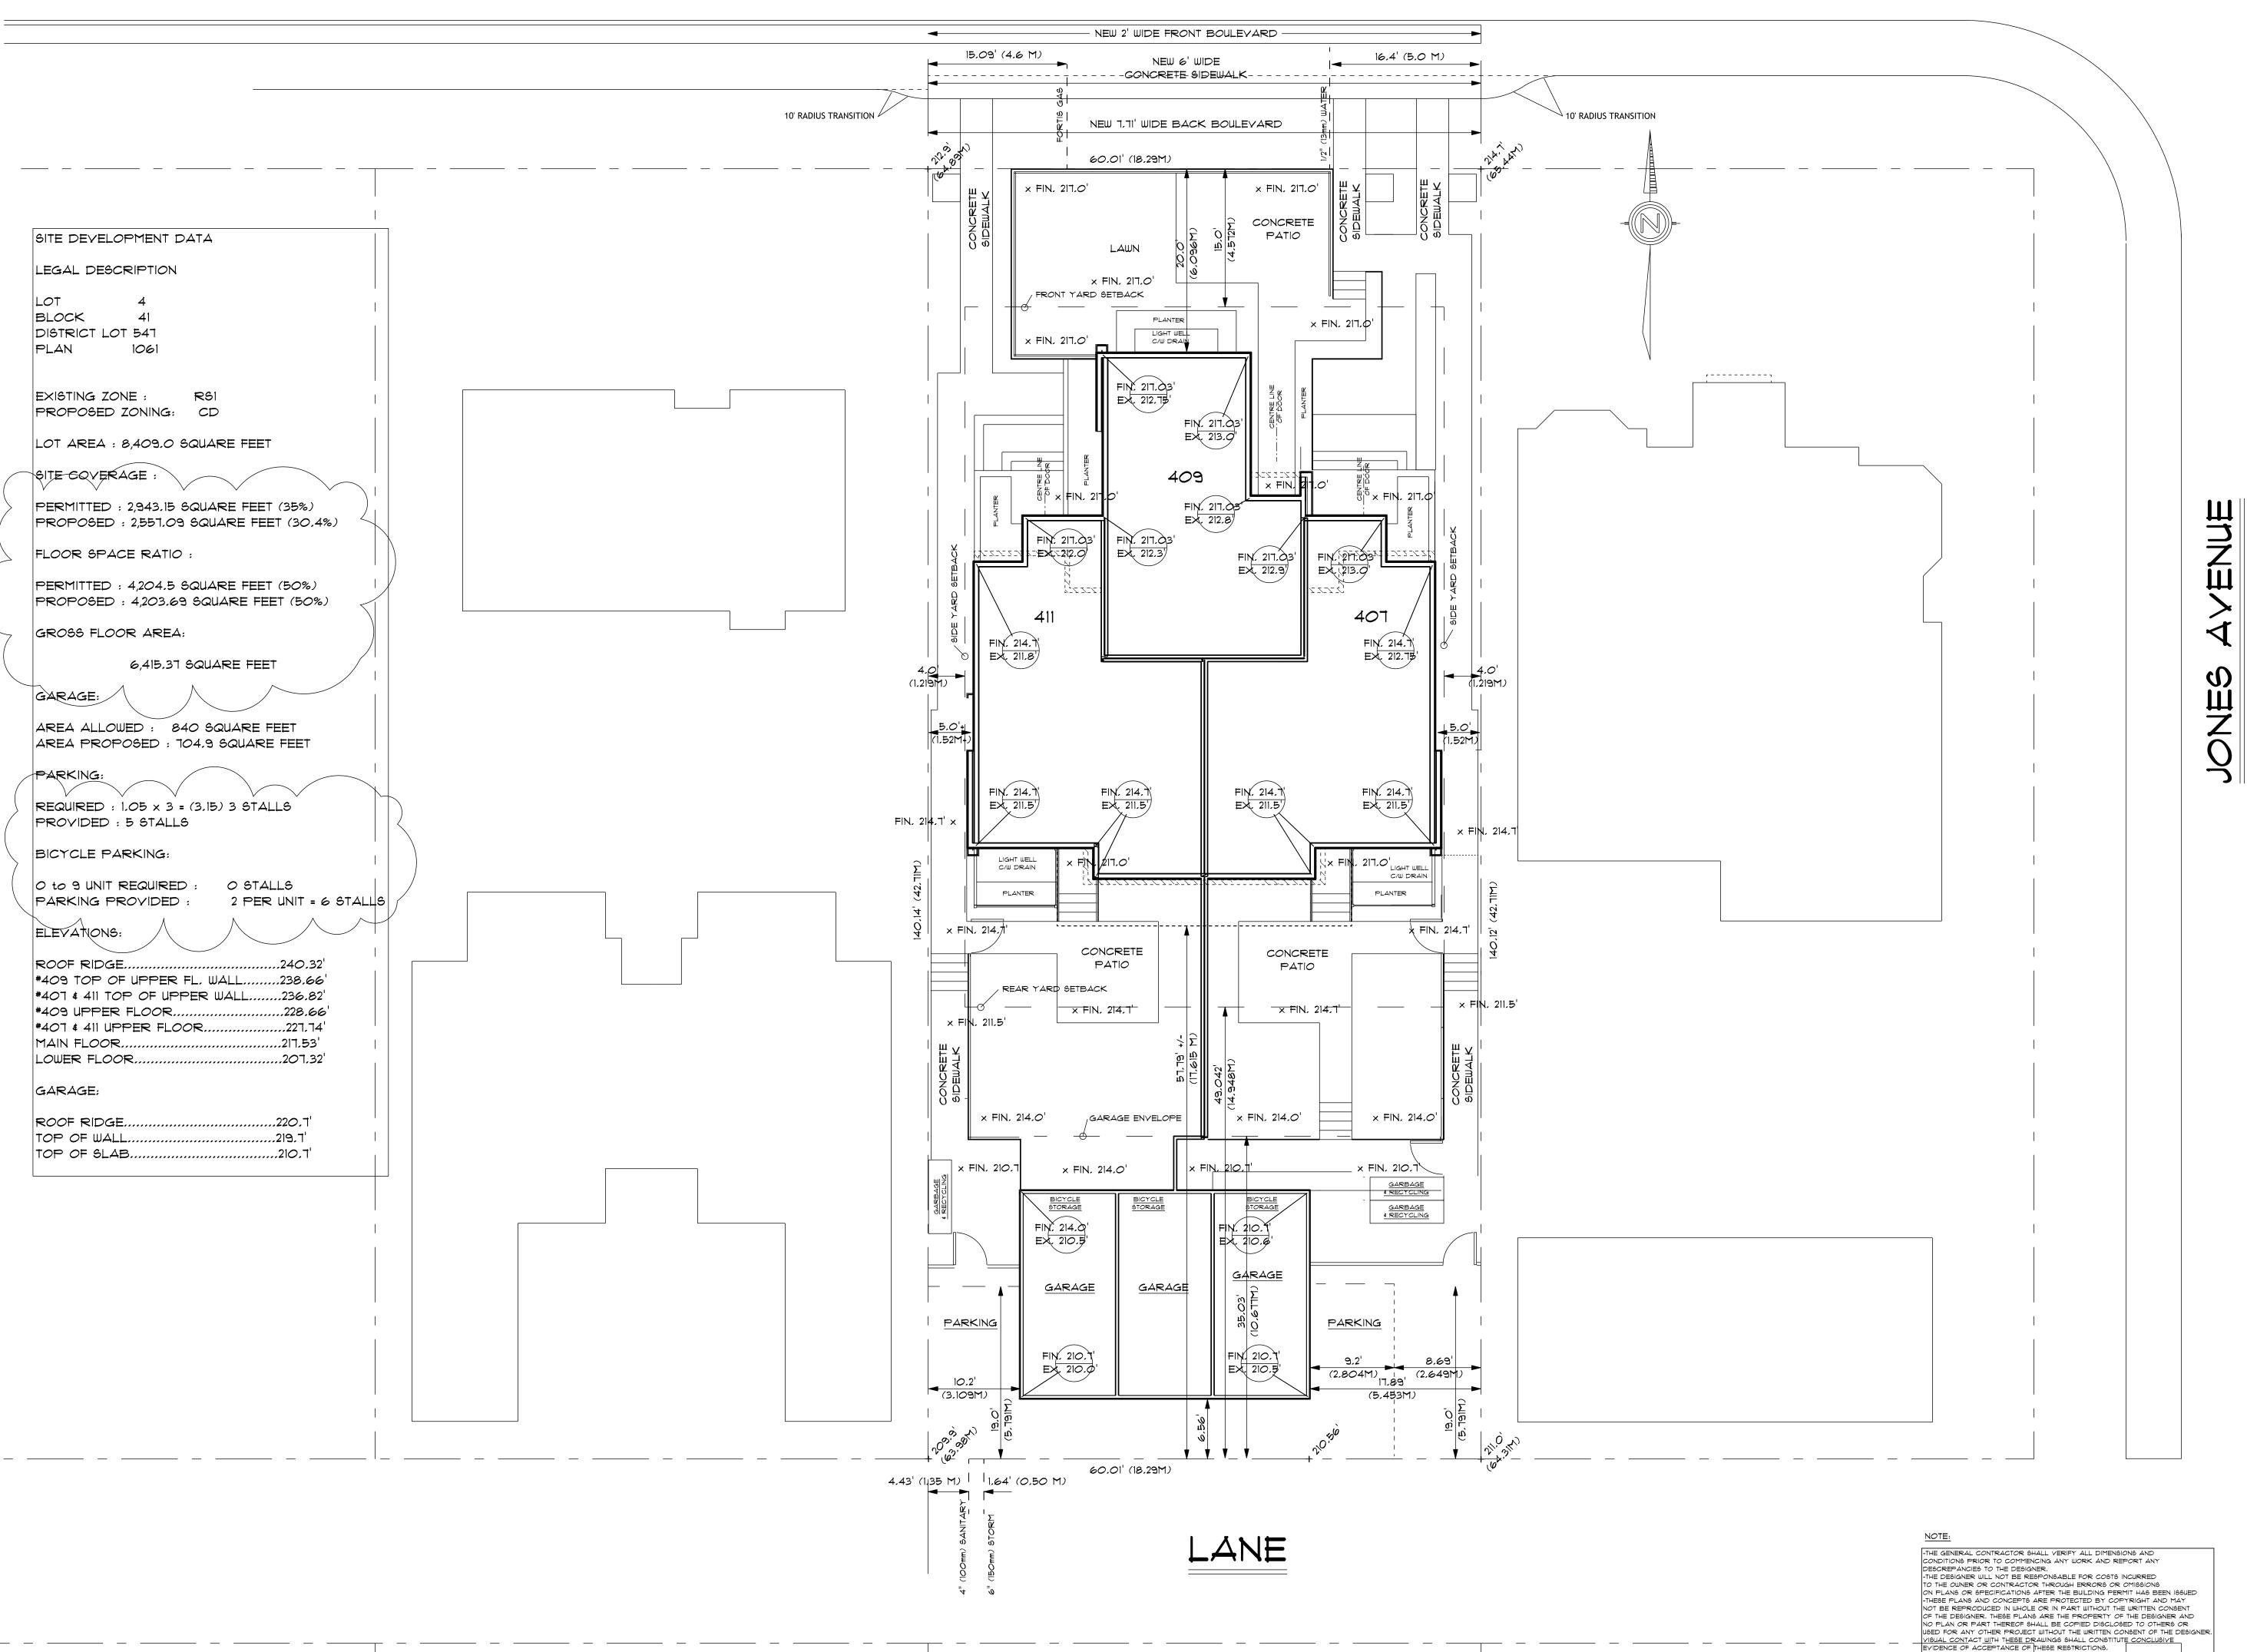

# consultants



Phone 604-986-4550 Fax 604-986-4555 billcurtisdesign@gmail.com **Harbourfront Business Centre** 

INSPIRATION

DESIGN

5th Floor, 224 West Esplanade

North Vancouver, BC V7M 3M6

604-365-9191

Corrected

**Team Review Revisions submitted** 

**ADP Revisions submitted** November, 2020 Issued for Rezoning Application







SITE PLAN

Drawn By B.C. Date MARCH 2020


1/8" : 1'-0"

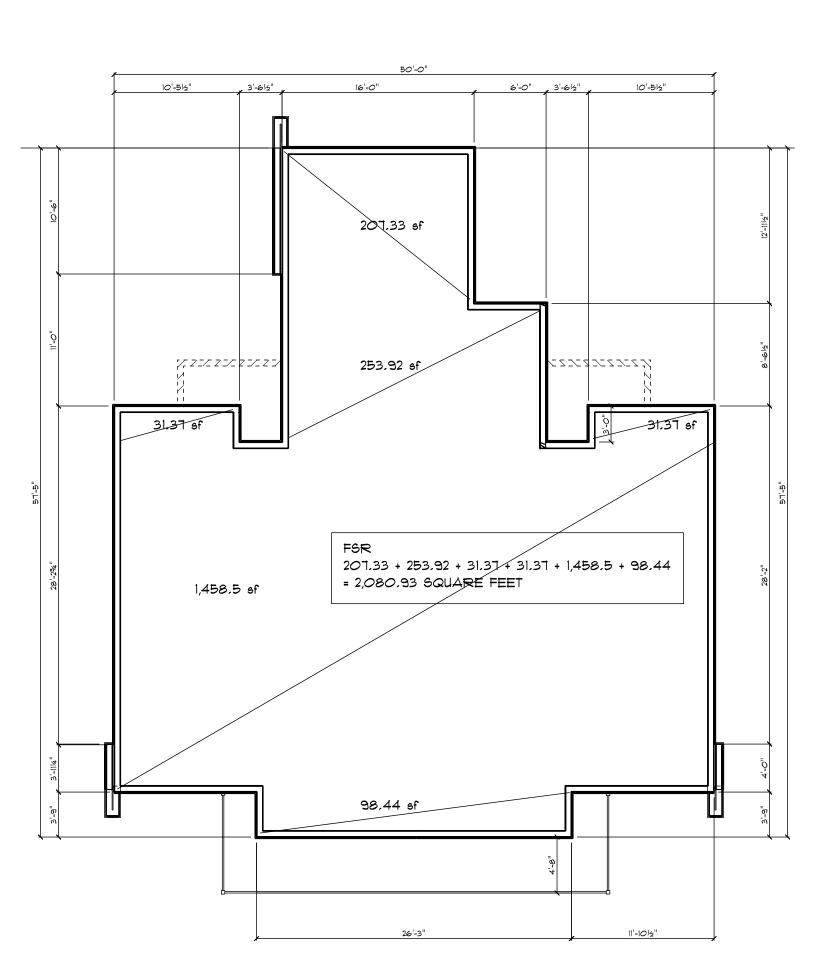

UPPER FLOOR 10 FLOOR AREA SCALE: 1/8" = 1'-0"

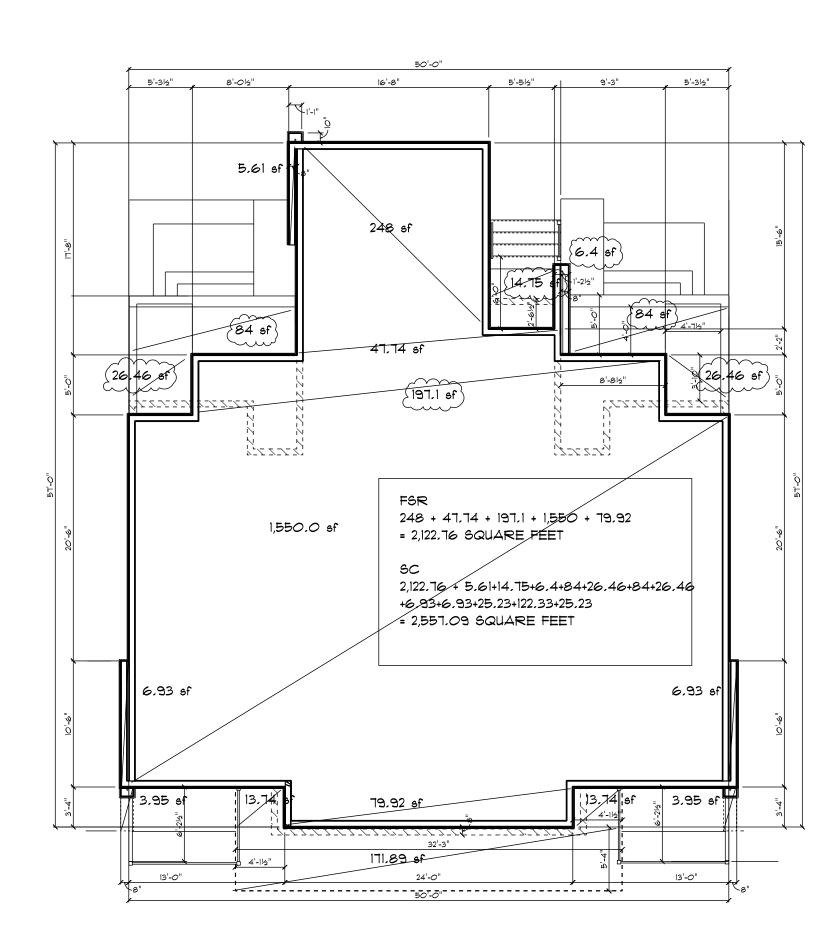

MAIN FLOOR 9 FLOOR AREA SCALE: 1/8" = 1'-0"

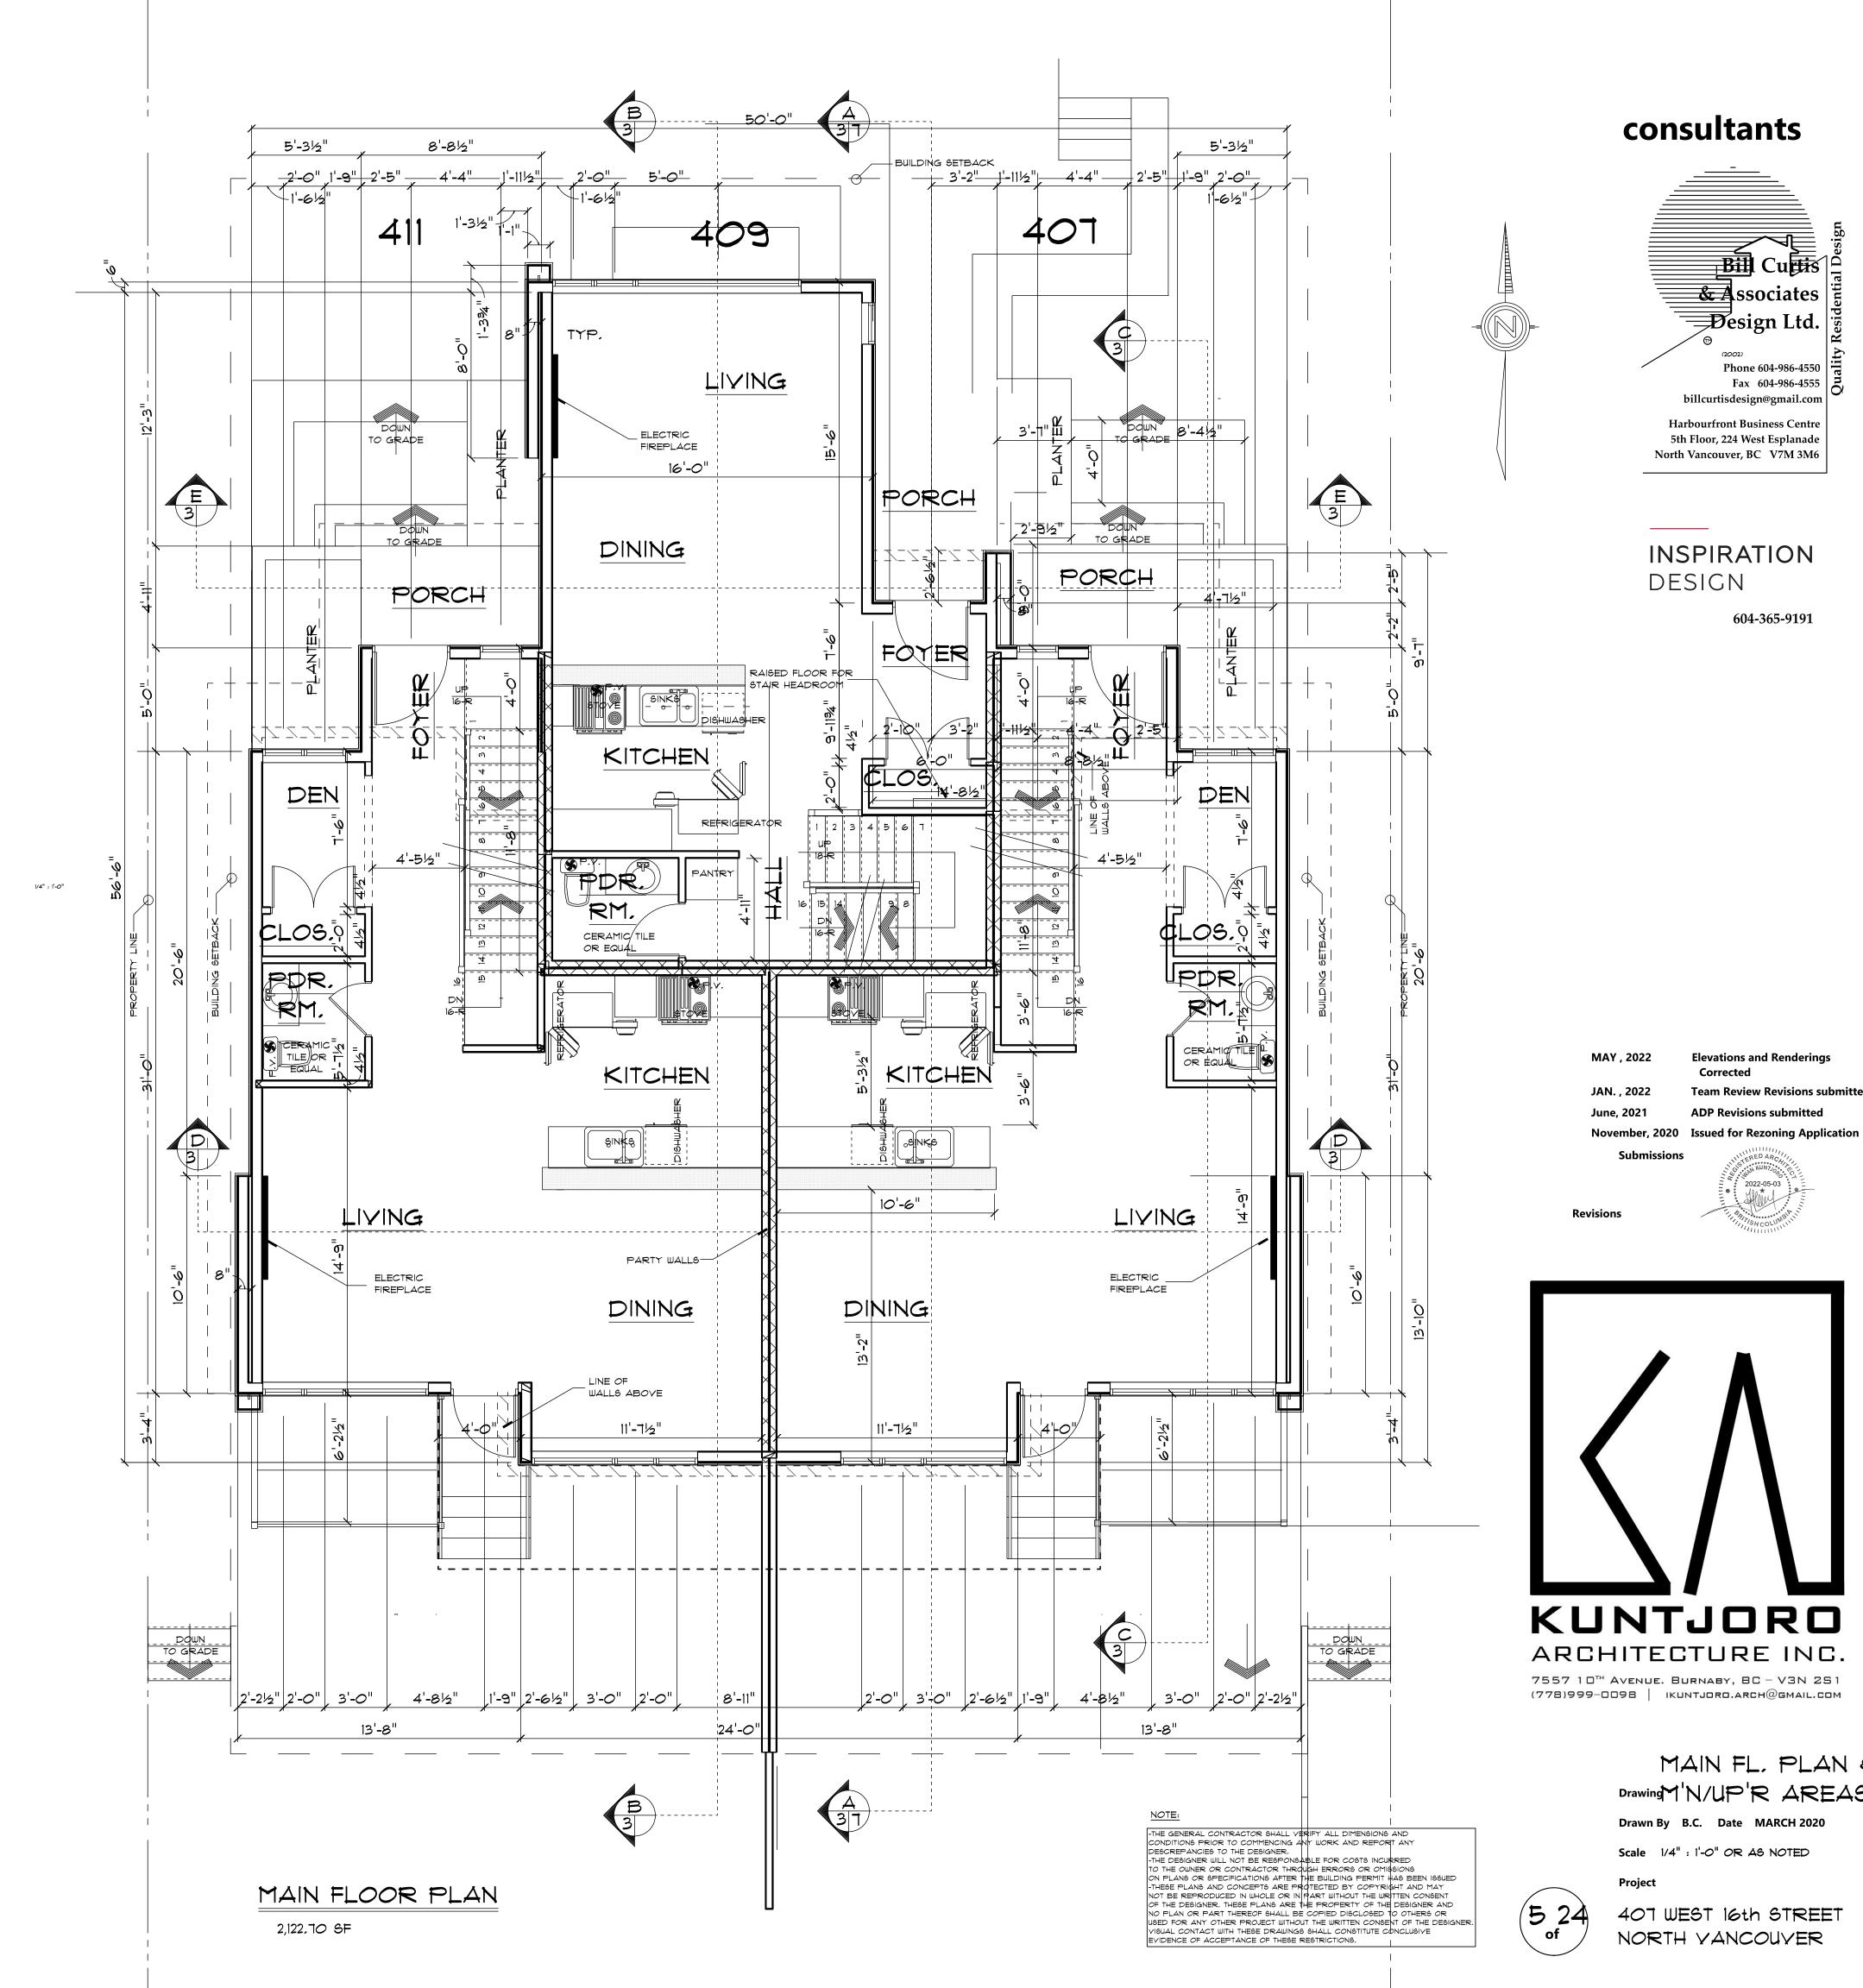

& Associates

esign Ltd.

5th Floor, 224 West Esplanade North Vancouver, BC V7M 3M6

INSPIRATION

DESIGN

Phone 604-986-4550

604-365-9191

**Elevations and Renderings** 

MAIN FL, PLAN \$

Drawing M'N/UP'R AREAS

Drawn By B.C. Date MARCH 2020


401 WEST 16th STREET

NORTH VANCOUVER


Scale 1/4" : 1'-0" OR AS NOTED

**Team Review Revisions submitted** 


Fax 604-986-4555

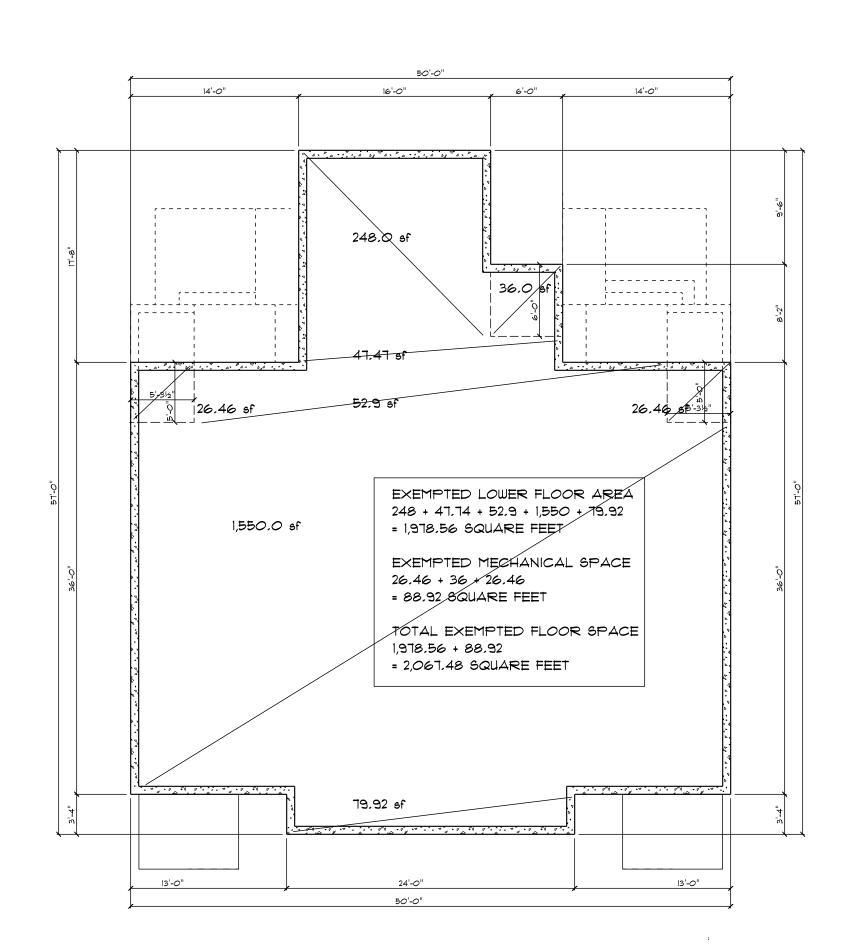

LOWER FLOOR FLOOR AREA SCALE: 1/8" = 1'-0"

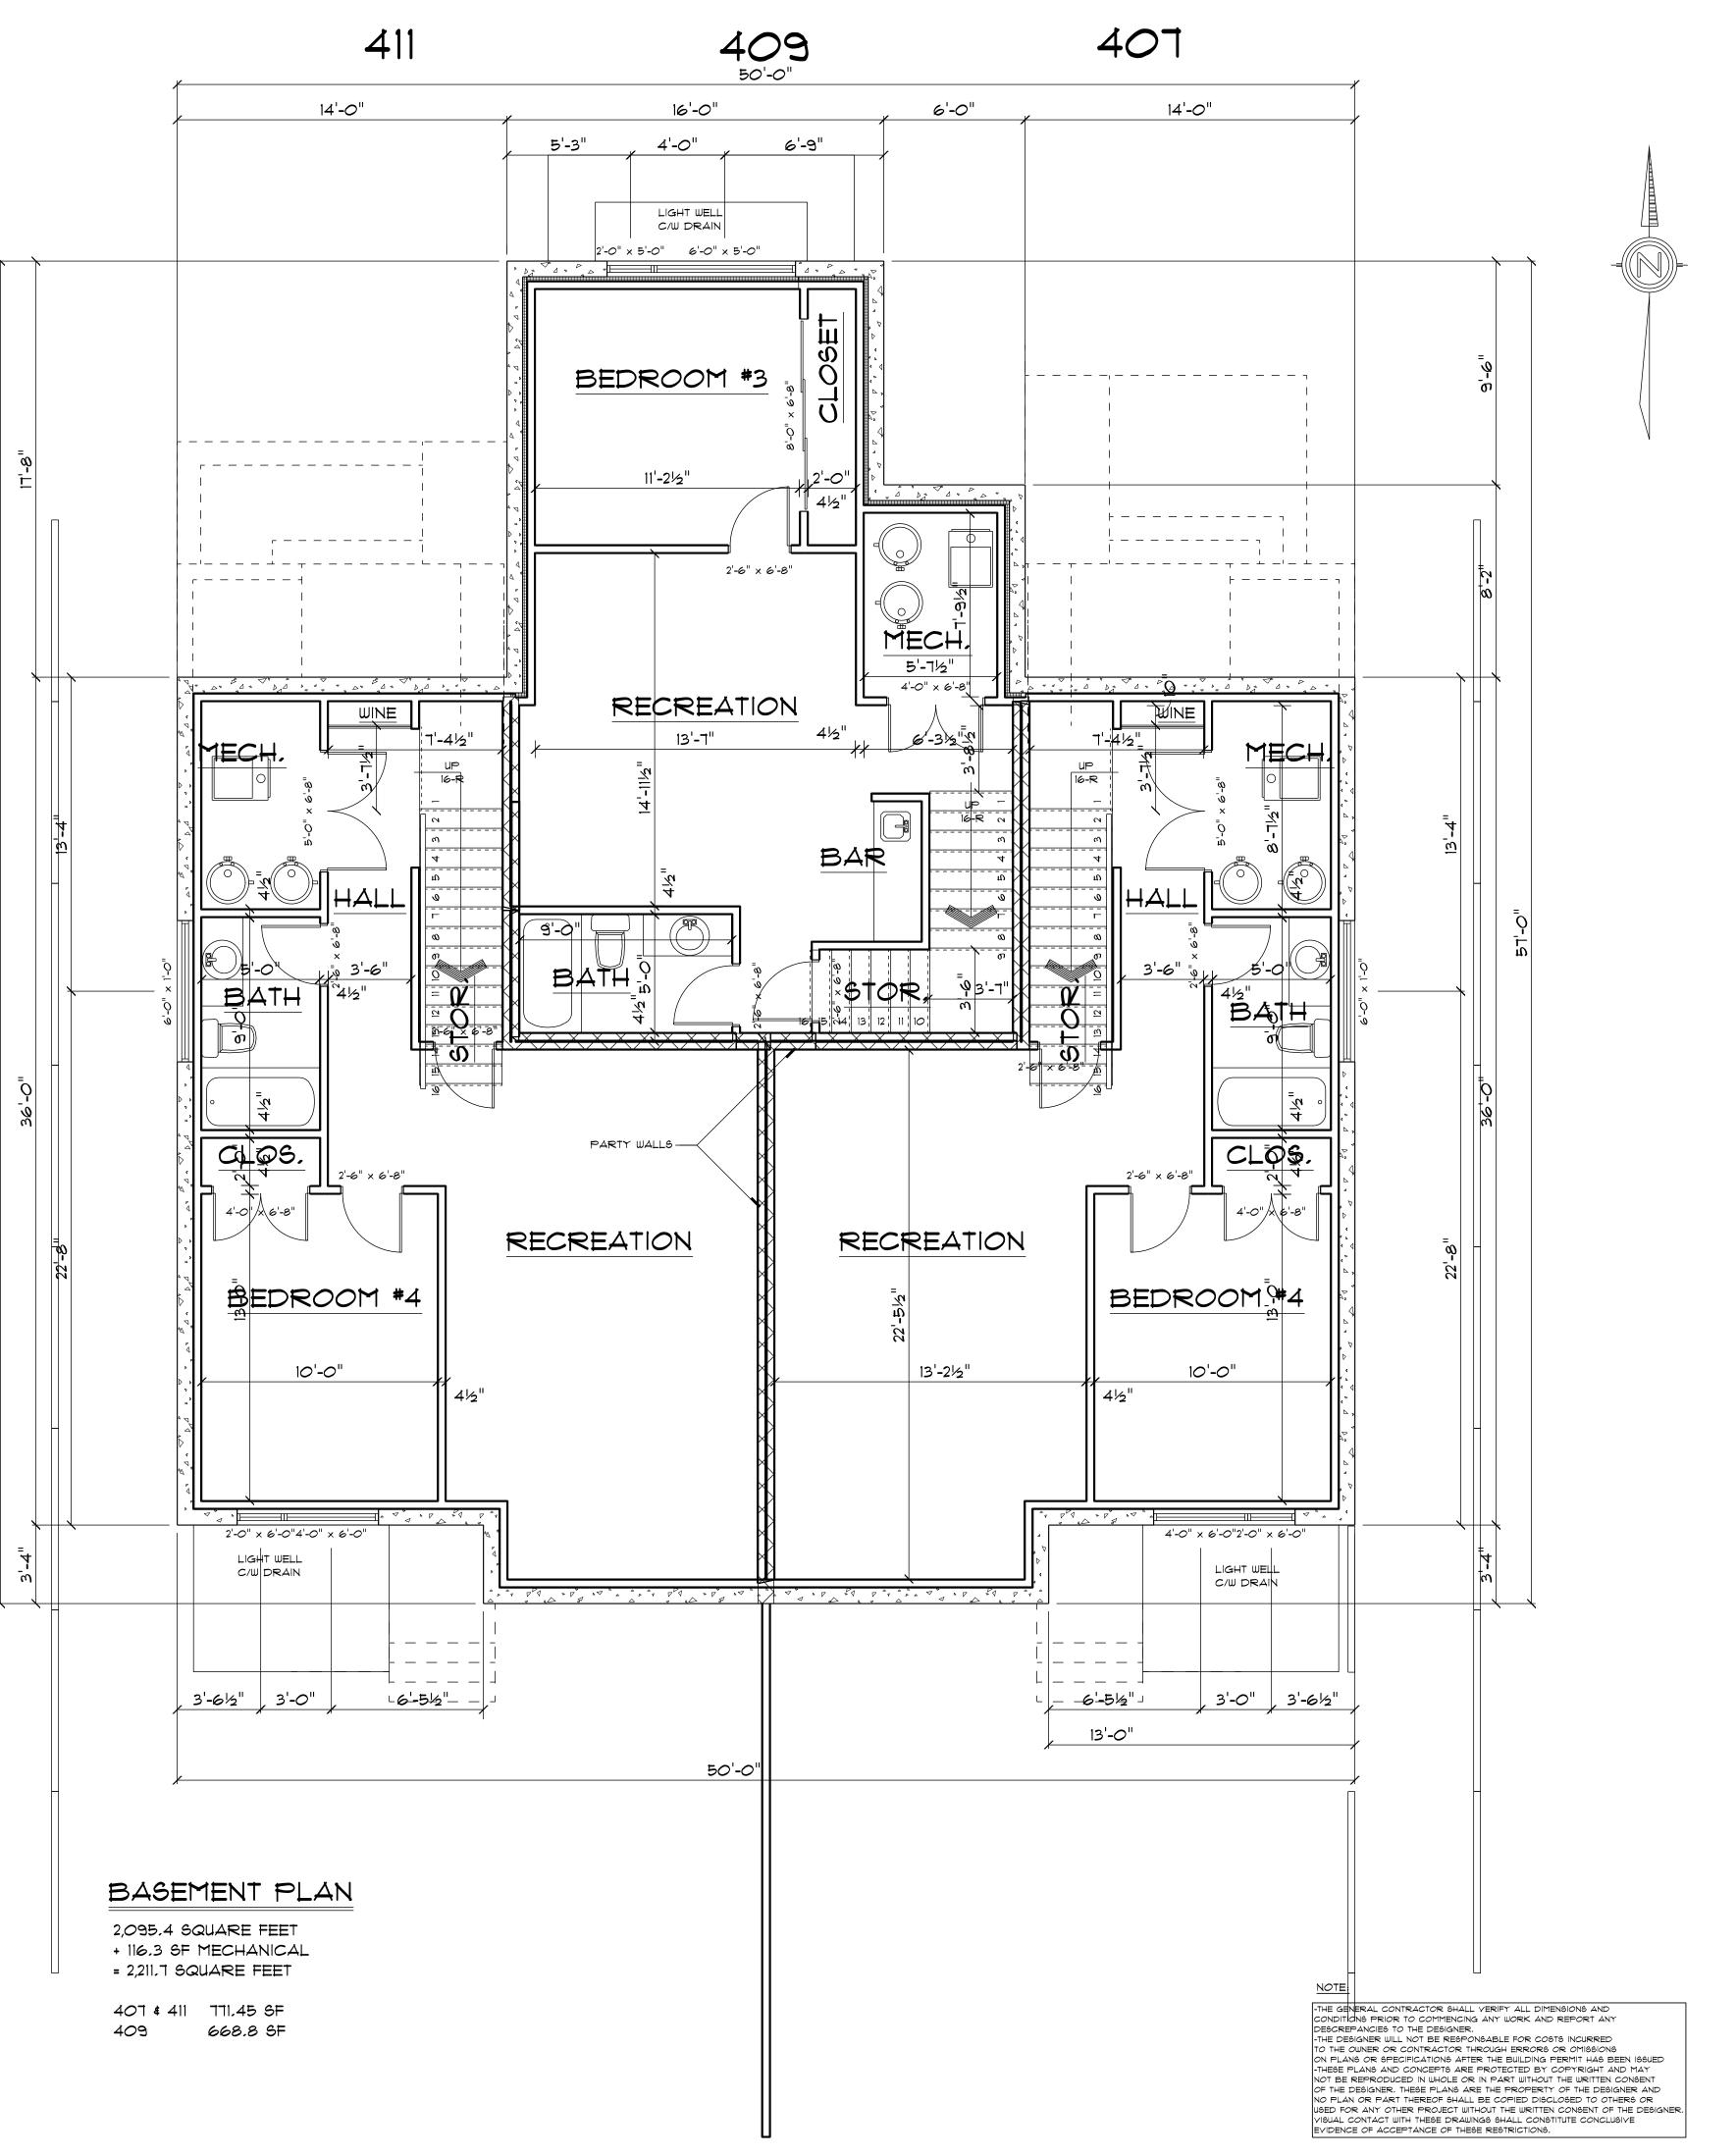

## consultants

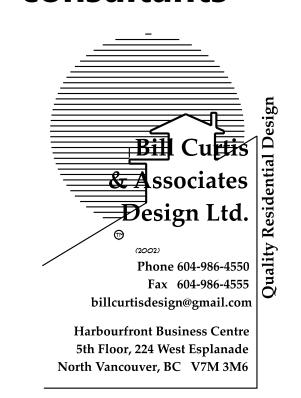

**INSPIRATION** DESIGN

604-365-9191

**Elevations and Renderings** Corrected **Team Review Revisions submitted ADP Revisions submitted** 

November, 2020 Issued for Rezoning Application




ARCHITECTURE INC.


7557 10TH AVENUE. BURNABY, BC - V3N 2S1 (778)999-0098 | IKUNTJORO.ARCH@GMAIL.COM

> BASE, PLAN Drawing & FL. AREAS


Drawn By B.C. Date MARCH 2020

1/4" : 1'-0" OR AS NOTED

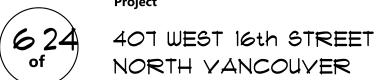

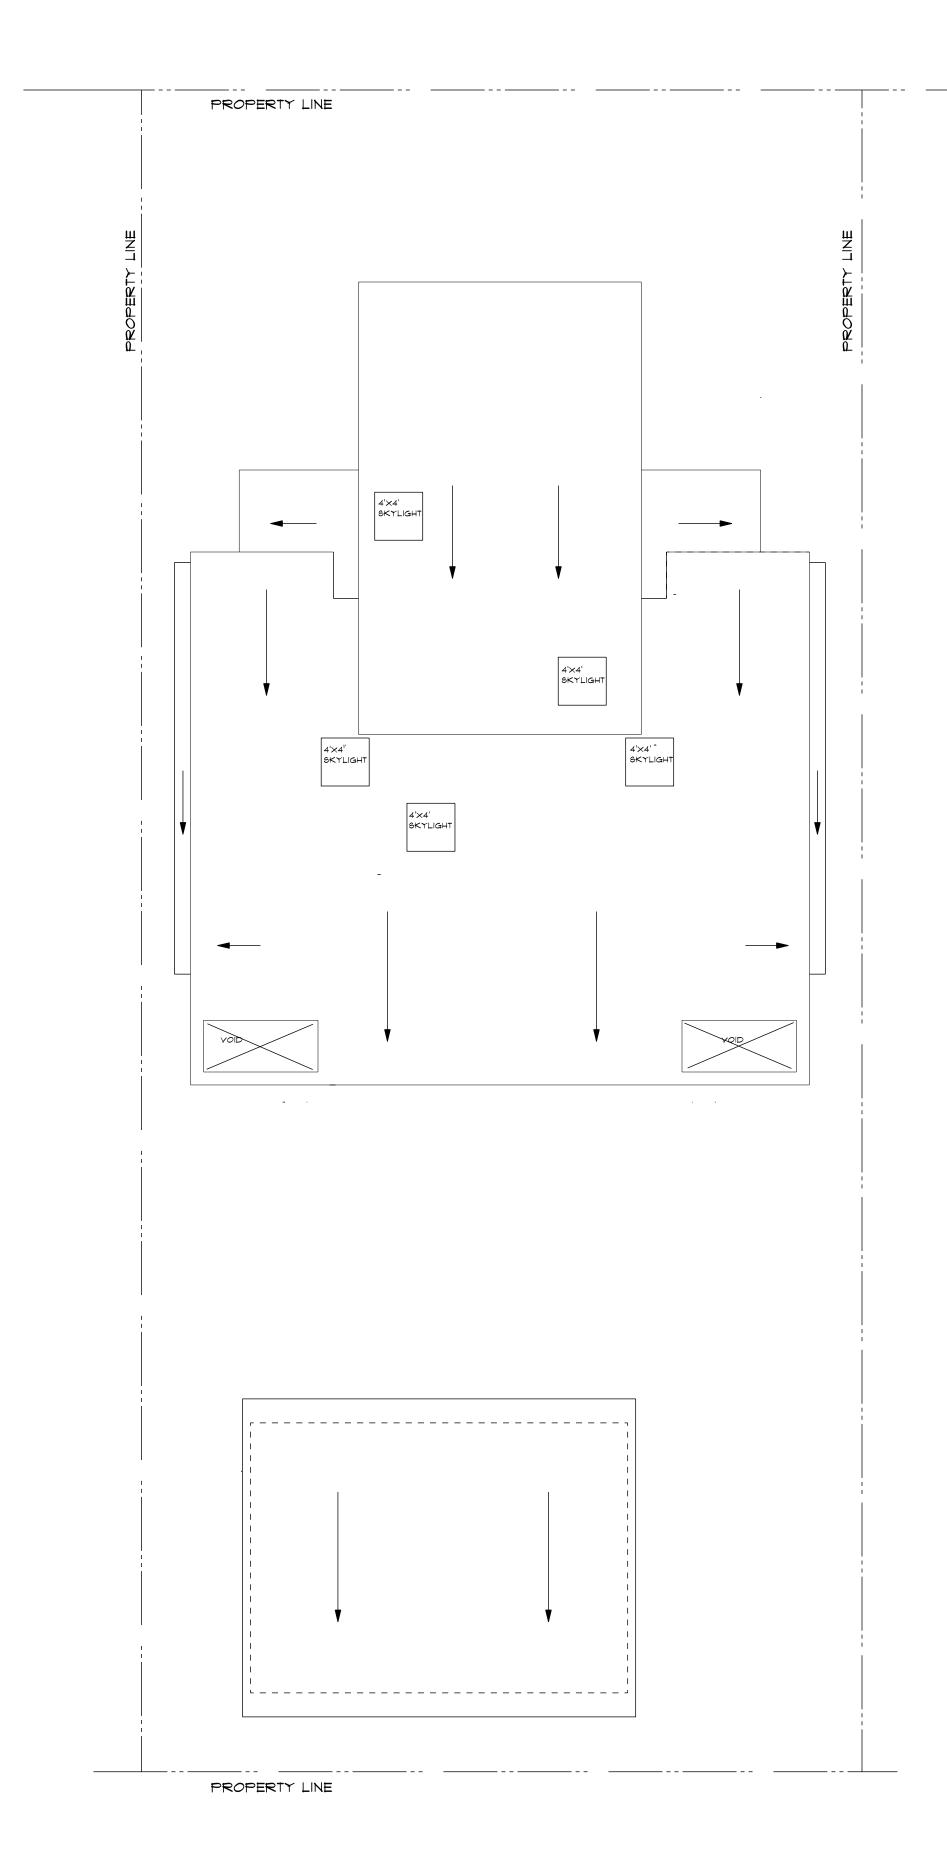

ROOF PLAN 9CALE 1/8" : 1'-0"

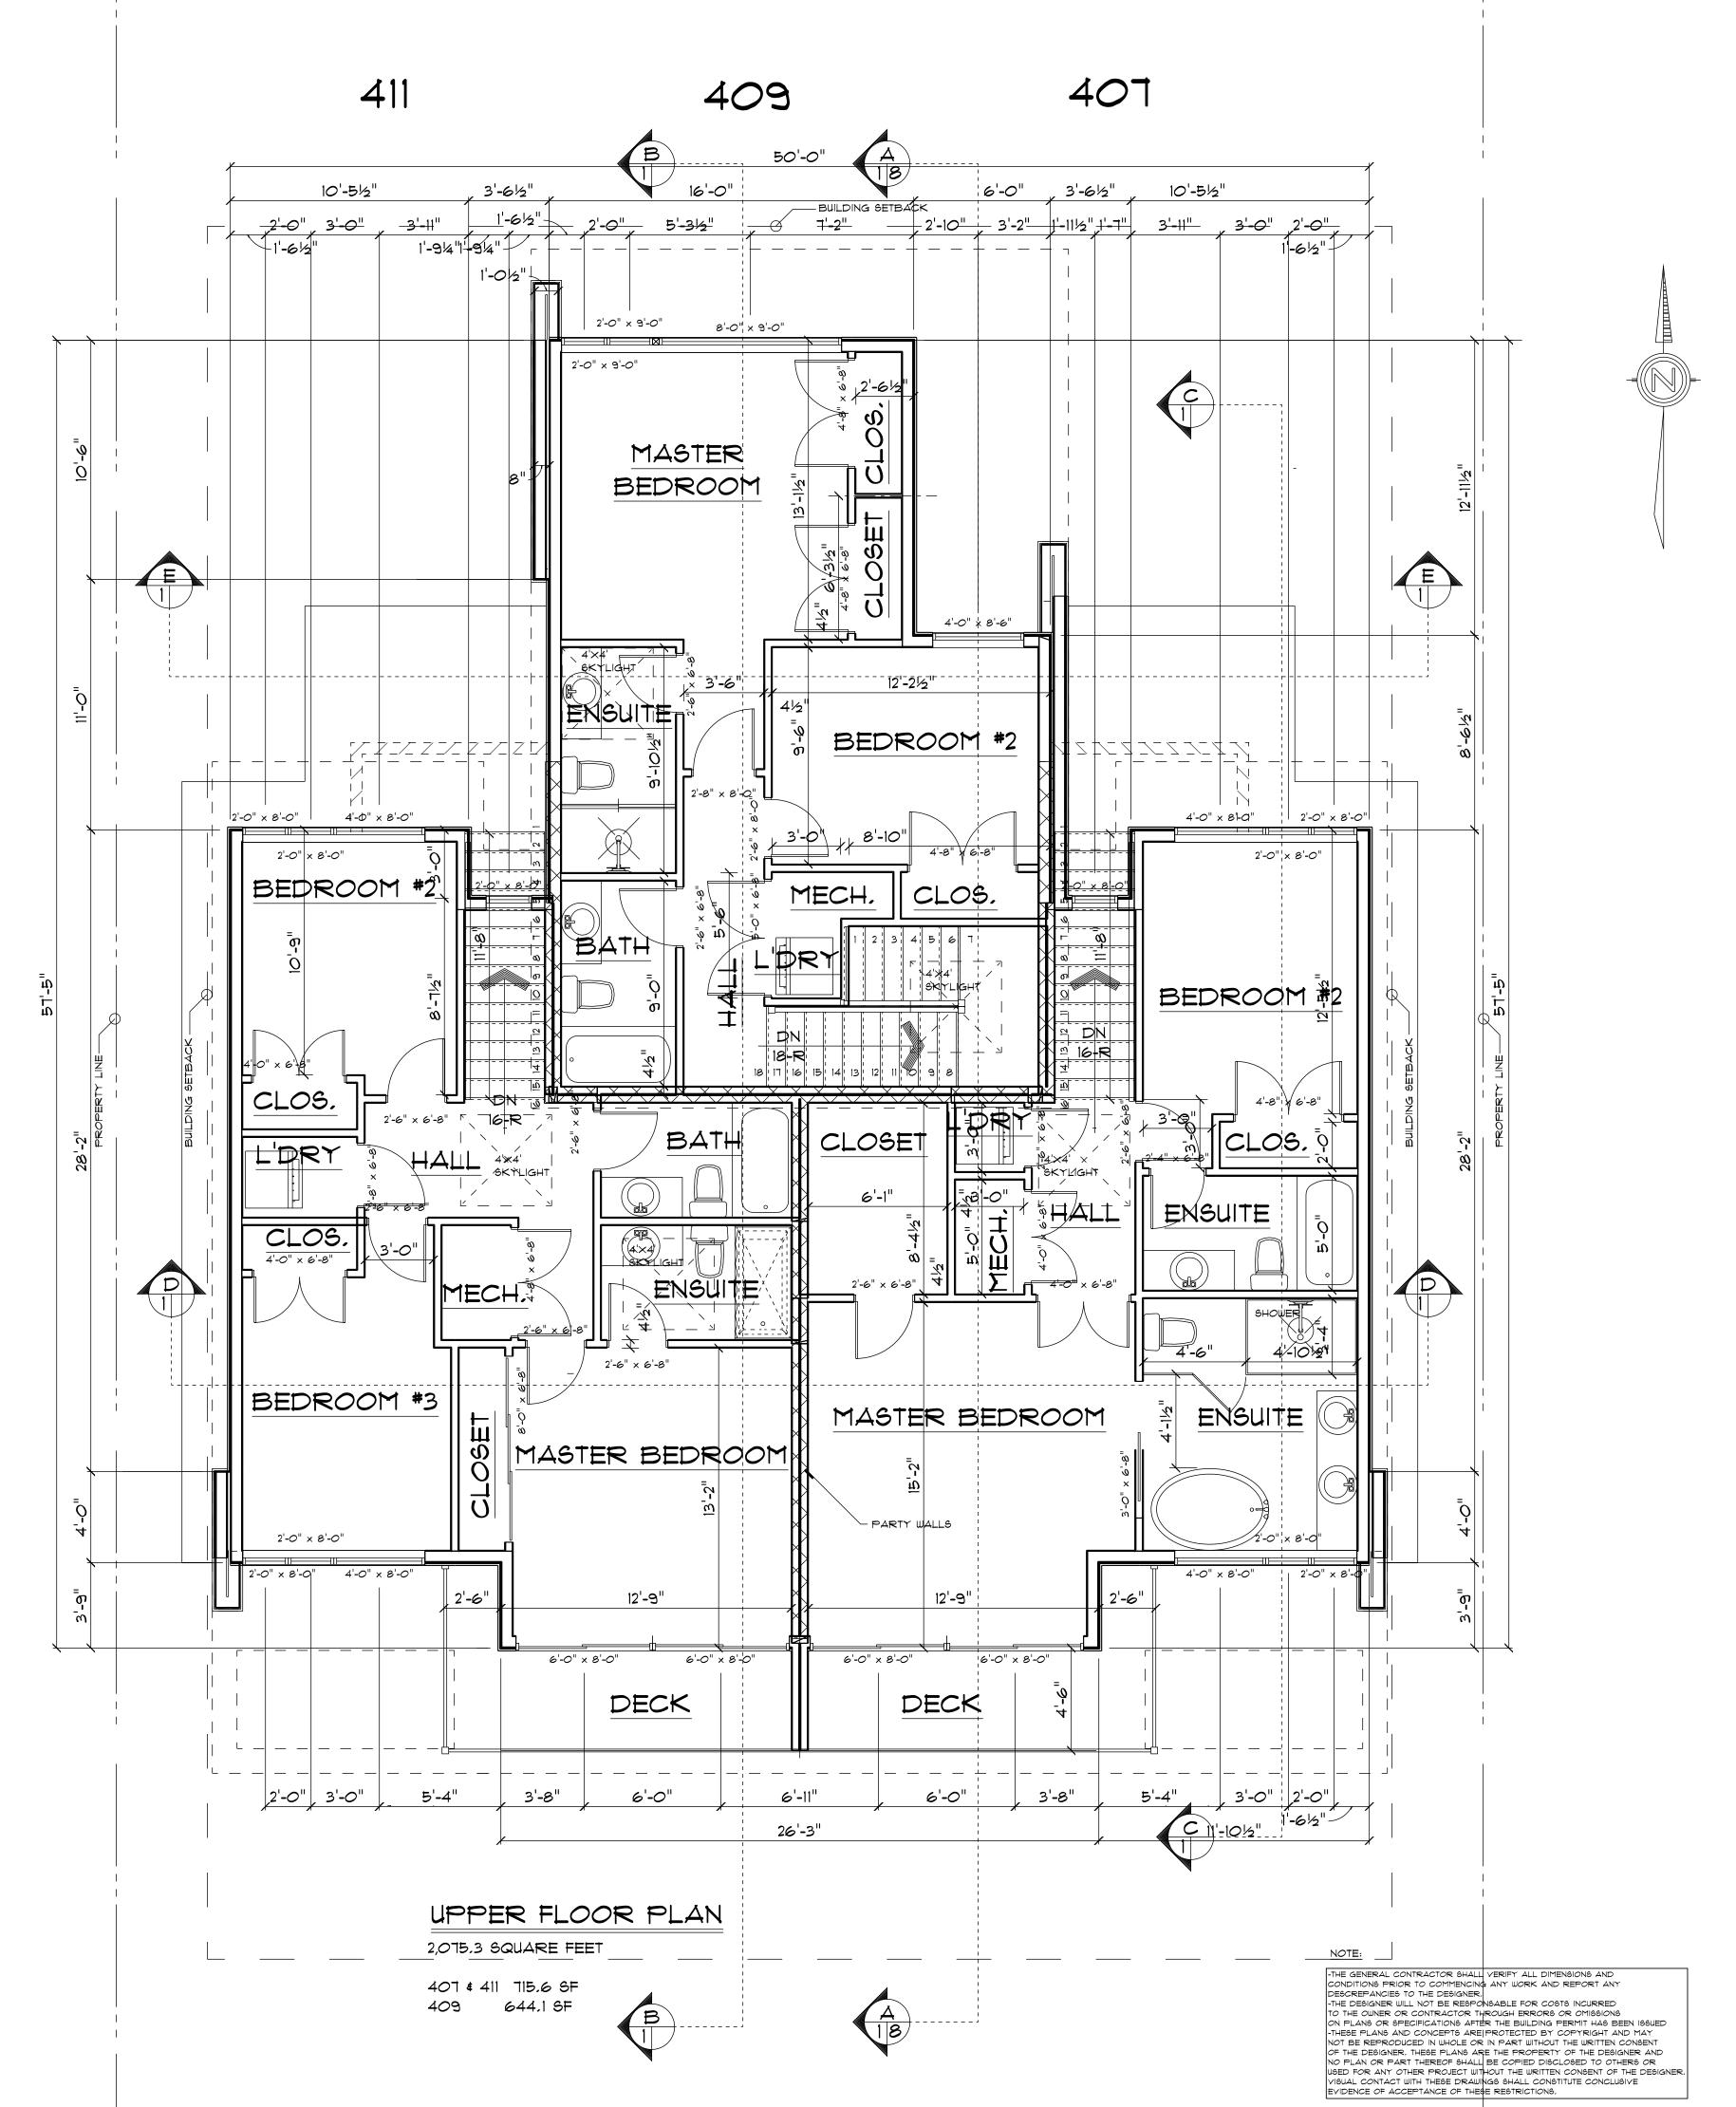



INSPIRATION DESIGN

604-365-9191


November, 2020 Issued for Rezoning Application




(778)999-0098 | IKUNTJORO.ARCH@GMAIL.COM

UPPER FLOOR # ROOF PLANS Drawn By B.C. Date MARCH 2020

1/4" : 1'-0" OR AS NOTED

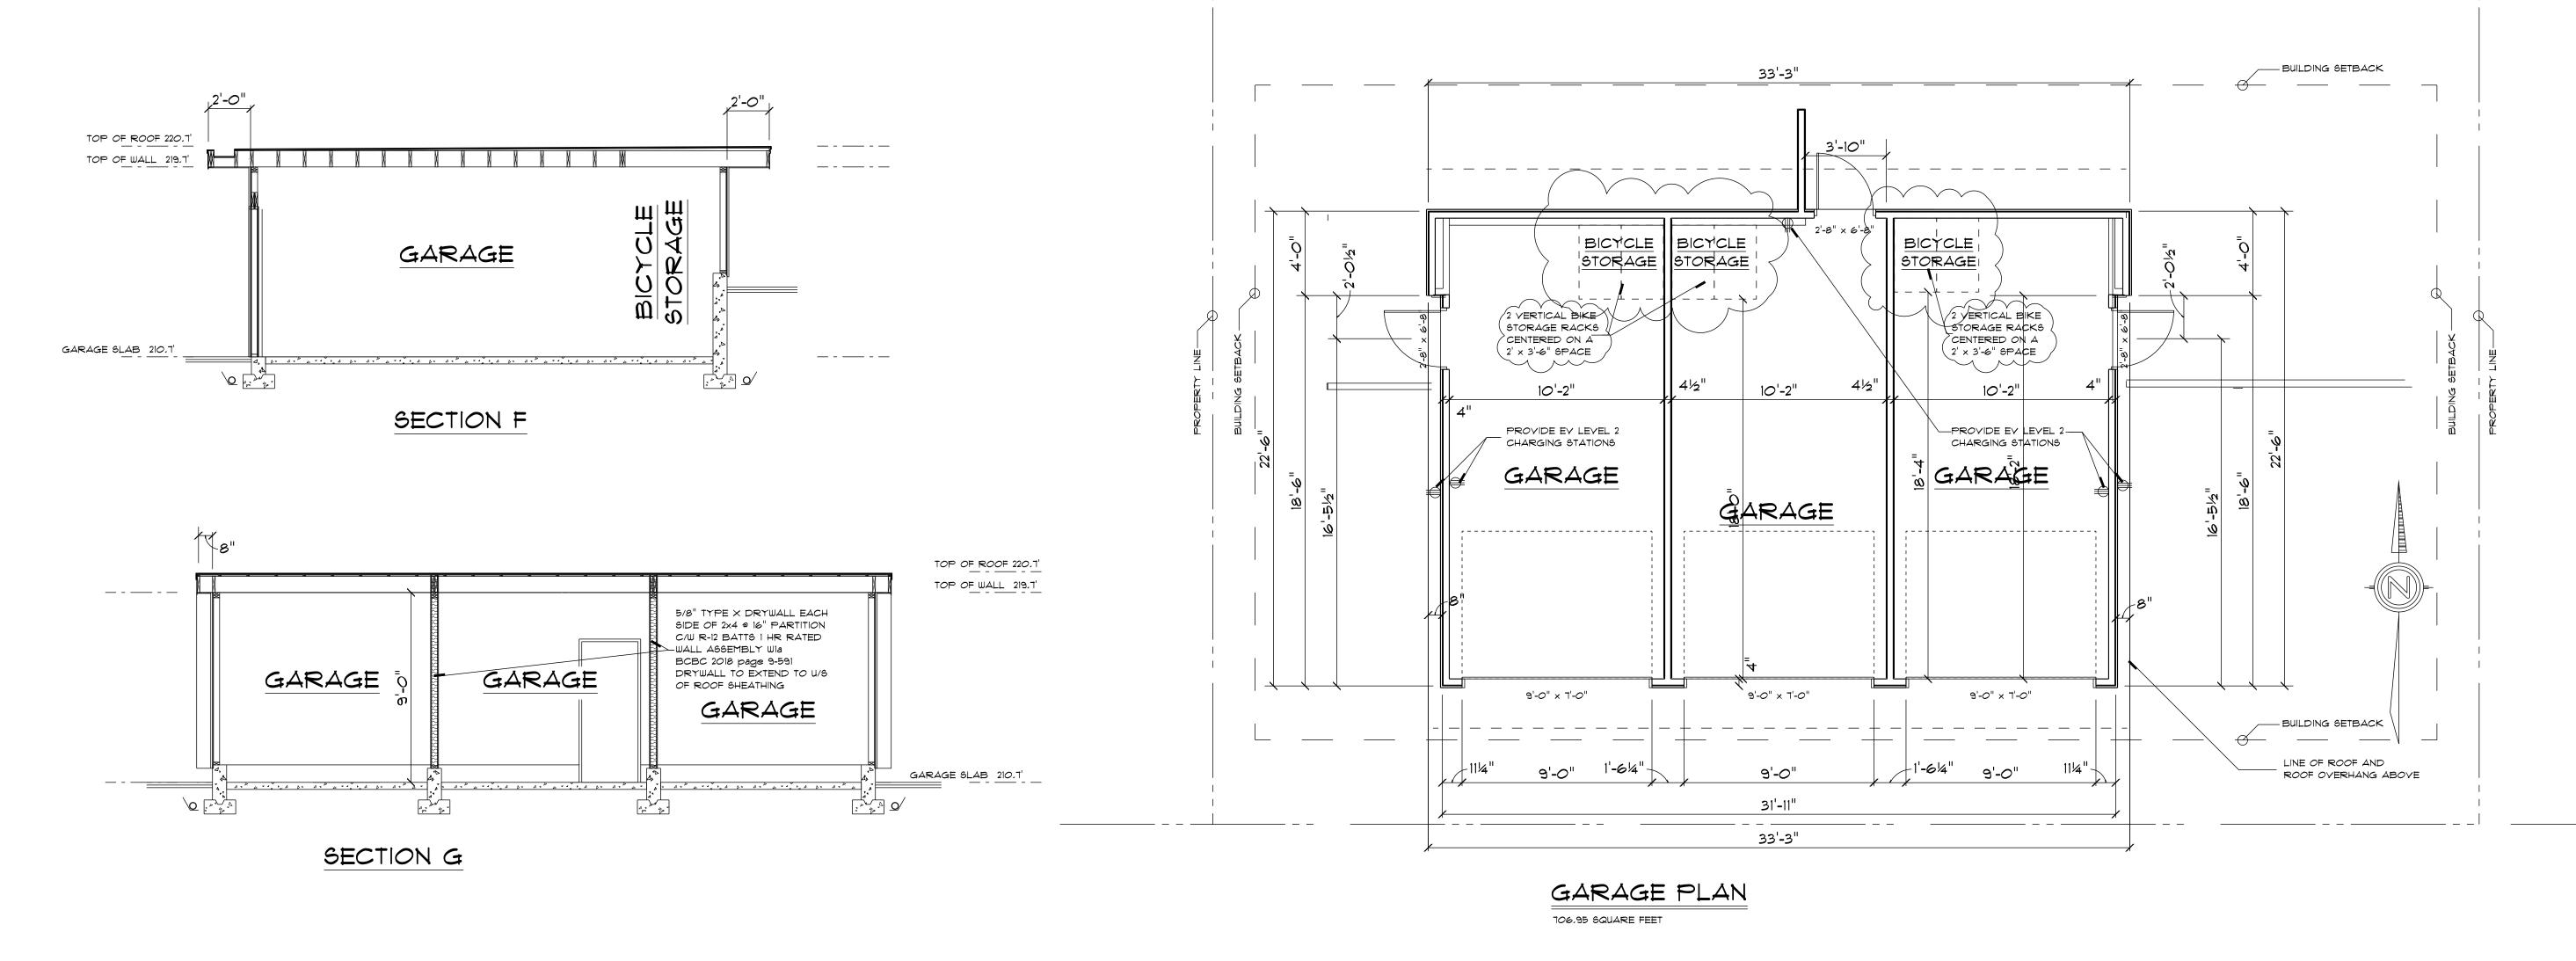

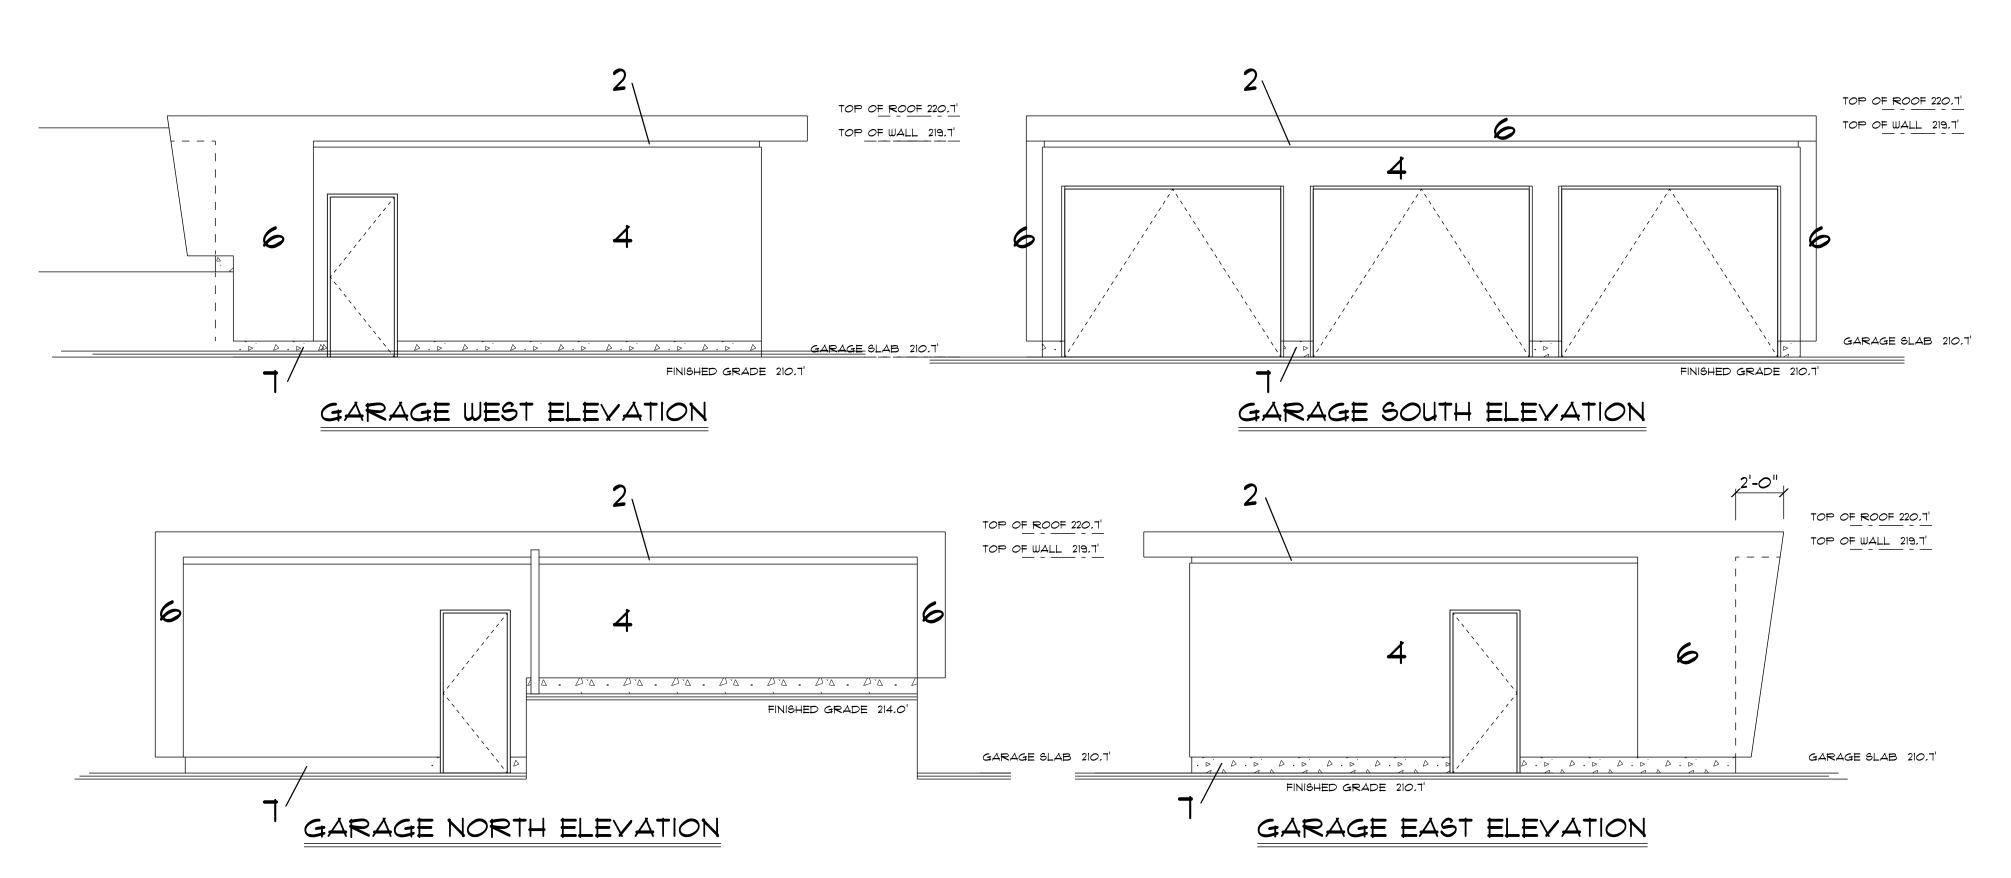

#### MATERIAL LEGEND

1	Glass	Light grey tint Windows, Glass Doors, Deck and Balcony guard panels
2	Reveal	Painted Sherwin Williams SWv6258/ Tricorn Black
3	Fiber Cement Panel — - — - —	Turfblock Steel Colour (flashings finished to match)
4	Fiber Cement Panel	Metalic Series combination of Ribbed / Non Ribbed, Ivory
5	Fiber Cement Panel	Arch Block Series, Grey (flashings finished to match)
6	Cross Laminated Edge-Glued Engineered Solid Panel	Include all Soffits
7	Concrete	
8	Window Mullion and Door Colour to match 3	Tuffblock Steel Colour
		1

NOTE:

THE GENERAL CONTRACTOR SHALL VERIFY ALL DIMENSIONS AND CONDITIONS PRIOR TO COMMENCING ANY WORK AND REPORT ANY DESCREPANCIES TO THE DESIGNER.

THE DESIGNER WILL NOT BE RESPONSABLE FOR COSTS INCURRED TO THE OWNER OR CONTRACTOR THROUGH ERRORS OR OMISSIONS ON PLANS OR SPECIFICATIONS AFTER THE BUILDING PERMIT HAS BEEN ISSUED THESE PLANS AND CONCEPTS ARE PROTECTED BY COPYRIGHT AND MAY NOT BE REPRODUCED IN WHOLE OR IN PART WITHOUT THE WRITTEN CONSENT OF THE DESIGNER, THESE PLANS ARE THE PROPERTY OF THE DESIGNER AND NO PLAN OR PART THEREOF SHALL BE COPIED DISCLOSED TO OTHERS OR USED FOR ANY OTHER PROJECT WITHOUT THE WRITTEN CONSENT OF THE DESIGNER, VISUAL CONTACT WITH THESE DRAWINGS SHALL CONSTITUTE CONCLUSIVE EVIDENCE OF ACCEPTANCE OF THESE RESTRICTIONS.

## consultants



INSPIRATION DESIGN

604-365-9191

MAY , 2022 Elevations and Renderings
Corrected

JAN. , 2022 Team Review Revisions subm

June, 2021 ADP Revisions submitted

Davisian



L\\ KUNTJORO

ARCHITECTURE INC.
7557 10TH AVENUE. BURNABY, BC - V3N 251
(778)999-0098 | IKUNTJORO.ARCH@GMAIL.COM

GARAGE


Drawing PLANS

Drawn By B.C. Date MARCH 2020


Scale 1/4" : 1'-0"



# **ROOF RIDGE 240.32** \_ - - \_ - \_ TOP OF WALL 238.66' 5 5 5 TOP OF WALL 236.82' UPPER FLOOR 228.66 UPPER FLOOR 227.74' 6 6 MAIN FLOOR 217.53' \_\_\_\_\_ \_ - - \_ - \_ -FINISHED GRADE 217.0' · - - - - # - - - - - - -

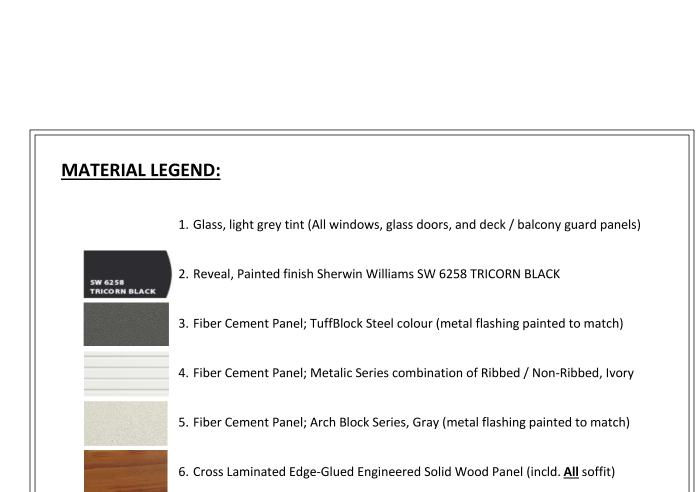

7. Concrete

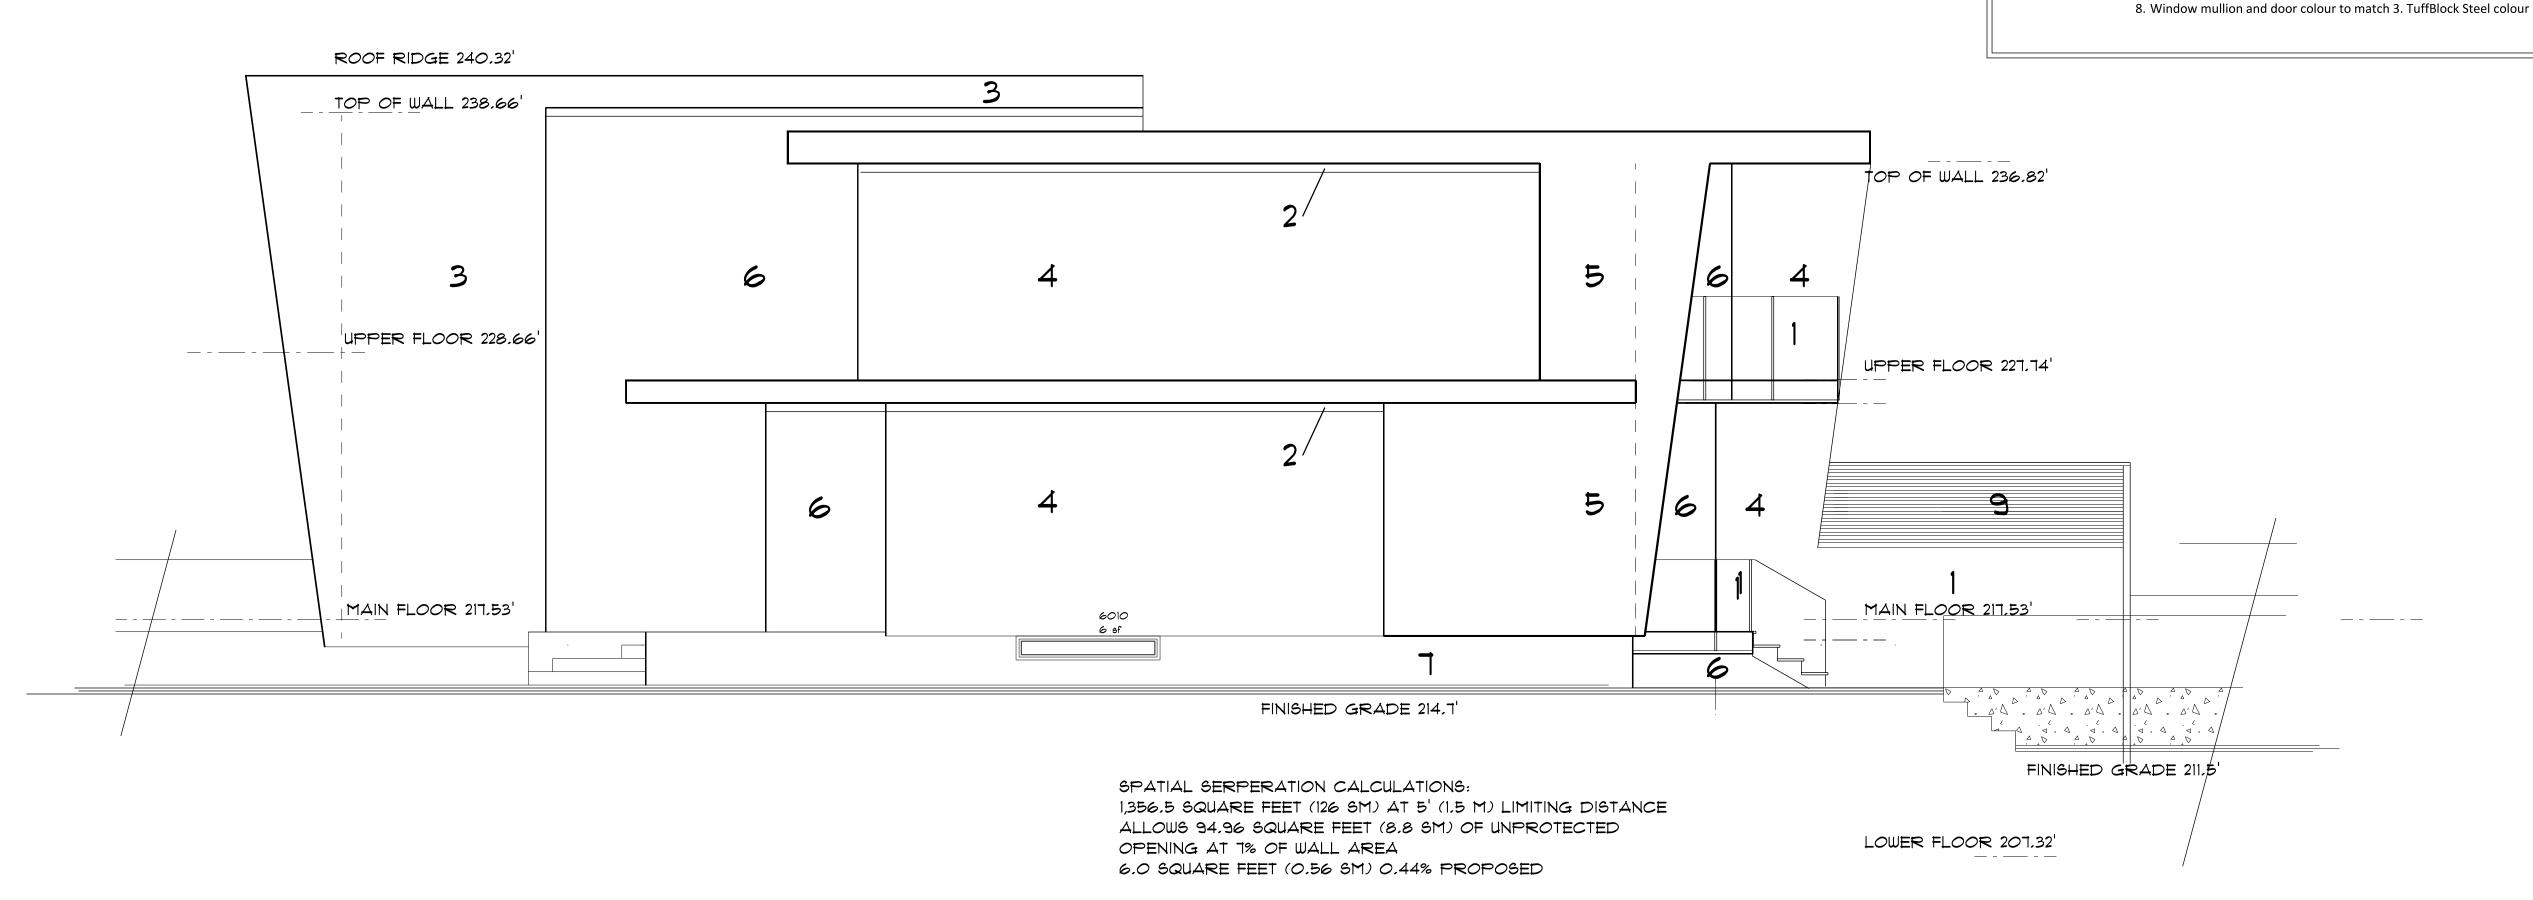

WEST ELEVATION

NORTH ELEVATION

LOWER FLOOR 207.32'

NOTE:

-THE GENERAL CONTRACTOR SHALL VERIFY ALL DIMENSIONS AND CONDITIONS PRIOR TO COMMENCING ANY WORK AND REPORT ANY DESCREPANCIES TO THE DESIGNER.

-THE DESIGNER WILL NOT BE RESPONSABLE FOR COSTS INCURRED TO THE OWNER OR CONTRACTOR THROUGH ERRORS OR OMISSIONS ON PLANS OR SPECIFICATIONS AFTER THE BUILDING PERMIT HAS BEEN ISSUED -THESE PLANS AND CONCEPTS ARE PROTECTED BY COPYRIGHT AND MAY NOT BE REPRODUCED IN WHOLE OR IN PART WITHOUT THE WRITTEN CONSENT OF THE DESIGNER, THESE PLANS ARE THE PROPERTY OF THE DESIGNER AND NO PLAN OR PART THEREOF SHALL BE COPIED DISCLOSED TO OTHERS OR USED FOR ANY OTHER PROJECT WITHOUT THE WRITTEN CONSENT OF THE DESIGNER, VISUAL CONTACT WITH THESE DRAWINGS SHALL CONSTITUTE CONCLUSIVE EVIDENCE OF ACCEPTANCE OF THESE RESTRICTIONS.

# consultants



#### INSPIRATION DESIGN

604-365-9191

MAY , 2022 Elevations and Renderings
Corrected

JAN. , 2022 Team Review Revisions submitted

June, 2021 ADP Revisions submitted

November, 2020 Issued for Rezoning Application
Submissions

Revisions



NORTH & WEST

Drawing ELEVATIONS

Drawn By B.C. Date MARCH 2020

7557 10TH AVENUE. BURNABY, BC - V3N 2S1

(778)999-0098 | IKUNTJORO.ARCH@GMAIL.COM


ale <sub>1/4" : 1</sub>'-0"

oiect



**INSPIRATION** DESIGN


604-365-9191

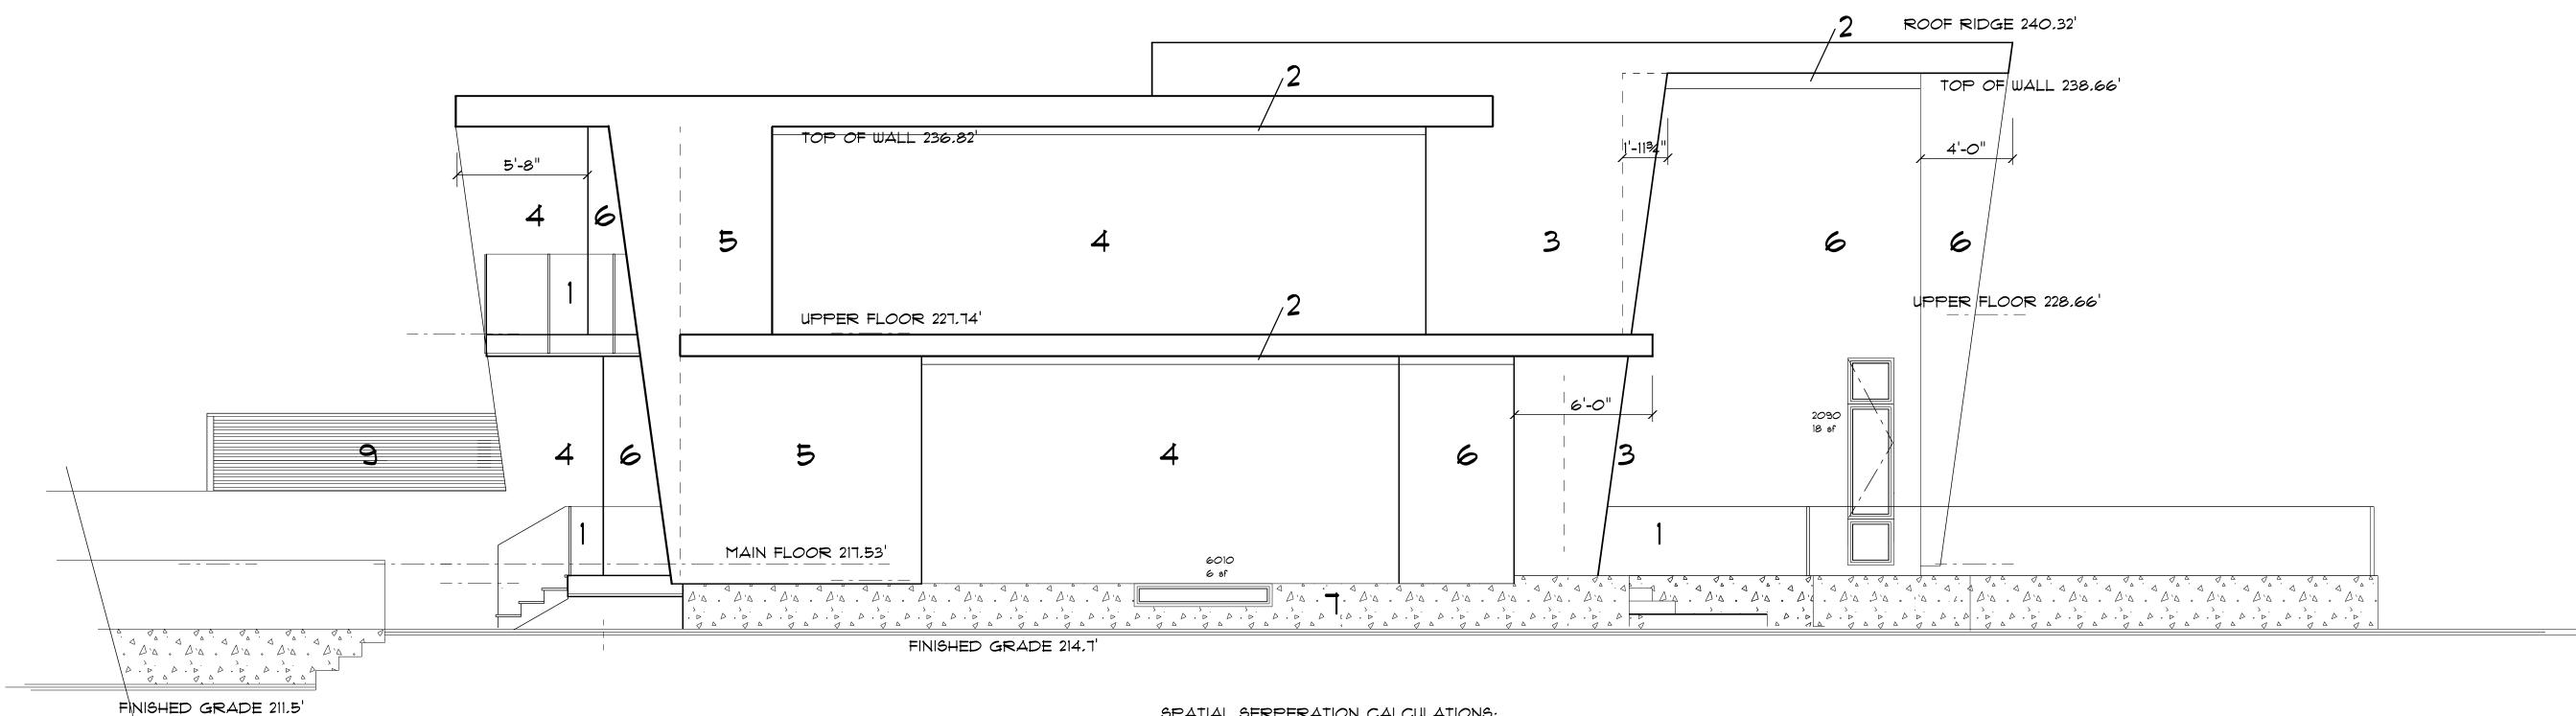

SPATIAL SERPERATION CALCULATIONS: 1,356.5 SQUARE FEET (126 SM) AT 5' (1.5 M) LIMITING DISTANCE ALLOWS 94,96 SQUARE FEET (8,8 SM) OF UNPROTECTED OPENING AT 7% OF WALL AREA LOWER FLOOR 207.32 24.0 SQUARE FEET (2.23 SM) 1.8% PROPOSED

#### EAST ELEVATION

LOWER FLOOR 207.32

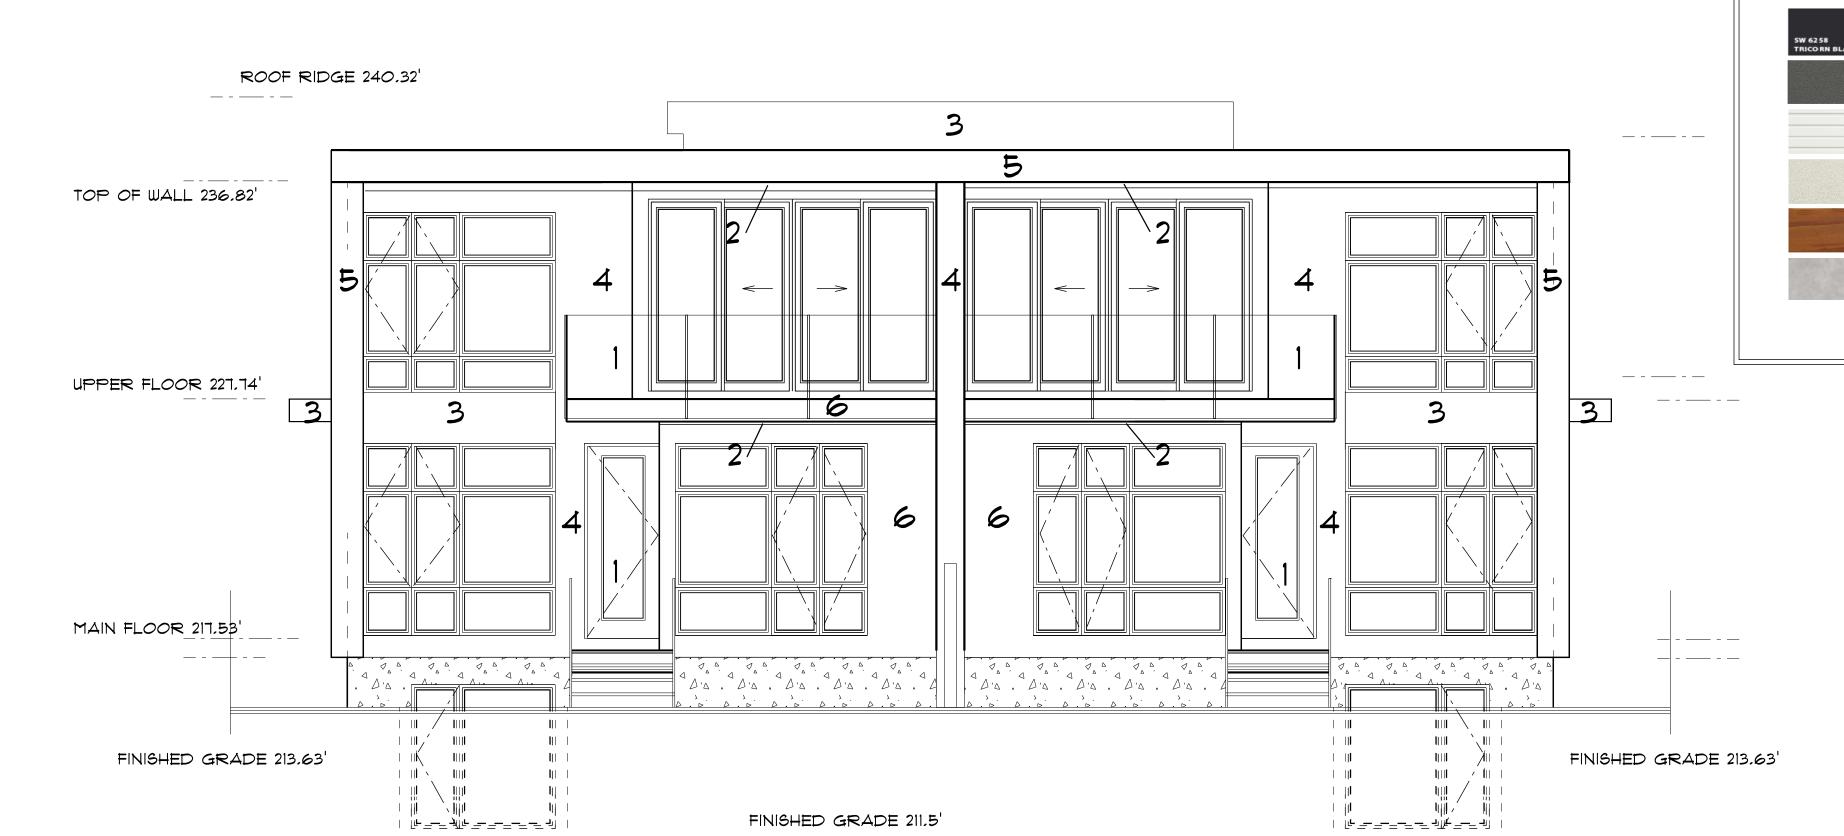

**MAY** , 2022

**Elevations and Renderings** Corrected

**Team Review Revisions submitted ADP Revisions submitted** November, 2020 Issued for Rezoning Application



SOUTH & EAST Drawing ELEVATIONS Drawn By B.C. Date MARCH 2020

1/4" : 1'-0"

401 WEST 16th STREET NORTH VANCOUVER

SOUTH ELEVATION

-THE GENERAL CONTRACTOR SHALL VERIFY ALL DIMENSIONS AND CONDITIONS PRIOR TO COMMENCING ANY WORK AND REPORT ANY DESCREPANCIES TO THE DESIGNER.
-THE DESIGNER WILL NOT BE RESPONSABLE FOR COSTS INCURRED TO THE OWNER OR CONTRACTOR THROUGH ERRORS OR OMISSIONS ON PLANS OR SPECIFICATIONS AFTER THE BUILDING PERMIT HAS BEEN ISSUED THESE PLANS AND CONCEPTS ARE PROTECTED BY COPYRIGHT AND MAY NOT BE REPRODUCED IN WHOLE OR IN PART WITHOUT THE WRITTEN CONSENT OF THE DESIGNER, THESE PLANS ARE THE PROPERTY OF THE DESIGNER AND NO PLAN OR PART THEREOF SHALL BE COPIED DISCLOSED TO OTHERS OR USED FOR ANY OTHER PROJECT WITHOUT THE WRITTEN CONSENT OF THE DESIGNER VISUAL CONTACT WITH THESE DRAWINGS SHALL CONSTITUTE CONCLUSIVE EVIDENCE OF ACCEPTANCE OF THESE RESTRICTIONS.

**MATERIAL LEGEND:** 

\_ - - \_ - \_

7. Concrete

1. Glass, light grey tint (All windows, glass doors, and deck / balcony guard panels)

3. Fiber Cement Panel; TuffBlock Steel colour (metal flashing painted to match)


4. Fiber Cement Panel; Metalic Series combination of Ribbed / Non-Ribbed, Ivory

5. Fiber Cement Panel; Arch Block Series, Gray (metal flashing painted to match)

6. Cross Laminated Edge-Glued Engineered Solid Wood Panel (incld. <u>All</u> soffit)

8. Window mullion and door colour to match 3. TuffBlock Steel colour

2. Reveal, Painted finish Sherwin Williams SW 6258 TRICORN BLACK

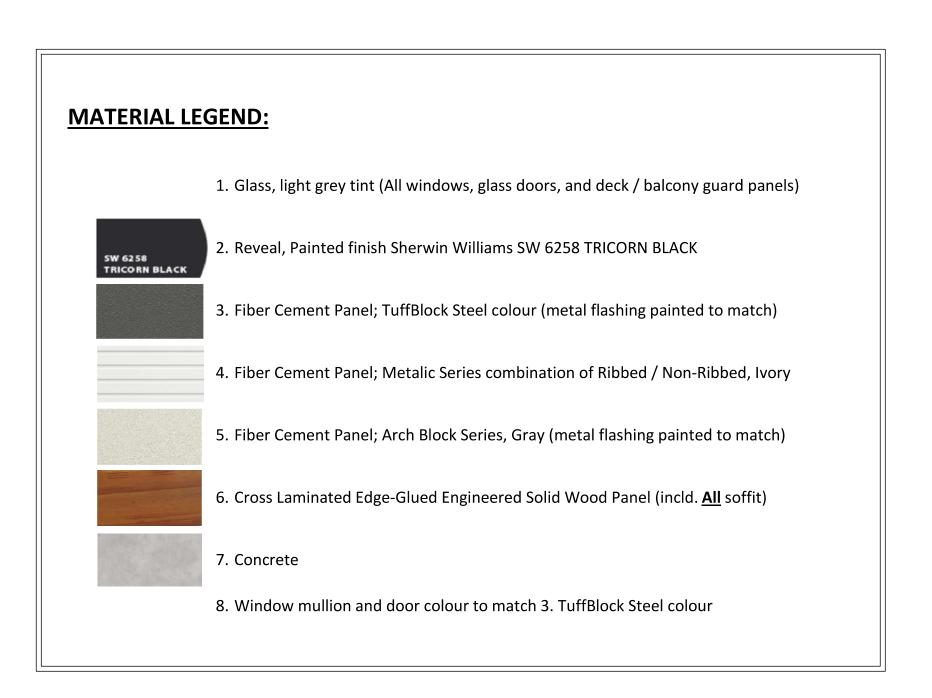



NORTH ELEVATION



EAST ELEVATION

THE GENERAL CONTRACTOR SHALL VERIFY ALL DIMENSIONS AND CONDITIONS PRIOR TO COMMENCING ANY WORK AND REPORT ANY DESCREPANCIES TO THE DESIGNER.

THE DESIGNER WILL NOT BE RESPONSABLE FOR COSTS INCURRED TO THE OWNER OR CONTRACTOR THROUGH ERRORS OR OMISSIONS ON PLANS OR SPECIFICATIONS AFTER THE BUILDING PERMIT HAS BEEN ISSUED THESE PLANS AND CONCEPTS ARE PROTECTED BY COPYRIGHT AND MAY NOT BE REPRODUCED IN WHOLE OR IN PART WITHOUT THE WRITTEN CONSENT OF THE DESIGNER. THESE PLANS ARE THE PROPERTY OF THE DESIGNER AND NO PLAN OR PART THEREOF SHALL BE COPIED DISCLOSED TO OTHERS OR USED FOR ANY OTHER PROJECT WITHOUT THE WRITTEN CONSENT OF THE DESIGNER. VISUAL CONTACT WITH THESE DRAWINGS SHALL CONSTITUTE CONCLUSIVE EVIDENCE OF ACCEPTANCE OF THESE RESTRICTIONS.

# consultants



INSPIRATION DESIGN

604-365-9191



NORTH # EAST Drawing ELEVATIONS

Drawn By B.C. Date MARCH 2020

Scale 1/4" : 1'-0"



WEST ELEVATION





INSPIRATION DESIGN

604-365-9191

November, 2020 Issued for Rezoning Application





SOUTH & WEST ELEVATIONS

Drawn By B.C. Date MARCH 2020




NOTE:

THE GENERAL CONTRACTOR SHALL VERIFY ALL DIMENSIONS AND CONDITIONS PRIOR TO COMMENCING ANY WORK AND REPORT ANY DESCREPANCIES TO THE DESIGNER.

-THE DESIGNER WILL NOT BE RESPONSABLE FOR COSTS INCURRED TO THE OWNER OR CONTRACTOR THROUGH ERRORS OR OMISSIONS ON PLANS OR SPECIFICATIONS AFTER THE BUILDING PERMIT HAS BEEN ISSUED -THESE PLANS AND CONCEPTS ARE PROTECTED BY COPYRIGHT AND MAY NOT BE REPRODUCED IN WHOLE OR IN PART WITHOUT THE WRITTEN CONSENT OF THE DESIGNER. THESE PLANS ARE THE PROPERTY OF THE DESIGNER AND NO PLAN OR PART THEREOF SHALL BE COPIED DISCLOSED TO OTHERS OR USED FOR ANY OTHER PROJECT WITHOUT THE WRITTEN CONSENT OF THE DESIGNER. VISUAL CONTACT WITH THESE DRAWINGS SHALL CONSTITUTE CONCLUSIVE EVIDENCE OF ACCEPTANCE OF THESE RESTRICTIONS.

401 WEST 16th STREET NORTH YANCOUVER

BUILDING & GARAGE SOUTH ELEVATION

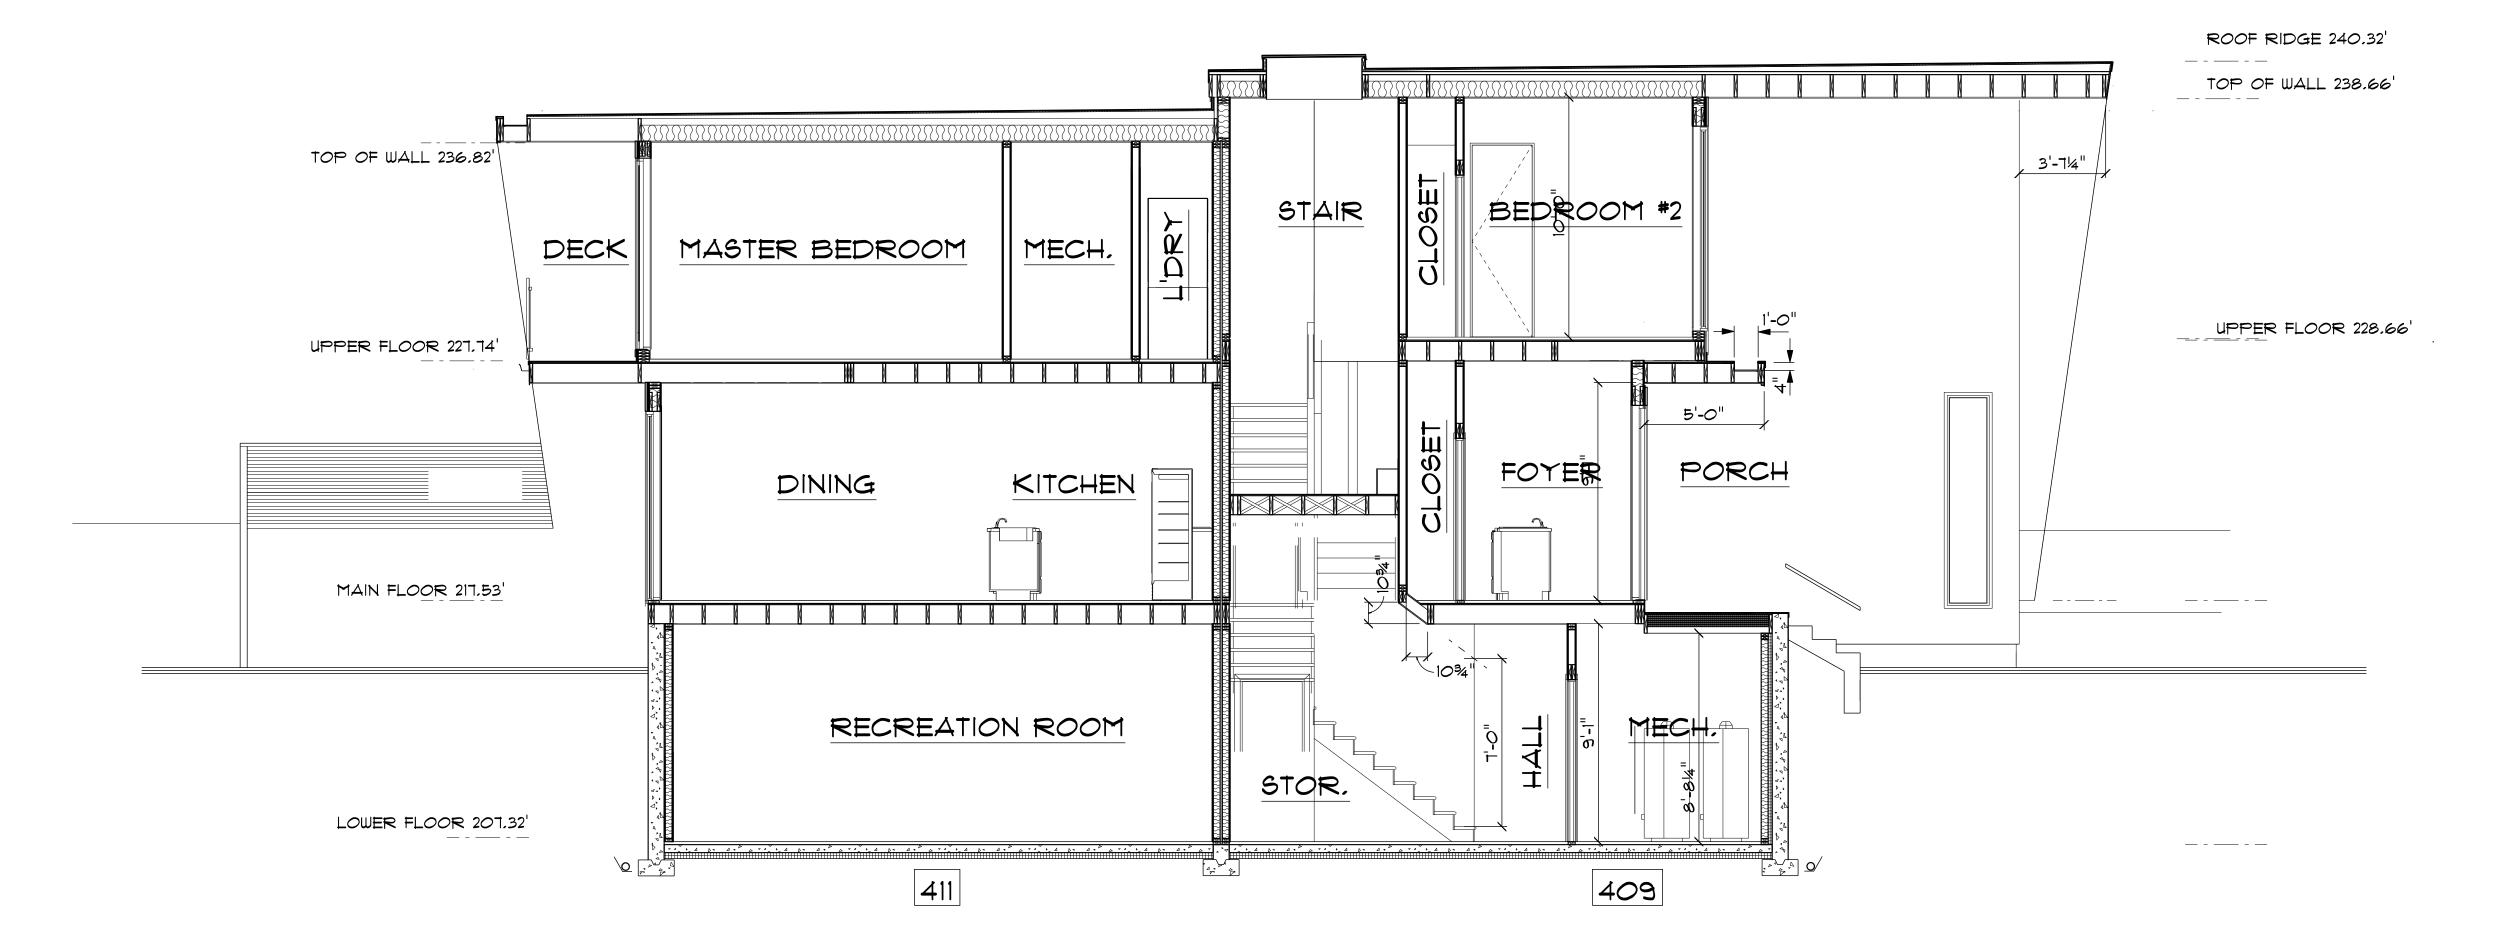

SECTION A

# 4'-0" **ROOF RIDGE 240.32**' 5'-10" TOP OF WALL 238.66' TOP OF WALL 236,82' MASTER BEDROOM DECK |ENSUITE| UPPER FLOOR 228.66 UPPER FLOOR 227,74' DINING KITCHEN KITCHEN DINING LIVING RM MAIN FLOOR 217.53 RECREATION ROOM RECREATION ROOM BEDROOM #3 LOWER FLOOR 201.32'

SECTION B

409

407

THE GENERAL CONTRACTOR SHALL VERIFY ALL DIMENSIONS AND CONDITIONS PRIOR TO COMMENCING ANY WORK AND REPORT ANY DESCREPANCIES TO THE DESIGNER.

THE DESIGNER WILL NOT BE RESPONSABLE FOR COSTS INCURRED TO THE OWNER OR CONTRACTOR THROUGH ERRORS OR OMISSIONS ON PLANS OR SPECIFICATIONS AFTER THE BUILDING PERMIT HAS BEEN ISSUED THESE PLANS AND CONCEPTS ARE PROTECTED BY COPYRIGHT AND MAY NOT BE PEED COLUMN. NOT BE REPRODUCED IN WHOLE OR IN PART WITHOUT THE WRITTEN CONSENT OF THE DESIGNER. THESE PLANS ARE THE PROPERTY OF THE DESIGNER AND NO PLAN OR PART THEREOF SHALL BE COPIED DISCLOSED TO OTHERS OR USED FOR ANY OTHER PROJECT WITHOUT THE WRITTEN CONSENT OF THE DESIGNER, VISUAL CONTACT WITH THESE DRAWINGS SHALL CONSTITUTE CONCLUSIVE EVIDENCE OF ACCEPTANCE OF THESE RESTRICTIONS.

# consultants



INSPIRATION DESIGN

604-365-9191

MAY, 2022 Elevations and Rendering

Corrected **Team Review Revisions submitted** November, 2020 Issued for Rezoning Application






SECTIONS

Drawn By B.C. Date MARCH 2020

1/4" : 1'-0"




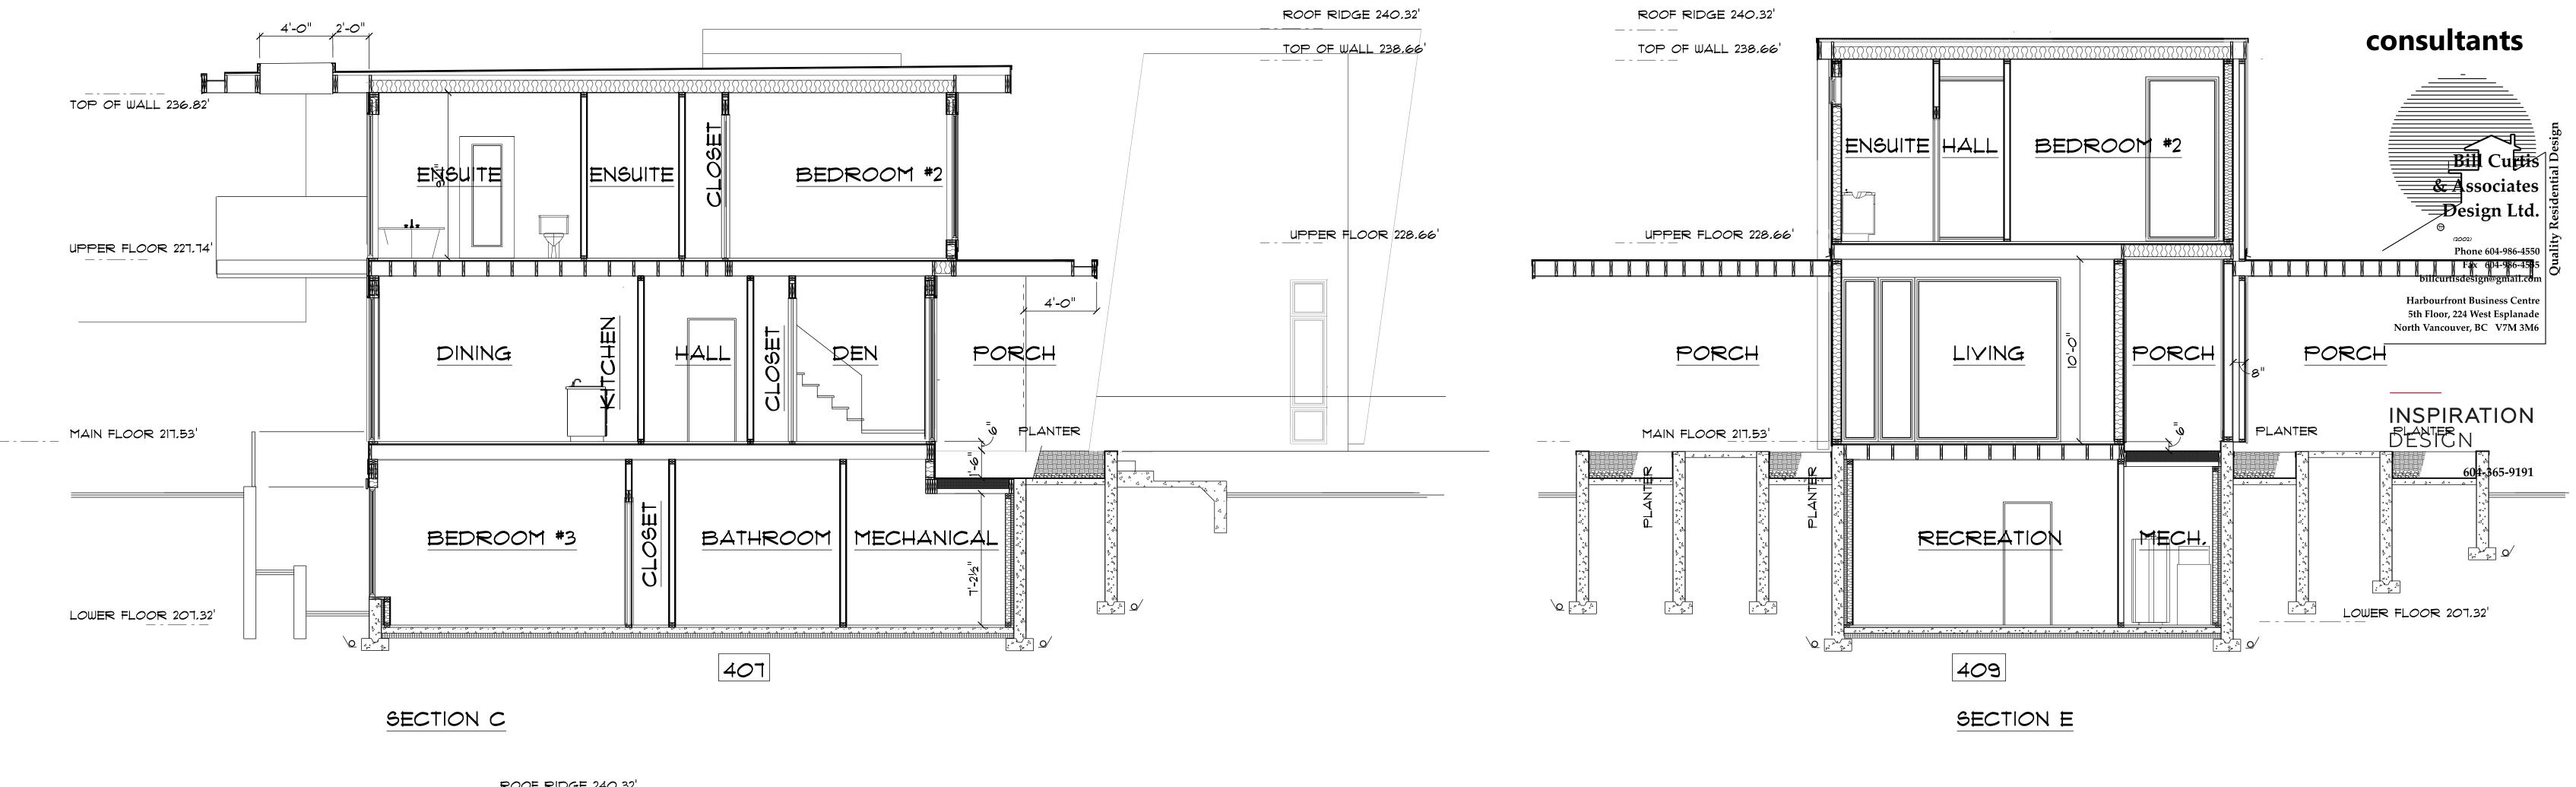



SECTIONS

B.C. Date MARCH 2020

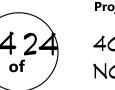

-THE GENERAL CONTRACTOR SHALL VERIFY ALL DIMENSIONS AND CONDITIONS PRIOR TO COMMENCING ANY WORK AND REPORT ANY DESCREPANCIES TO THE DESIGNER.
-THE DESIGNER WILL NOT BE RESPONSABLE FOR COSTS INCURRED TO THE OWNER OR CONTRACTOR THROUGH ERRORS OR OMISSIONS ON PLANS OR SPECIFICATIONS AFTER THE BUILDING PERMIT HAS BEEN ISSUED THESE PLANS AND CONCEPTS ARE PROTECTED BY COPYRIGHT AND MAY NOT BE RESPONDED IN WHATER OR IN PART WITHOUT THE WINTEN CONSENT.

NOT BE REPRODUCED IN WHOLE OR IN PART WITHOUT THE WRITTEN CONSENT OF THE DESIGNER, THESE PLANS ARE THE PROPERTY OF THE DESIGNER AND

NO PLAN OR PART THEREOF SHALL BE COPIED DISCLOSED TO OTHERS OR USED FOR ANY OTHER PROJECT WITHOUT THE WRITTEN CONSENT OF THE DESIGNER, VISUAL CONTACT WITH THESE DRAWINGS SHALL CONSTITUTE CONCLUSIVE EVIDENCE OF ACCEPTANCE OF THESE RESTRICTIONS.



NORTH EAST CORNER



NORTH FACE



NORTH WEST CORNER



ENTRY TO #407



#409 FRONT YARD



SOUTH EAST BUILDING
CORNER



SOUTH WEST BUILDING
CORNER



REAR YARDS



SOUTH WEST SITE CORNER



SOUTH EAST GARAGE

NOTE:

THE GENERAL CONTRACTOR SHALL VERIFY ALL DIMENSIONS AND CONDITIONS PRIOR TO COMMENCING ANY WORK AND REPORT ANY DESCREPANCIES TO THE DESIGNER.


THE DESIGNER WILL NOT BE RESPONSABLE FOR COSTS INCURRED TO THE OWNER OR CONTRACTOR THROUGH ERRORS OR OMISSIONS ON PLANS OR SPECIFICATIONS AFTER THE BUILDING PERMIT HAS BEEN ISSUED THESE PLANS AND CONCEPTS ARE PROTECTED BY COPYRIGHT AND MAY NOT BE REPRODUCED IN WHOLE OR IN PART WITHOUT THE WRITTEN CONSENT OF THE DESIGNER. THESE PLANS ARE THE PROPERTY OF THE DESIGNER AND NO PLAN OR PART THEREOF SHALL BE COPIED DISCLOSED TO OTHERS OR USED FOR ANY OTHER PROJECT WITHOUT THE WRITTEN CONSENT OF THE DESIGNER. VISUAL CONTACT WITH THESE DRAWINGS SHALL CONSTITUTE CONCLUSIVE EVIDENCE OF ACCEPTANCE OF THESE RESTRICTIONS.

# consultants



INSPIRATION DESIGN

604-365-9191

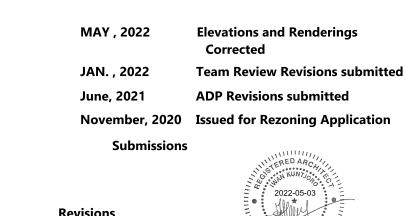



RENDERINGS

Drawn By B.C. Date MARCH 2020

Scale NOT TO A SCALE

Project





DECEMBER 21 @ 10 am



DECEMBER 21 @ 12 pm



DECEMBER 21 @ 2 pm





JUNE 21 @ 2 pm



JUNE 21 @ 10 am



JUNE 21 @ 12 pm

MARCH 21 @ 12 pm



MARCH 21 @ 2 pm



October 27, 2020 Issued for Rezoning Application

consultants

INSPIRATION

DESIGN

ARCHITECTURE INC.  $7557~10^{ ext{TH}}$  Avenue. Burnaby, BC - V3N 2S1 (778)999-0098  $\mid$  ikuntjoro.arch@gmail.com

SUN SHADOWS

Drawn By B.C. Date MARCH 2020





THE GENERAL CONTRACTOR SHALL VERIFY ALL DIMENSIONS AND CONDITIONS PRIOR TO COMMENCING ANY WORK AND REPORT ANY DESCREPANCIES TO THE DESIGNER.

THE DESIGNER WILL NOT BE RESPONSABLE FOR COSTS INCURRED TO THE OWNER OR CONTRACTOR THROUGH ERRORS OR OMISSIONS ON PLANS OR SPECIFICATIONS AFTER THE BUILDING PERMIT HAS BEEN ISSUED THESE PLANS AND CONCEPTS ARE PROTECTED BY COPYRIGHT AND MAY NOT BE REPRODUCED IN WHOLE OR IN PART WITHOUT THE WRITTEN CONSENT OF THE DESIGNER, THESE PLANS ARE THE PROPERTY OF THE DESIGNER AND NO PLAN OR PART THEREOF SHALL BE COPIED DISCLOSED TO OTHERS OR USED FOR ANY OTHER PROJECT WITHOUT THE WRITTEN CONSENT OF THE DESIGNER, VISUAL CONTACT WITH THESE DRAWINGS SHALL CONSTITUTE CONCLUSIVE EVIDENCE OF ACCEPTANCE OF THESE RESTRICTIONS.



MARCH 21 @ 10 am

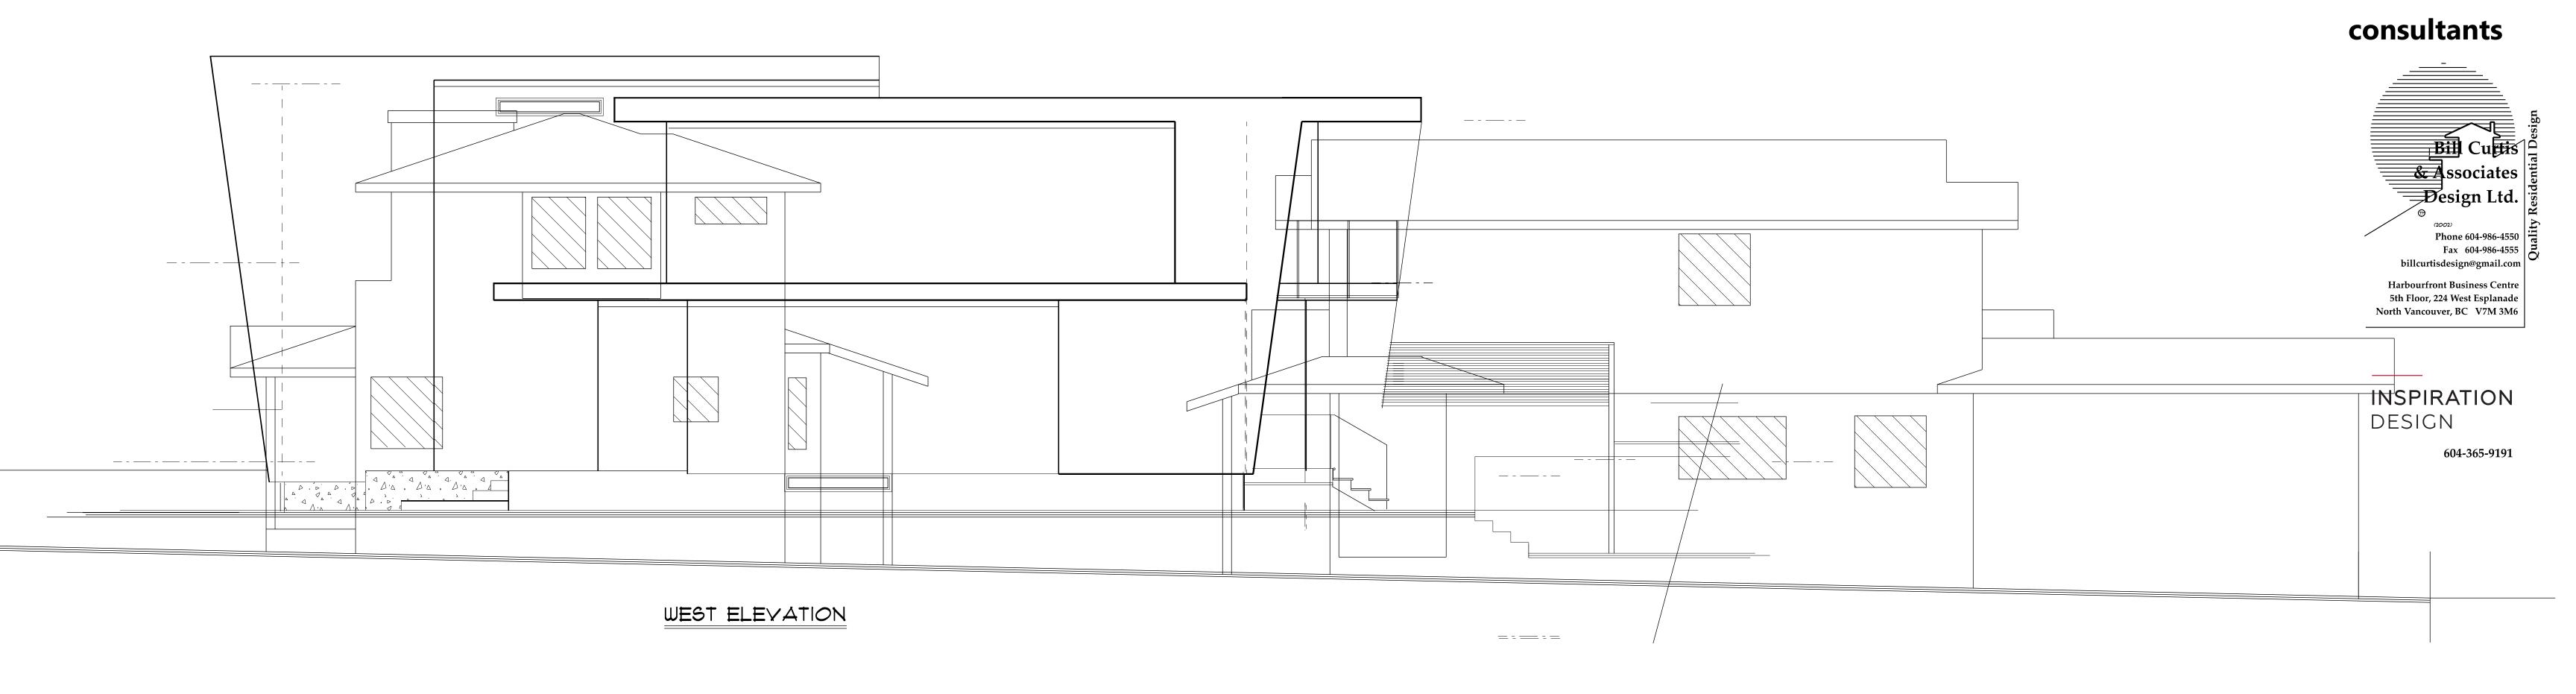


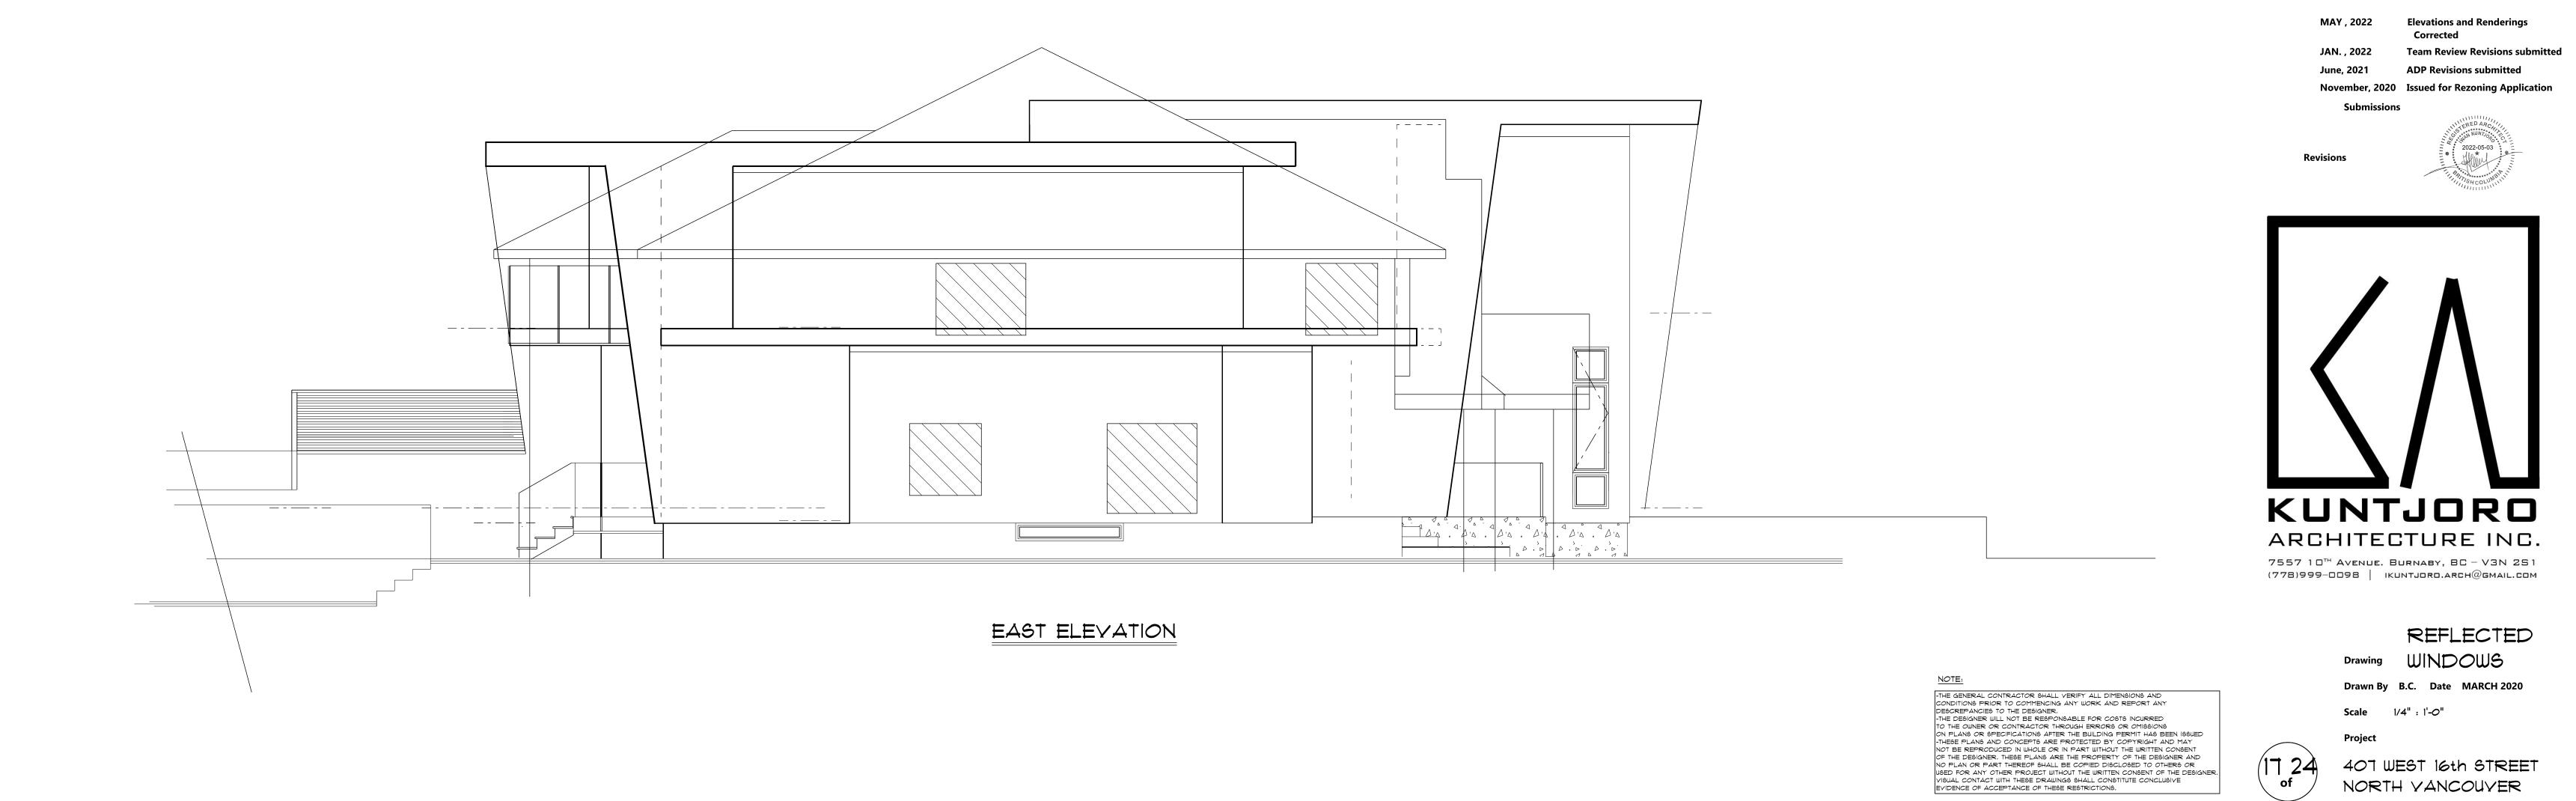


Scale 1/4" : 1'-0"

407 WEST 16th STREET

NORTH VANCOUVER

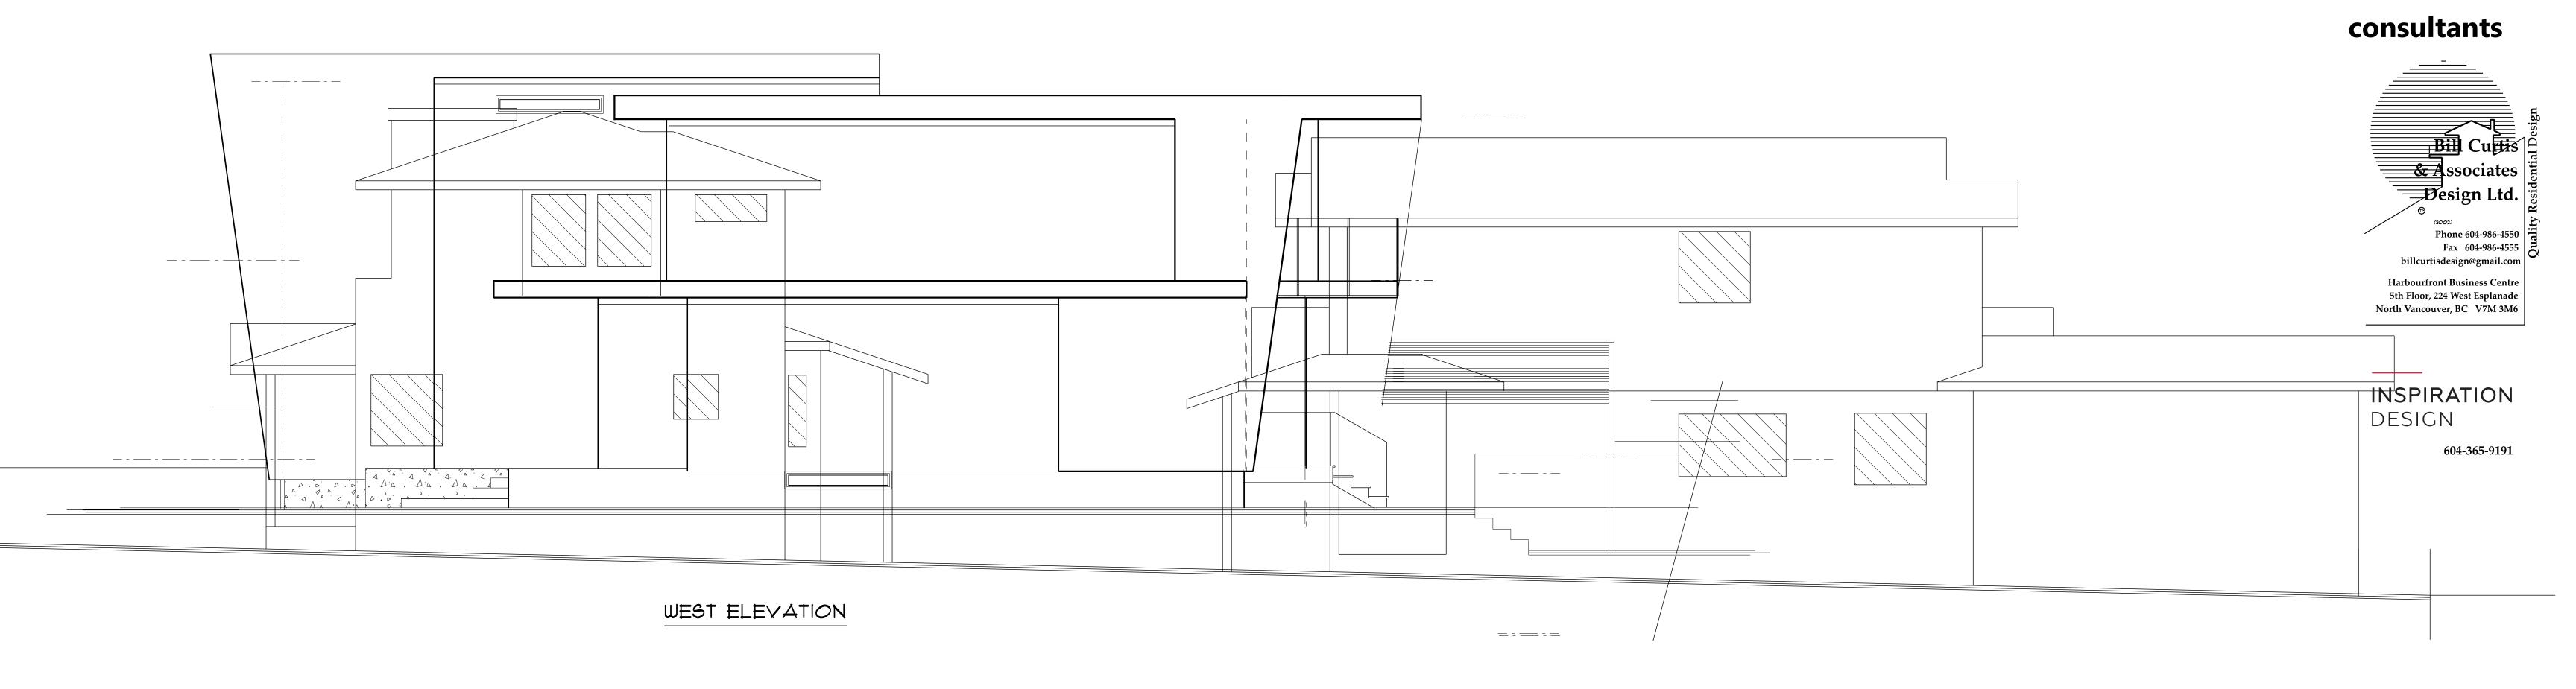

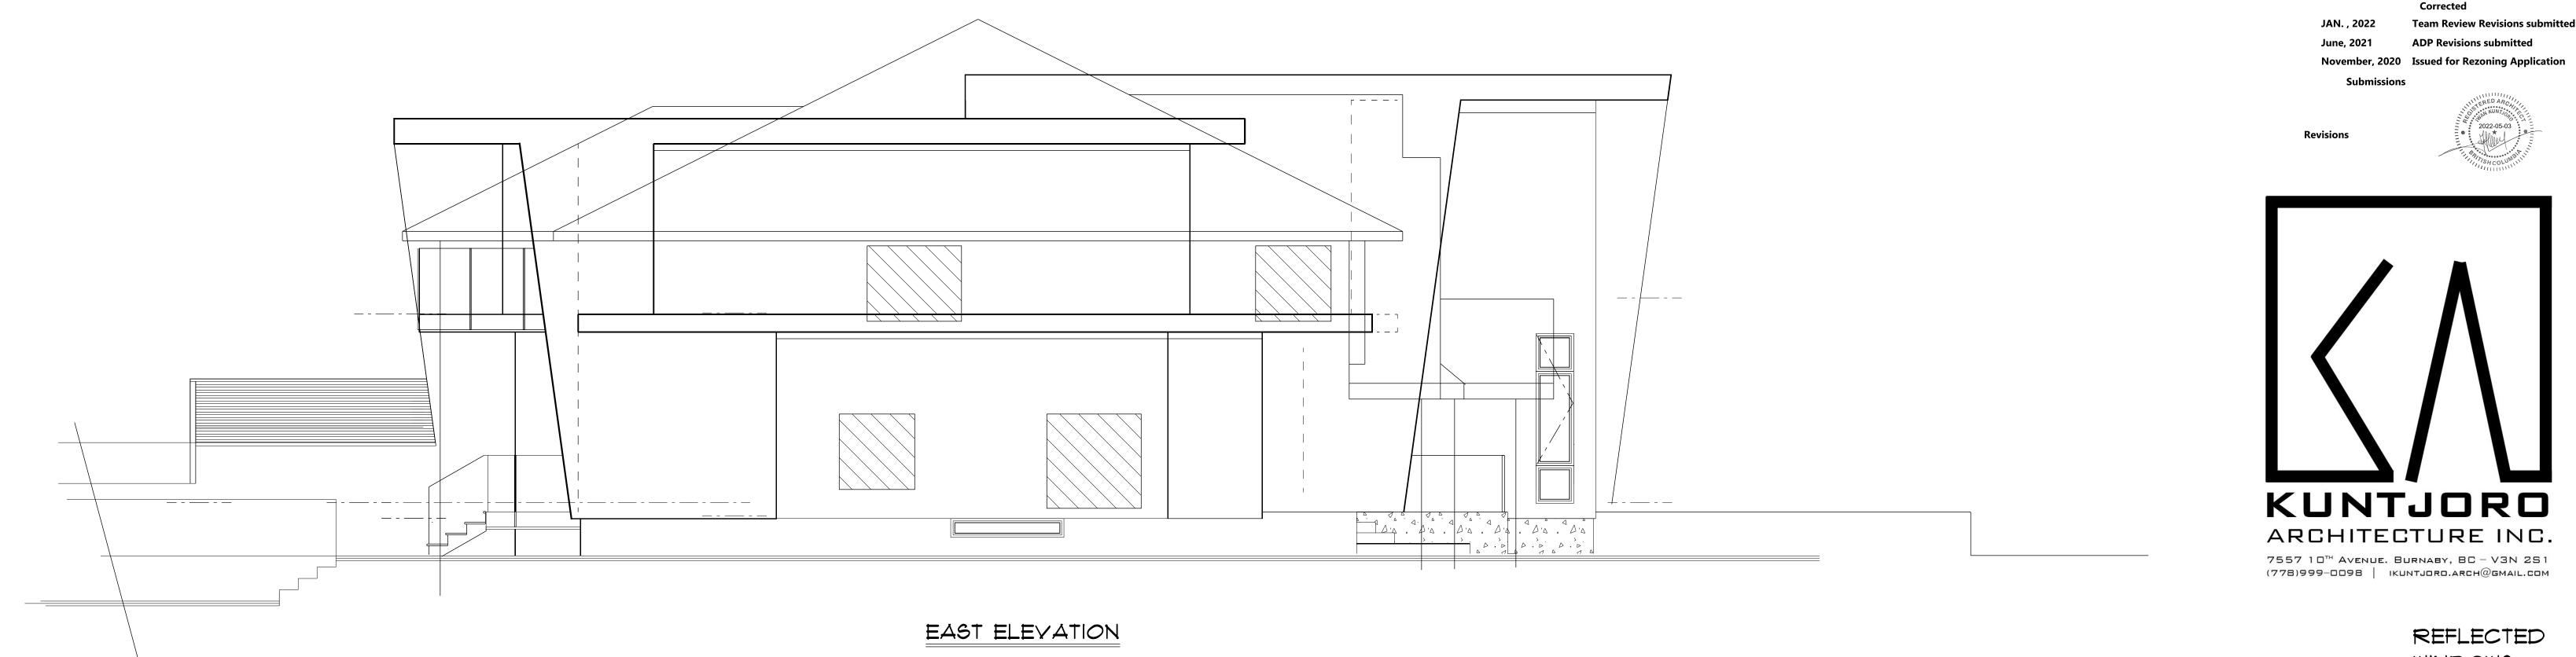

MAY, 2022

**Elevations and Renderings** 

KUNTJORO ARCHITECTURE INC.

WINDOWS


Drawn By B.C. Date MARCH 2020

Scale 1/4" : 1'-0"

THE GENERAL CONTRACTOR SHALL VERIFY ALL DIMENSIONS AND CONDITIONS PRIOR TO COMMENCING ANY WORK AND REPORT ANY DESCREPANCIES TO THE DESIGNER.

THE DESIGNER WILL NOT BE RESPONSABLE FOR COSTS INCURRED TO THE OWNER OR CONTRACTOR THROUGH ERRORS OR OMISSIONS ON PLANS OR SPECIFICATIONS AFTER THE BUILDING PERMIT HAS BEEN ISSUED THESE PLANS AND CONCEPTS ARE PROTECTED BY COPYRIGHT AND MAY NOT BE REPRODUCED IN WHOLE OR IN PART WITHOUT THE WRITTEN CONSENT OF THE DESIGNER, THESE PLANS ARE THE PROPERTY OF THE DESIGNER AND NO PLAN OR PART THEREOF SHALL BE COPIED DISCLOSED TO OTHERS OR USED FOR ANY OTHER PROJECT WITHOUT THE WRITTEN CONSENT OF THE DESIGNER, VISUAL CONTACT WITH THESE DRAWINGS SHALL CONSTITUTE CONCLUSIVE EVIDENCE OF ACCEPTANCE OF THESE RESTRICTIONS.

# WEST 16th STREET

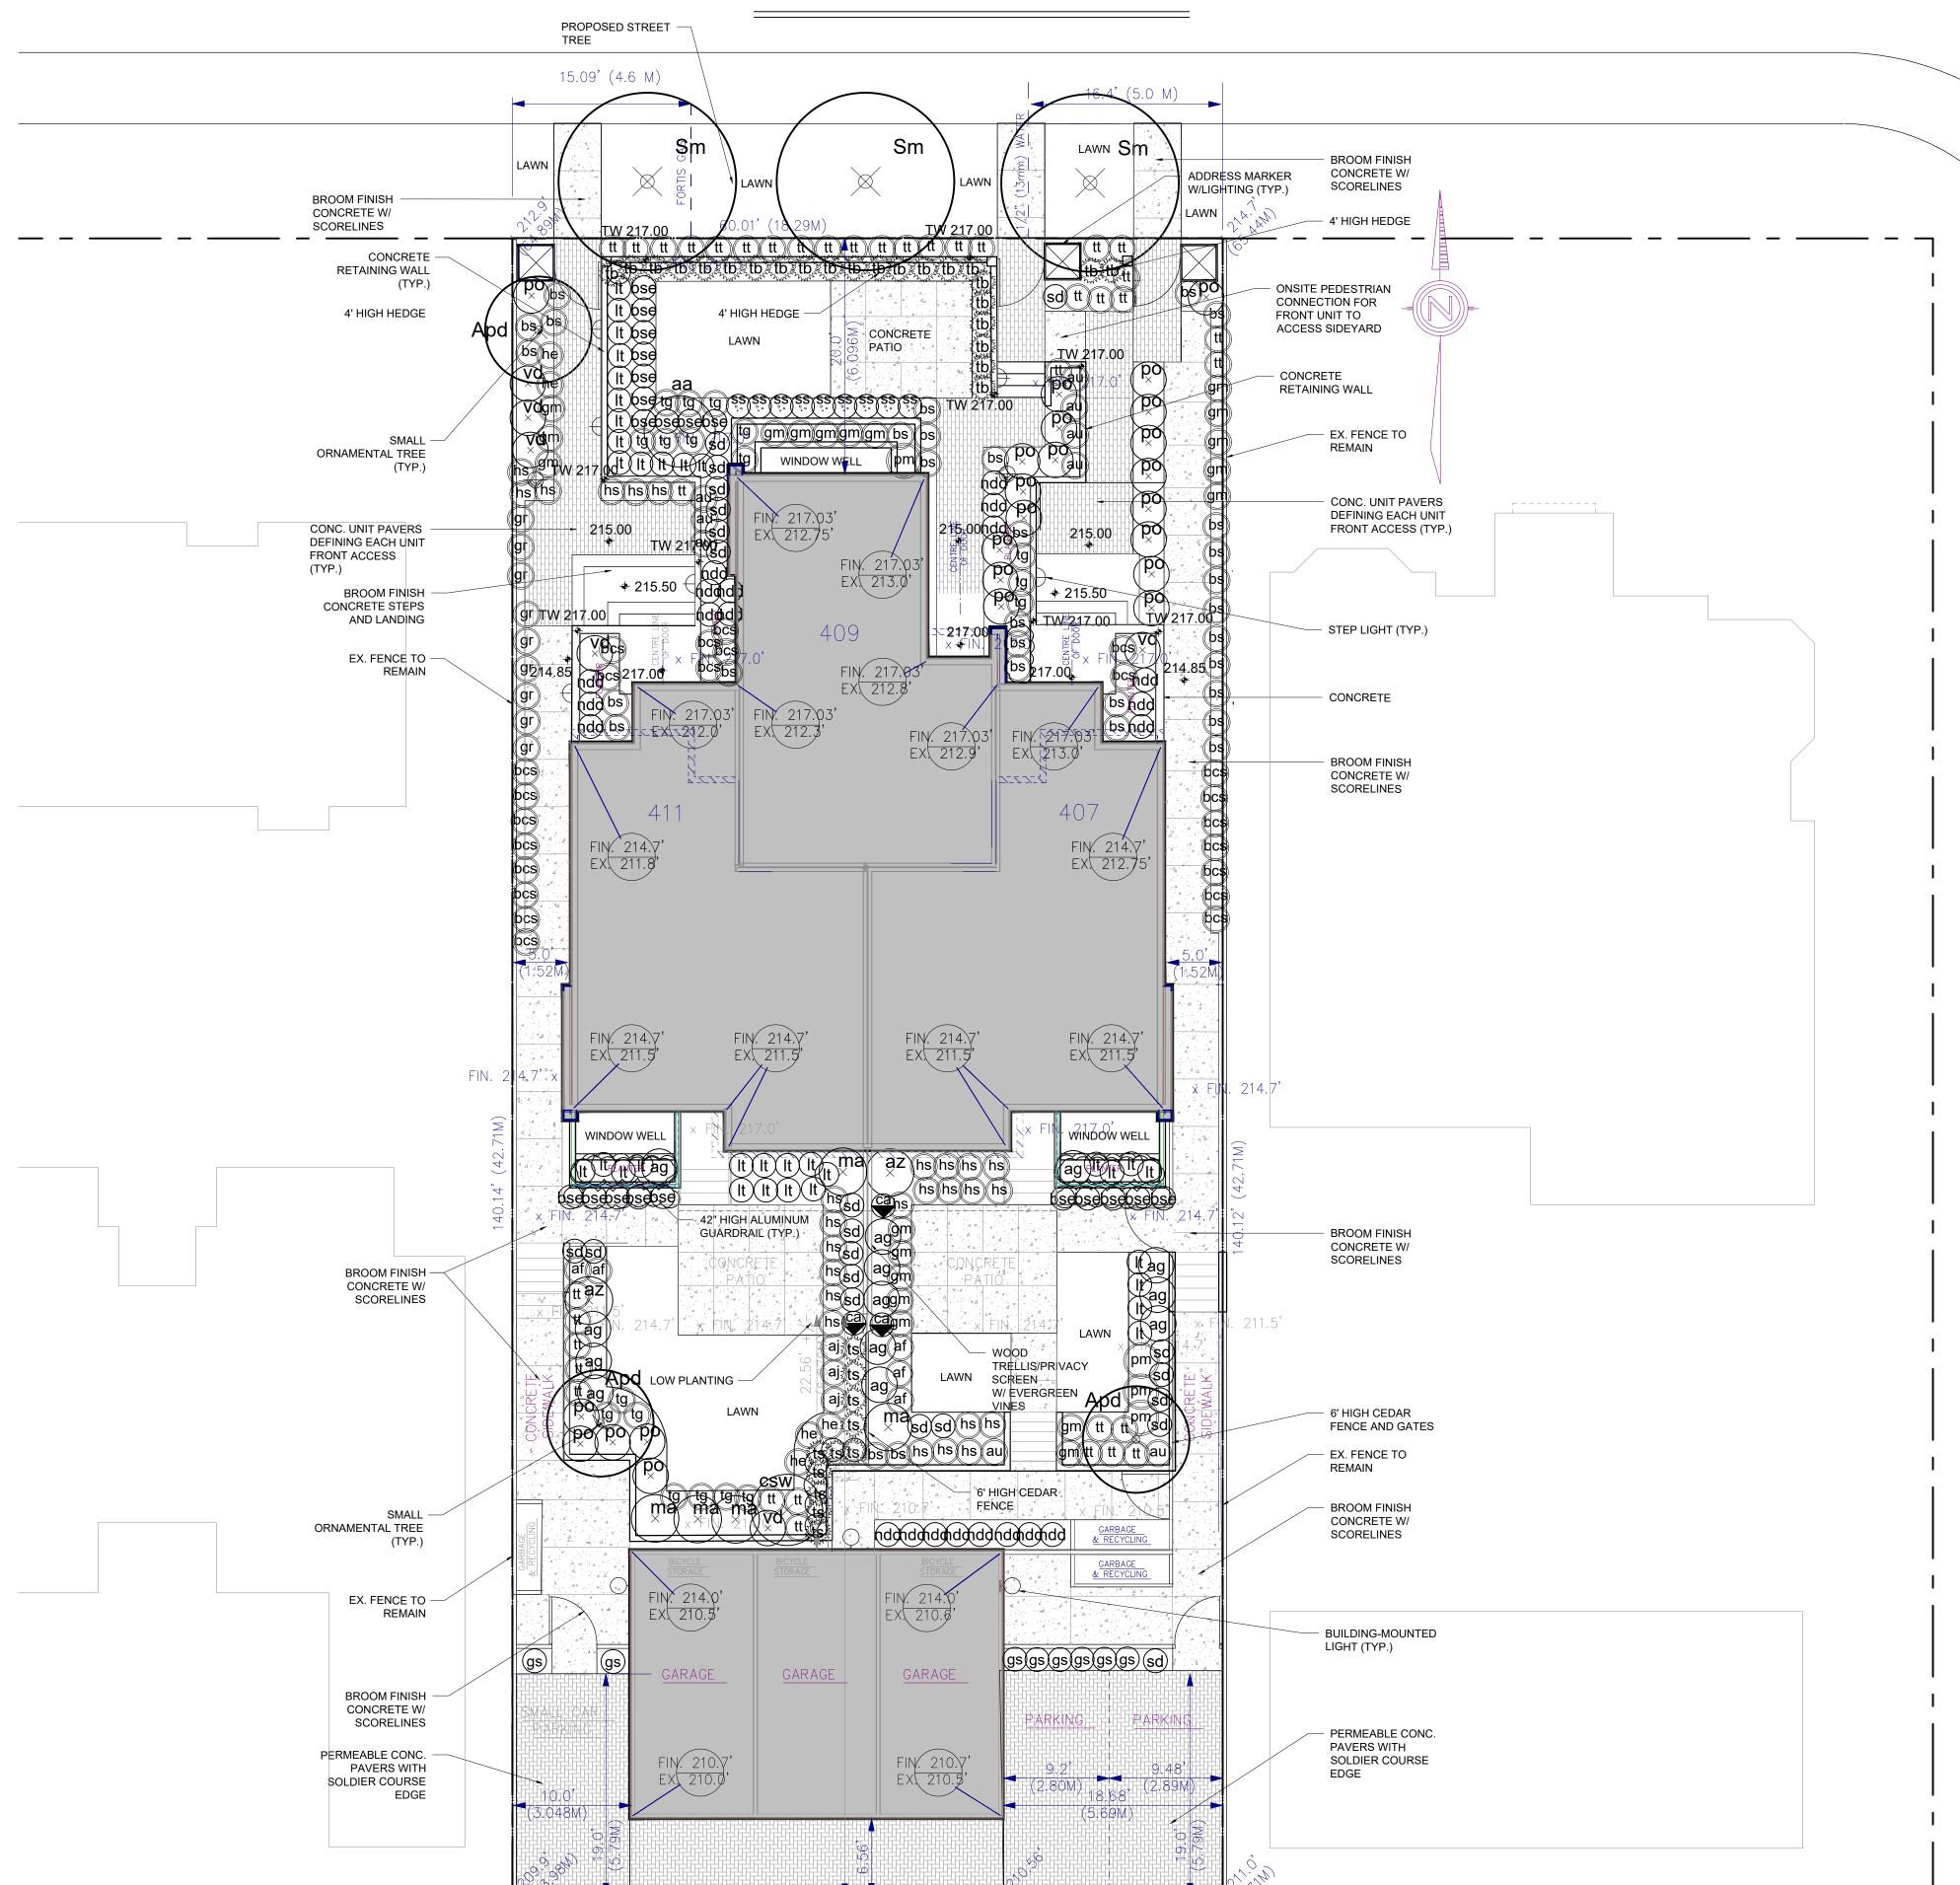

60.01' (18.29M)

4.43' (1.35 M)<sub>|</sub> |1.64' (0.50 M)





Proposed Tree Planting



Mixed Plantings of Shrubs, Perennials and Groundcovers



Evergreen Hedge




Holland 65mm concrete pavers with soldier course edge by Abbotsford Concrete Products ('Natural' colour)



80mm thick "Aquapave" permeable conc. pavers with soldier course edge by Abbotsford Conc. - Holland pavers ('Charcoal' colour)



Broom-finish concrete with scorelines

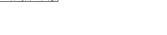

- Pathway light
- Building-mounted light

#### NOTES:

- 1. All landscape work shall be carried out in accordance with the current edition of the Canadian Landscape Standard published by CSLA/CNTA and the contract specification.
- 2. Growing medium in accordance with the current edition of the Canadian Landscape Standard shall be provided to the following minimum depths/dimensions: Grass Areas - 150 mm (6") Shrubs, Groundcovers, Vines & Perennials - 450 mm (18") Trees (Onsite) - Minimum 300 mm (1') of topsoil around the rootball compacted to 85% Std. Proctor Density.
- 3. Ensure excavation or fill adjacent to existing trees does not exceed 6" (15cm) depth.

4. A low-flow, high efficiency irrigation scheme	e shall be installed.

Street trees (Offsite) - Min. 10cu.m. topsoil per tree as per CNV details

		40	7 W16th St. Plant List				
CODE	QTY	BOTANICAL	COMMON	SIZE	SPACING	TYPE	NATIVE
Apd	3	Acer palmatum 'Dissectum atropurpureum'	Purple Japanese maple	6', #25 pot	as shown	tree	nonnativ
Sm	3	Stewartia monadelpha	Orangebark Stewartia	8cm Cal	as shown	tree	nonnati
aa	1	Amelanchier alnifolia	Serviceberry	#5 pot	as shown	shrub	native
az	2	Azalea 'Golden Lights'	Golden Lights Azalea	#3 pot	as shown	shrub	nonnati
ag	13	Azalea japonica 'Glacier'	Japanese azalea	#2 pot	as shown	shrub	nonnati
bse	20	Buxus sempervirens 'Elegantissima'	Variegated Boxwood	# 2 pot	as shown	shrub	nonnati
ca	3	Clematis armandii	Evergreen clematis	#3 pot	as shown	shrub	nonnati
csw	1	Cornus sericea 'White Gold'	Variegated red osier dogwood	#3 pot	as shown	shrub	native
It	34	Lavandula angustifolia 'Twickle Purple'	English Lavender	#2 pot	as shown	shrub	nonnati
ma	5	Mahonia aquifolium	Oregon grape	#3 pot	as shown	shrub	native
ndd	22	Nandina domestica 'Harbour dwarf'	Heavenly bamboo	#2 pot	as shown	shrub	nonnati
ро	24	Prunus laurocerasus 'Otto Luyken'	Otto Luyken Laurel	#3 pot	as shown	shrub	nonnati
sd	21	Spiraea densiflora	Mountain Spiraea	#2 pot	as shown	shrub	native
tb	24	Taxus baccata	Irish yew	#2 pot	as shown	shrub	nonnati
ts	11	Thuja occidentalis 'Smaragd'	Emerald cedar	1.8 m	as shown	shrub	nonnati
vd	6	Viburnum davidii	David's viburnum	#3 pot	as shown	shrub	nonnati
af	5	Aquilegia formosa	Western Columbine	# 1 pot	as shown	perennial	native
aj	3	Astilbe japonica	Astilbe	# 1 pot	as shown	perennial	nonnati
bcs	23	Bergenia cordifolia 'Silver Light'	Bergenia	# 1 pot	as shown	perennial	nonnati
gm	20	Geranium macrorrhizum	Hardy geranium	# 1 pot	as shown	perennial	nonnati
gr	9	Geranium 'Russel Pritchard'	Hardy geranium	# 1 pot	as shown	perennial	nonnati
hs	26	Hemerocallis 'Stella d'Oro'	Daylily	# 1 pot	as shown	perennial	nonnati
he	5	Hosta sieboldiana elegans	Plantain lily	# 1 pot	as shown	perennial	native
tg	18	Tellima grandiflora	Fringecup	# 1 pot	as shown	perennial	native
tt	38	Tiarella trifoliata	Foamflower	# 1 pot	as shown	perennial	native
au	9	Arctostaphylos uva-ursi 'Massachusetts'	Kinnikinnick	# 2 pot	as shown	ground cover	nonnati
gs	8	Gaultheria shallon	Salal	# 1 pot	as shown	ground cover	native
SS	9	Schizachyrium scoparium	Little bluestem	# 2 pot	as shown	grass	nonnati
bs	31	Blechnum spicant	Deer fern	# 2 pot	as shown	fern	native
	T .					1 -	

Western sword fern

# 1 pot as shown fern native

Polystichum munitum

LANDSCAPE PLAN


THIS PLAN AND DESIGN IS PROTECTED BY COPYRIGHT AND SHALL NOT BE USED FOR ANY PURPOSE WITHOUT WRITTEN PERMISSION FROM PD GROUP LANDSCAPE ARCHITECTURE LTD. REVISIONS No DATE DESCRIPTION 1 09/10/20 PLANTING AND MATERIALS ADDED 2 11/13/20 BIRD-FRIENDLY PLANTING ADDED 3 20/05/21 DRAFT REVS. PER ADP COMMENT PLANTING REVS. 5 29/04/22 STREET TREE ADDED PER CNV

ISSUE

1 11/09/20 ISSUED FOR PRELIMINARY REVIEW 2 09/10/20 ISSUED FOR DP 3 11/13/20 4 20/05/21 RE-ISSUED FOR DP DRAFT REVS. FOR COMMENT 5 21/05/21 RE-ISSUED FOR DP

RE-ISSUED FOR DP

6 29/04/22

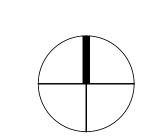

NORTH





PD Group Landscape Architecture Ltd

> 315 - 515 Houghton Road Kelowna BC, Canada, V1X 8B9 p: 604 904 9803

A-1 Group of Companies Dev.(71 5615 121A St.

Bill Curtis & Associates Inspiration Design

I. Kuntjoro Architect

Triplex Project 407 West 16th St.

NORTH VANCOUVER, B.C

Landscape Plan

DESIGNED	DR	
DRAWN	SK	
CHECKED	DR	
SCALE	1/8" = 1'-0"	
	11 Cont 2020	

PROJECT No. DWG No. 2007