351 3RD STREET WEST

ARCHITECTURE + INTERIOR DESIGN

MARCH 23, 2022

- SCHEMATIC DESIGN



LEGAL DESCRIPTION

LEGAL DESCRIPTION

DRAWING LIST

A401

01 GENERAL **COVER SHEET** G101 PROJECT DATA 02 ARCHITECTURAL SITE PLAN & ROOF PLAN SITE PHOTOS/ RUNNING STREET ELEVATIONS A101 LANE LEVEL A102 BIKE PARKING LEVEL MAIN FLOOR LEVEL A103 A104 2nd - 5th TYPICAL RESIDENTIAL LEVEL A200 A201 NORTH ELEVATION EAST ELEVATION A202 SOUTH ELEVATION A203 WEST ELEVATION A204 MATERIAL BOARD A300 NORTH-SOUTH BUILDING SECTIONS A301 NORTH-SOUTH BUILDING SECTIONS NORTH-SOUTH BUILDING SECTIONS A303 NORTH-SOUTH BUILDING SECTIONS A304 EAST-WEST BUILDING SECTIONS A305 EAST-WEST BUILDING SECTIONS A306 EAST-WEST BUILDING SECTIONS

ADAPTABLE UNIT GUIDELINES

ADAPTABLE UNIT PLANS TYPICAL

SHADOW STUDY - MARCH, JUNE

FSR OVERLAY DIAGRAMS - BELOW GRADE, LANE, LOBBY FSR OVERLAY DIAGRAMS - 2, 3, 4, 5, ROOF

SHADOW STUDY - SEPTEMBER, DECEMBER

LANDSCAPE

ARCHITECTURAL

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CLIENT

PROJECT STATISTICS

DATA SUMMARY

351 3rd Street West, North Vancouver, BC PROPERTY ADDRESS Lot 1, Bk 136 DL 271, G1 NWD , Plan 13998 LEGAL DESCRIPTION EXISTING ZONING CS-2 Comprehensive District PROPOSED ZONING Rental Apartments 15,019 s.f. EXISITING SITE AREA 1395.31 s.m. NET SITE AREA AFTER DEDICATIONS 13,052 s.f. 1212.57 s.m. **Rights-of-way included in Site Area

PROJECT DATA

	PERMITTED/ALLOWED	PR	OPOSED		
HEIGHT	6 STORIES**		64'-0"	19.5 m	
NUMBER OF FLOORS	6			6 Storeys	
RONT YARD (West 3rd Street)					
Building	6.1 m		0'-0"	0 m	
XTERIOR SIDE YARD (Forbes Avenue)					
Building	6.1 m		0'-0"	0 m	
NTERIOR SIDE YARD (East)					
Building	4.6 m		0'-0"	0 m	
REAR YARD (South Lane)					
Building	6.1 m		0'-0"	0 m	
LOOR SPACE RATIO	N/A FSR		Gross Floor Area		
Residential		2.27 FSR	34085.00 sf	3166.60 m2	
Circulation		0.31 FSR	4621.00 sf	429.30 m2	
Total		2.58 FSR	38706.00 sf	3595.90 m2	

** Height based on 2014 CNV OCP (page 30)

57367.00 sf 5329.57 m2

PROPOSED AREA SUMMARY

~ Based on 180 degree core Option

Proposed Op	tion	Gross	Area	FSR Exclu	sion (*)		Total F	SR		Floor Efficiency
B1 Level	Bike Storage	1,438.00 sf	133.59 m2	1,438.00 sf	133.59 m2	0.00 sf	0.00 m2	0.00	FSR	
	Residential Storage	1,399.00 sf	129.97 m2	1,399.00 sf	129.97 m2	0.00 sf	0.00 m2	0.00	FSR	
	Circulation	2,084.00 sf	193.61 m2	2,084.00 sf	193.61 m2	0.00 sf	0.00 m2	0.00	FSR	
Lane Level	Parking	8,847.00 sf	821.91 m2	8,847.00 sf	821.91 m2	0.00 sf	0.00 m2	0.00	FSR	
	Circulation	835.00 sf	77 .57 m2	835.00 sf	77.57 m2	0.00 sf	0.00 m2	0,00	FSR	
	Refuse & Recycling	348.00 sf	32.33 m2	277.00 sf	25. 7 3 m2	7 1.00 sf	6.60 m2	0.00	FSR	
	Service Room	241.00 sf	22.39 m2	241.00 sf	22.39 m2	0.00 sf	0.00 m2	0,00	FSR	
	Hydro	154.00 sf	14.31 m2	154.00 sf	14.31 m2	0.00 sf	0.00 m2	0.00	FSR	
	PMT Alcove	177.00 sf	16.44 m2	177.00 sf	16.44 m2	0.00 sf	0.00 m2	0,00	FSR	
	Storage	691.00 sf	64.20 m2	691.00 sf	64.20 m2	0.00 sf	0.00 m2	0.00	FSR	
	District Energy System	349.00 sf	32.42 m2	349.00 sf	32.42 m2	0.00 sf	0.00 m2	0.00	FSR	
Lobby Level	Residential	5, 79 3.00 sf	538.19 m2	0.00 sf	0.00 m2	5 7 93,00 sf	538.19 m2	0.39	FSR	85.1 %
	Circulation	1,013.00 sf	94.11 m2	0.00 sf	0.00 m2	1013.00 sf	94.11 m2	0.07	FSR	
	Adaptable Unit Exclusion	60,00 sf	5.57 m2	60.00 sf	5.5 7 m2	0.00 sf	0,00 m2	0.00	FSR	
	Indoor Amenity Area	956.00 sf	88.82 m2	956.00 sf	88.82 m2	0.00 sf	0.00 m2	0.00	FSR	
Level 2	Residential	7,073,00 sf	65 7 .10 m2	0.00 sf	0.00 m2	7073.00 sf	657.10 m2	0.47	FSR	88.7 %
	Circulation	902.00 sf	83.80 m2	0.00 sf	0.00 m2	902.00 sf	83.80 m2	0.06	FSR	
	Adaptable Unit Exclusion	60.00 sf	5.5 7 m2	60.00 sf	5.57 m2	0.00 sf	0.00 m2	0.00	FSR	
Level 3	Residential	7,073.00 sf	65 7 .10 m2	0.00 sf	0.00 m2	7 0 7 3.00 sf	65 7 .10 m2	0.47	FSR	88.7 %
	Circulation	902.00 sf	83.80 m2	0,00 sf	0.00 m2	902.00 sf	83,80 m2	0.06	FSR	
	Adaptable Unit Exclusion	60.00 sf	5.5 7 m2	60.00 sf	5.57 m2	0.00 sf	0.00 m2	0.00	FSR	
Level 4	Residential	7,073.00 sf	65 7 .10 m2	0.00 sf	0.00 m2	7 0 7 3.00 sf	65 7 .10 m2	0.47	FSR	88.7 %
	Circulation	902.00 sf	83.80 m2	0.00 sf	0.00 m2	902.00 sf	83.80 m2	0.06	FSR	
	Adaptable Unit Exclusion	60.00 sf	5.57 m2	60.00 sf	5.57 m2	0.00 sf	0.00 m2	0.00	FSR	
Level 5	Residential	7,073.00 sf	65 7 .10 m2	0.00 sf	0.00 m2	7 0 7 3.00 sf	65 7 .10 m2	0.47	FSR	88.7 %
	Circulation	902,00 sf	83.80 m2	0.00 sf	0.00 m2	902.00 sf	83.80 m2	0.03	FSR	
	Adaptable Unit Exclusion	60.00 sf	5.5 7 m2	60.00 sf	5.57 m2	0.00 sf	0.00 m2	0.00	FSR	
RoofLevel	Indoor Amenity Circulation	588.00 sf	54.63 m2	588.00 sf	54.63 m2	0.00 sf	0.00 m2	0.00	FSR	
	Roof Amenity Storage	80.00 sf	7.43 m2	80.00 sf	7,43 m2	0.00 sf	0.00 m2	0.00	FSR	
	Outdoor Roof Deck	600,00 sf	55,74 m2	328.47 sf	30.52 m2	271.53 sf	25.23 m2	0,02	FSR	
			District of Schools in Contract of Schools in		The street of th		Section of the Control of the Contro		1000	

18744.47 sf 1741.42 m2

39048.53 sf

3627.73 m2

2.60 FSR

UNITS SUMMARY PER FLOOR

Residential Units

	#	TYPE	LEVEL	Strata Area	/ Unit	Total Strata	Area
Unit Type	L01	STUDIO	LL	528.00 sf	49.05 m2	528,00 sf	49.05 m2
Unit Type	L02	AMENITY	LL	956.00 sf	88.82 m2	956,00 sf	88.82 m2
Unit Type	L03	1 BED	LL	627.00 sf	58.25 m2	627.00 sf	58.25 m2
Unit Type	L04	1 BED	LĹ	5 7 0.00 sf	52.95 m2	5 7 0.00 sf	52.95 m2
Unit Type	L06	1 BED	LL	88 7 .00 sf	82.40 m2	88 7 .00 sf	82, 4 0 m2
Unit Type	L07	STUDIO	LL	5 49 .00 sf	51.00 m2	549.00 sf	51.00 m2
Unit Type	L08	STUDIO	LL	540.00 sf	50.17 m2	540.00 sf	50.17 m2
Unit Type	L09	2 BED	LĹ	888.00 sf	82.50 m2	888.00 sf	82.50 m2
Unit Type	L10	2 BED	LL	748.00 sf	69.49 m2	74 8.00 sf	69.49 m2
Unit Type	L11	1 BED	LL	50 7 .00 sf	47 .10 m2	50 7 .00 sf	47.10 m2
Unit Type	201	STUDIO	L2-L5	536.00 sf	49.80 m2	536,00 sf	49.80 m2
Unit Type	202	2 BED	L2-L5	938.00 sf	87.14 m2	938.00 sf	8 7 .14 m2
Unit Type	203	1 BED	L2-L5	541.00 sf	50.26 m2	541.00 sf	50.26 m2
Unit Type	204	1 BED	L2-L5	550.00 sf	51.10 m2	550,00 sf	51.10 m2
Unit Type	205	1 BED	L2-L5	5 7 2.00 sf	53.14 m2	5 7 2.00 sf	53.14 m2
Unit Type	206	1 BED	L2-L5	737.00 sf	68.47 m2	737.00 sf	68.47 m2
Unit Type	207	STUDIO	L2-L5	549.00 sf	51.00 m2	549.00 sf	51.00 m2
Unit Type	208	STUDIO	L2-L5	548.00 sf	50.91 m2	548,00 sf	50,91 m2
Unit Type	209	2 BED	L2-L5	890.00 sf	82.68 m2	890,00 sf	82.68 m2
Unit Type	210	2 BED	L2-L5	754.00 sf	7 0.05 m2	7 54,00 sf	7 0.05 m2
Unit Type	211	1 BED	L2-L5	518.00 sf	48.12 m2	518,00 sf	48.12 m2

Unit Count

TOTAL				53	Units
L2 - L5	11	×	4	44	units
LL	9	x	1	9	units
L1	Ō	x	1	0	units
B1	0	X	1	0	units
LEVEL	Unit C	ount			

Circulation

LEVEL	Strata Are	a / Unit	Total Strata	Area
B1	2,084.00 sf	193.61 m2	2084.00 sf	193.61 m2
L1	835.00 sf	77 .57 m2	835.00 sf	77.57 m2
LL	1,013.00 sf	94.11 m2	1013.00 sf	94.11 m2
L2 - L5	902,00 sf	83.80 m2	902.00 sf	83.80 m2
LZ - L5	902,00 st	გა.გი r	nz	n2 902,00 st
	B1 L1 LL	B1 2,084.00 sf L1 835.00 sf LL 1,013.00 sf	B1 2,084.00 sf 193.61 m2 L1 835.00 sf 77.57 m2 LL 1,013.00 sf 94.11 m2	B1 2,084.00 sf 193.61 m2 2084.00 sf L1 835.00 sf 77.57 m2 835.00 sf LL 1,013.00 sf 94.11 m2 1013.00 sf

Parking Requirement **As per Figure 9-3 - Minimum Parking Provision by Class of Building [Zoning Bylaw, 1995, No. 6700]

**As per Figure 9-3 - Minimum Parking Provision by Class of Building [Zoning Bylaw, 1995, No. 6700]

**Begular Unit Requirement

**0.6 spaces per Dwelling Unit	Units	Regular Unit Requirement
Total Residential Stalls Required	53 units	31.8 Stalls
**0.1 spaces per Dwelling Unit	Units	Visitor Parking Requirement
Visitor Parking Portion of Total Required	53 units	5.3 Stalls
Total Proposed Parking		27 Stalls

Bicycle Parking Summary

**As per Table 10A-02 - Bicycle Parking [Zoning Bylaw, 1995, No. 6700]

Type

Short-term Parking Required

A stalls

Short-term Parking Required

A stalls

Type	50	aus	3	talls
Short-term Parking Required	6	stalls	6	Stalls
Short-term Parking Provided	6.0	stalls	6	Stalls
Secure Parking Required	79 .5	stalls	80	Stalls
Secure Parking Provided	96.0	stalls	96	Stalls
Total Provided BicycleParking			102	Stalls

Refuse & Recycling Summary	**As per Table 1-Recycling and Ga	rbage Storage	e Space Requirements	[Zoning Bylaw, 1995, No. 6	700, Section 417]
**5.23 s f per D w e	lling Unit	Ur	nits	Area Requ	iired
	Area Required	53	units	277.3 sf	25.76 m2
	Total Area Provided			277.0 sf	70.23 m2

enity Requirements		**Totally Allowable Amenity Area is 5% of Gro	ost neer theat [2011ing Dylar	,, ,,,,,,,,,,,,,,,,,,,,,,,,,,,,,,,,,,,,
Gro	ss Floor Area	Allowable Amenity %	Total Allowable A	Amenity Area
39049.4 sf	3627.81 m2	5%	1952.5 sf	181.39 m

	Proposed Ameni	ty Area	Gross Floo	or Area	Allowable FSR Ex	cluded Area
Lobby Level	Multi-Purpose	Unit LO2	956.00 sf	88.82 m2	956.0 sf	88.82 m2
Roof		Circulation/ Storage	668.00 sf	62.06 m2	668.0 sf	62.06 m2
Roof		Proposed Outdoor Deck	600.00 sf	55.74 m2	328.5 sf	30.52 m2
Tot	tal		2224.00 sf	206.62 m2	1952.5 sf	181.39 m2





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351 3RD STREET WEST


351 WEST 3RD STREET
NORTH VANCOUVER, BC


V7M 1G3

SHEET TITLE

PROJECT DATA


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MARCH 23, 2022	21035
SCALE:	21033
DRAWING NO.	REVISION
G101	

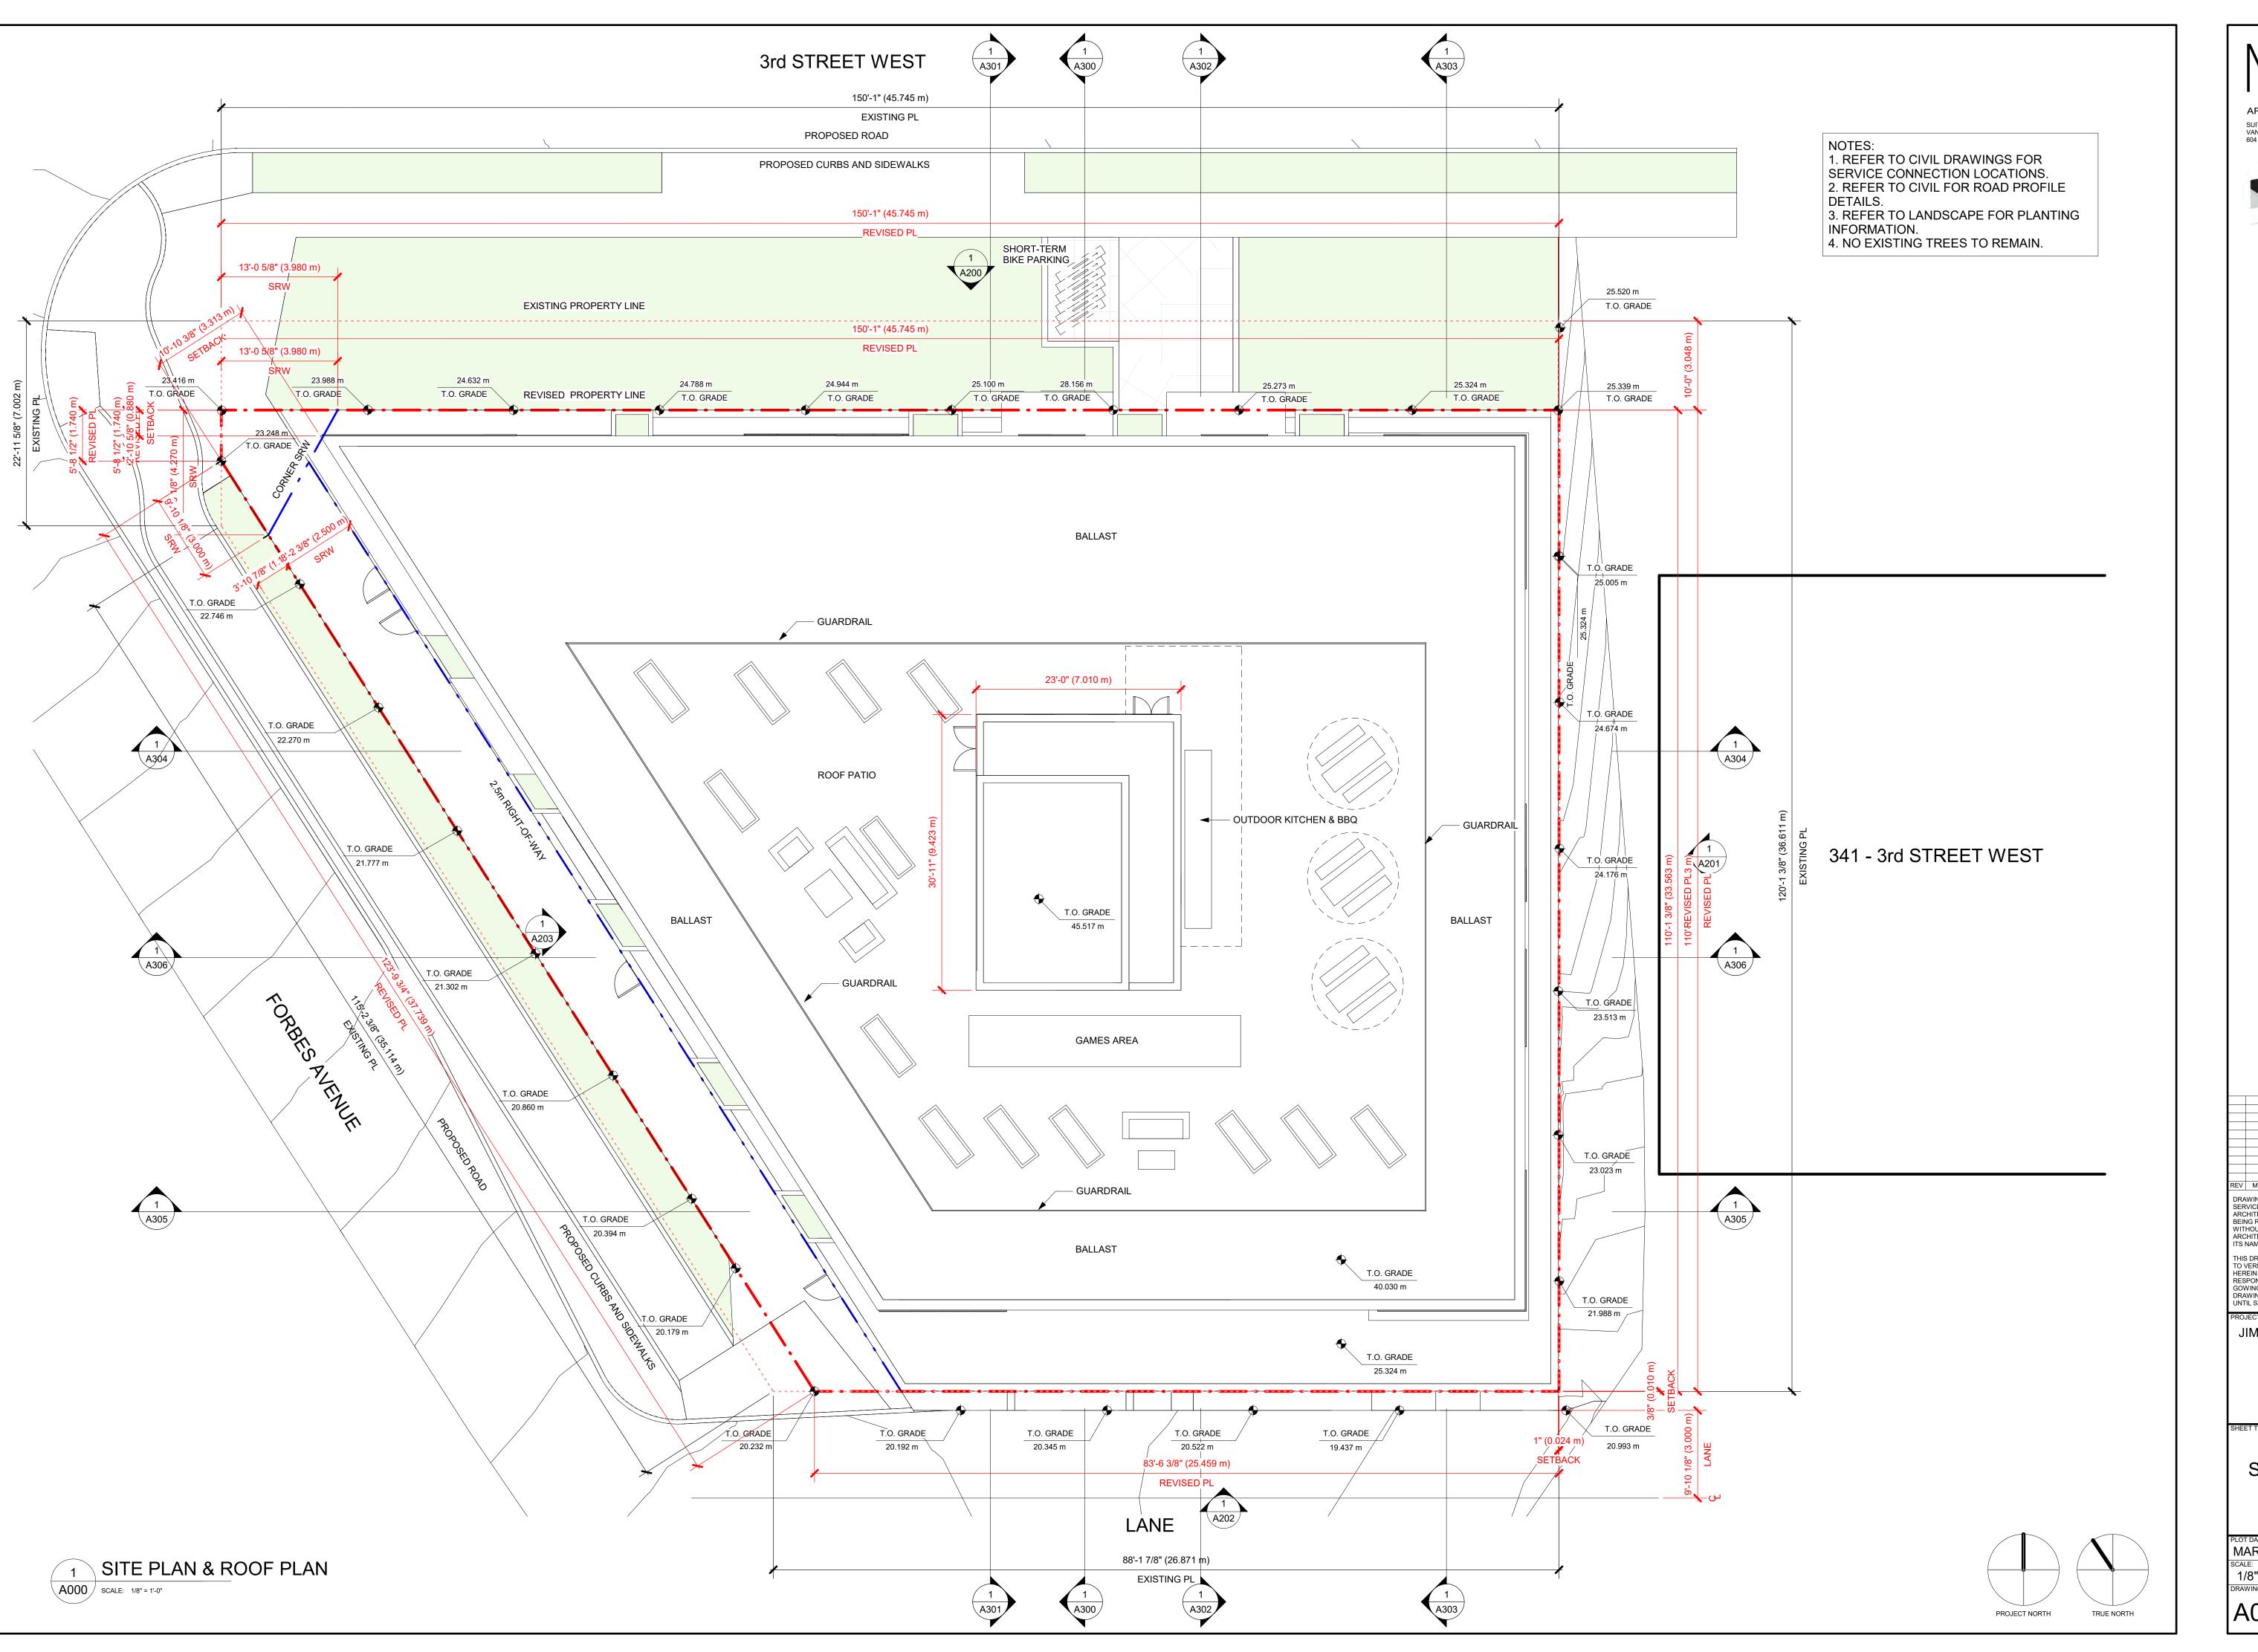

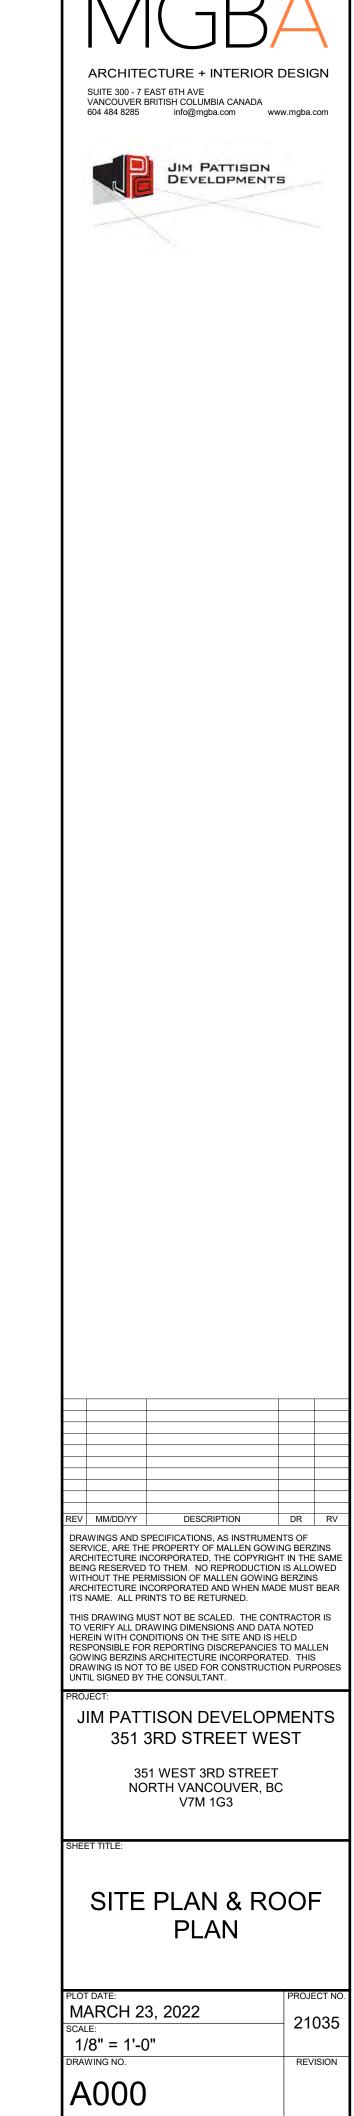





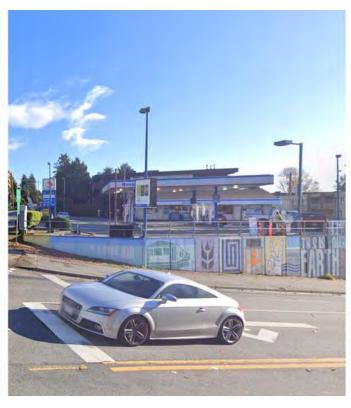





EAST STREET ELEVATION









NORTH STREET ELEVATION

VIEW OF SITE LOOKING SOUTH-EAST








VIEW ALONG 3rd STREET LOOKING WEST



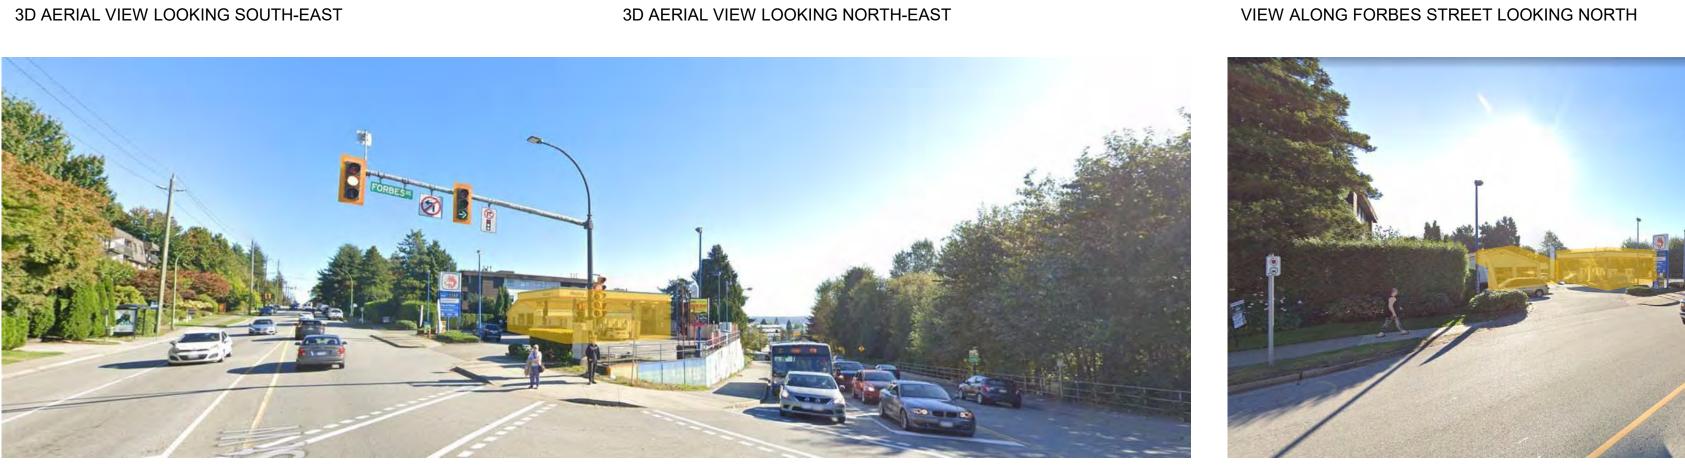

HARBOUR

BEGGS

TO STORY STORY

ZONING MAP

PARKS

COMMERCIAL / MIXED USE

TRANSIT ROUTE


RESIDENTIAL

SCHOOL / INSTITUTIONAL

SQUAMISH NATION

ARCHITECTURE + INTERIOR DESIGN
SUITE 300 - 7 EAST 6TH AVE
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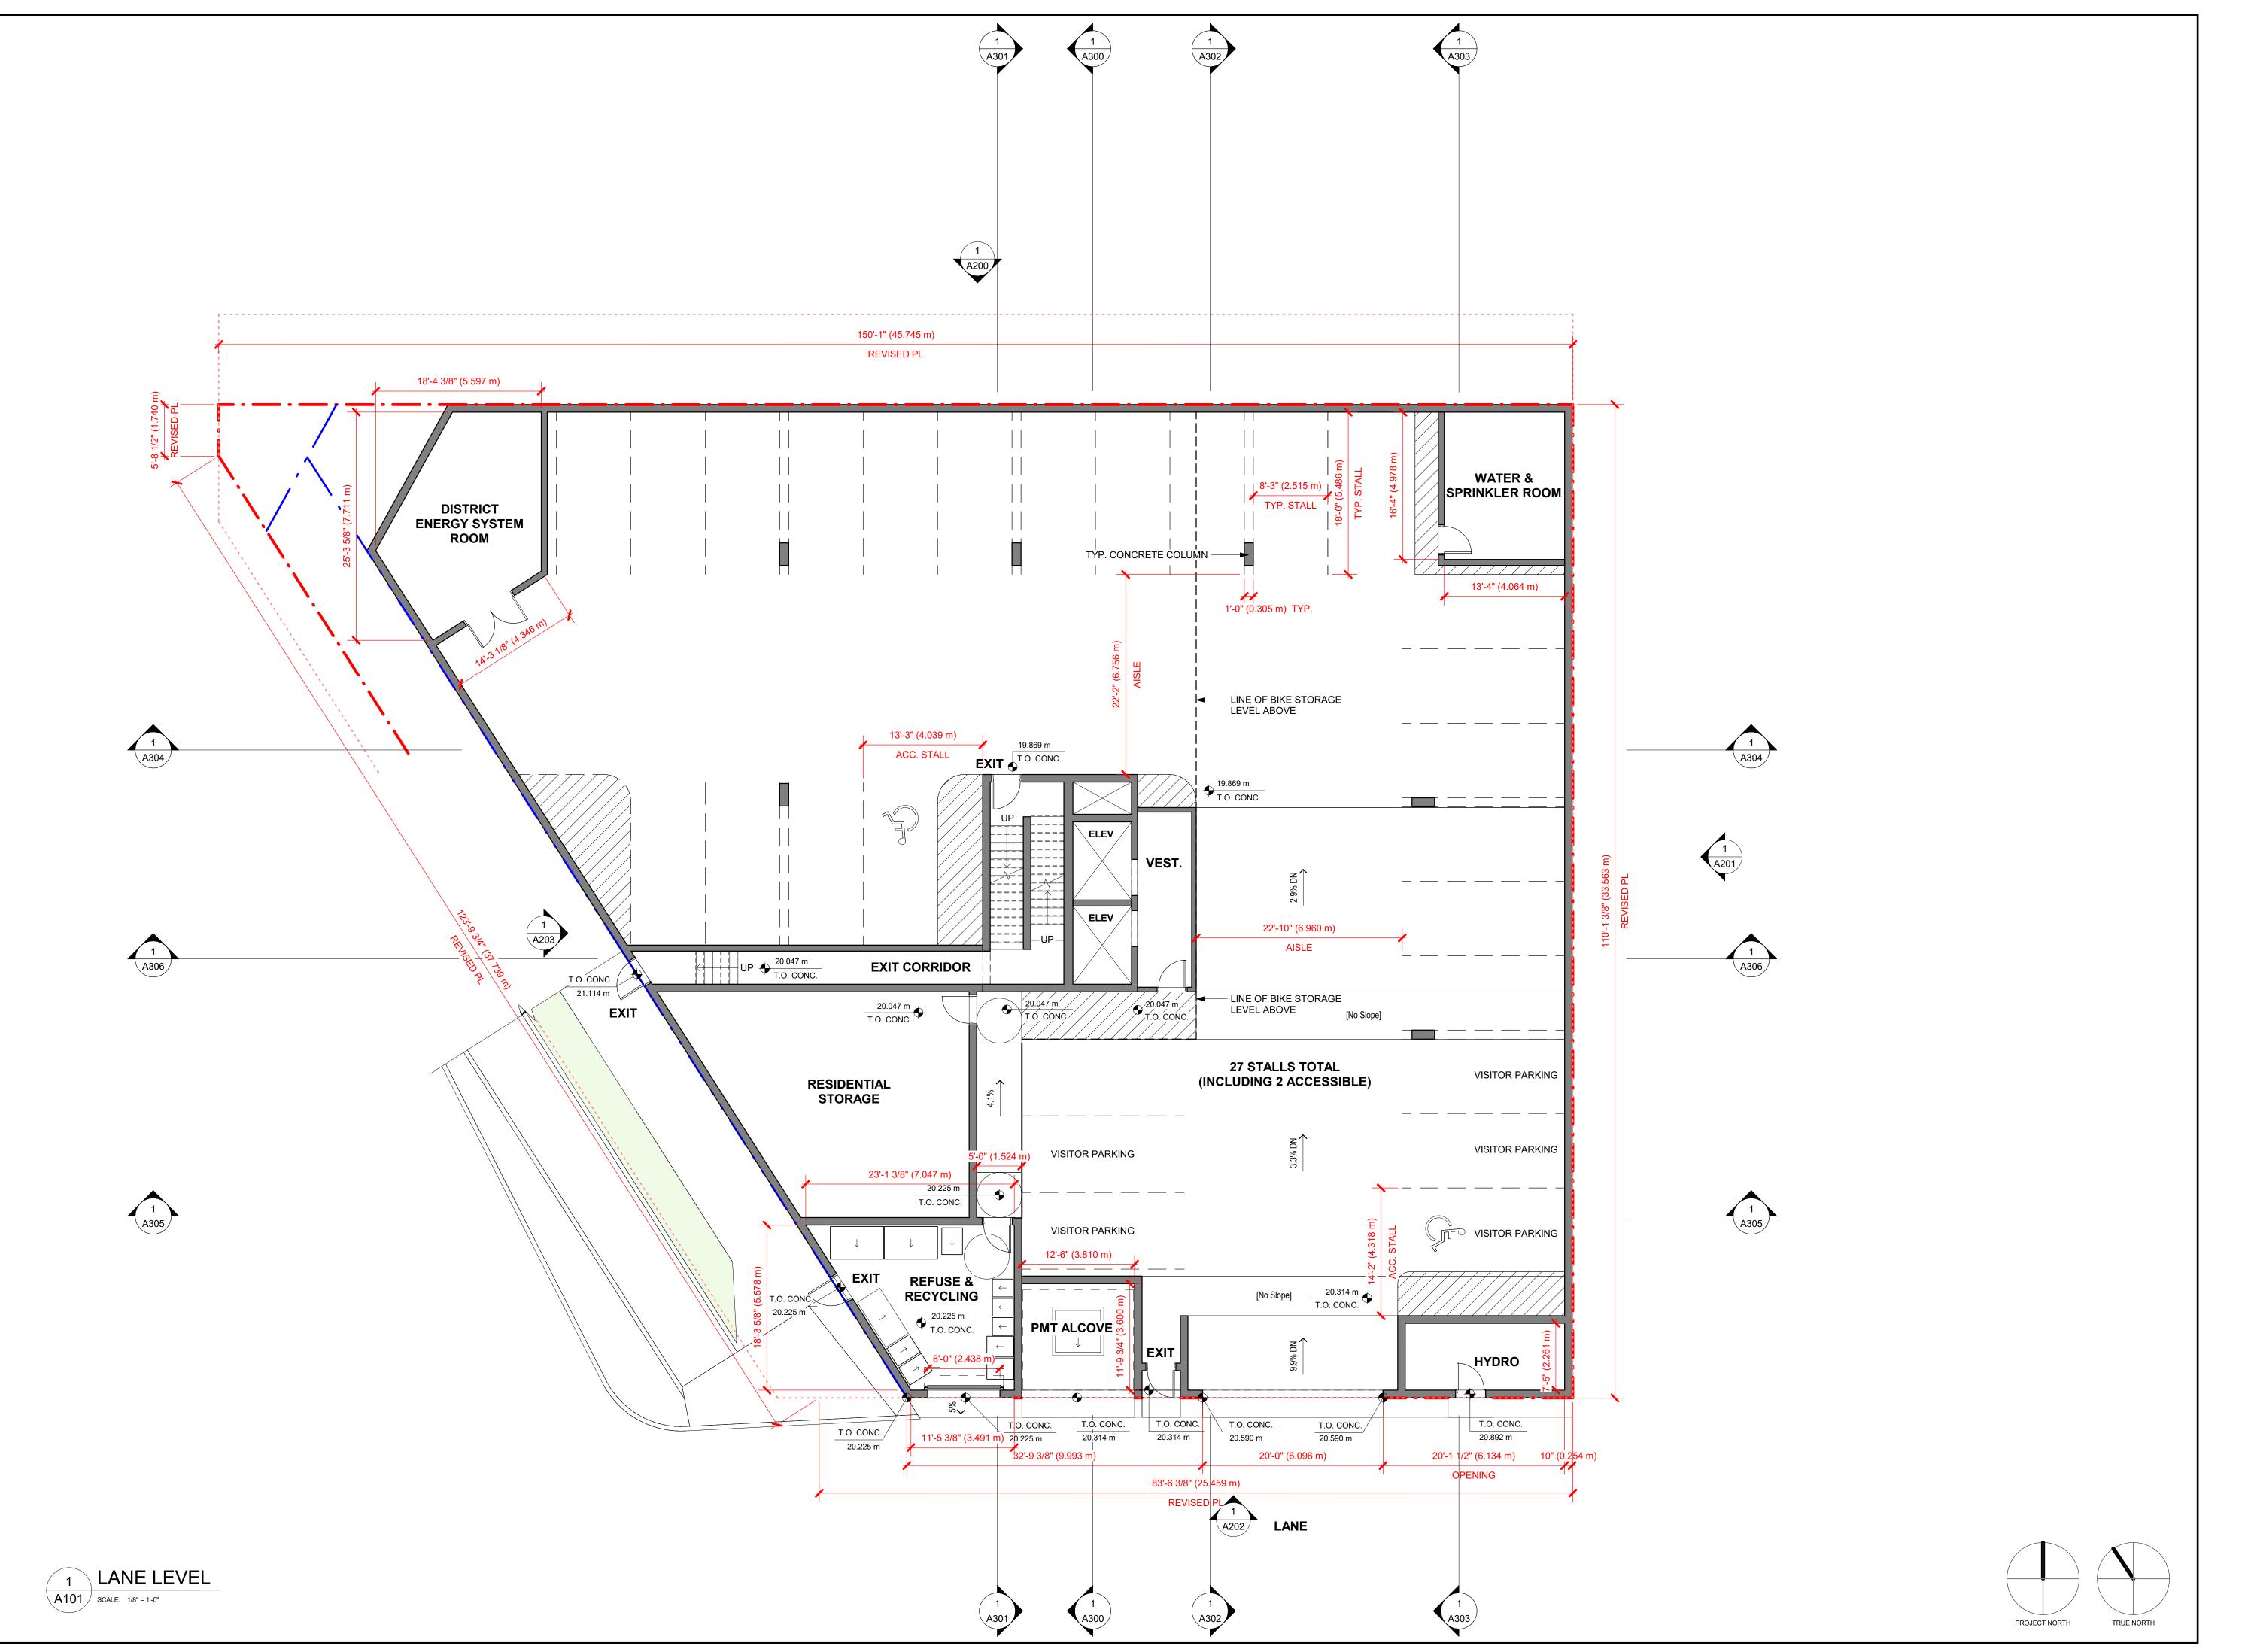
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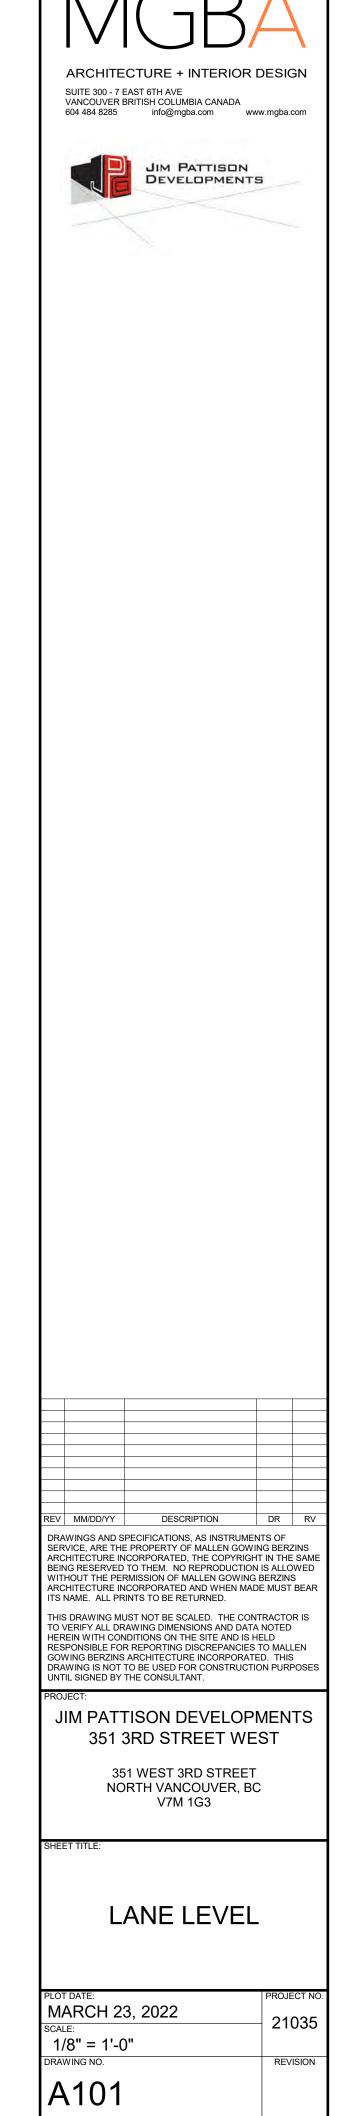
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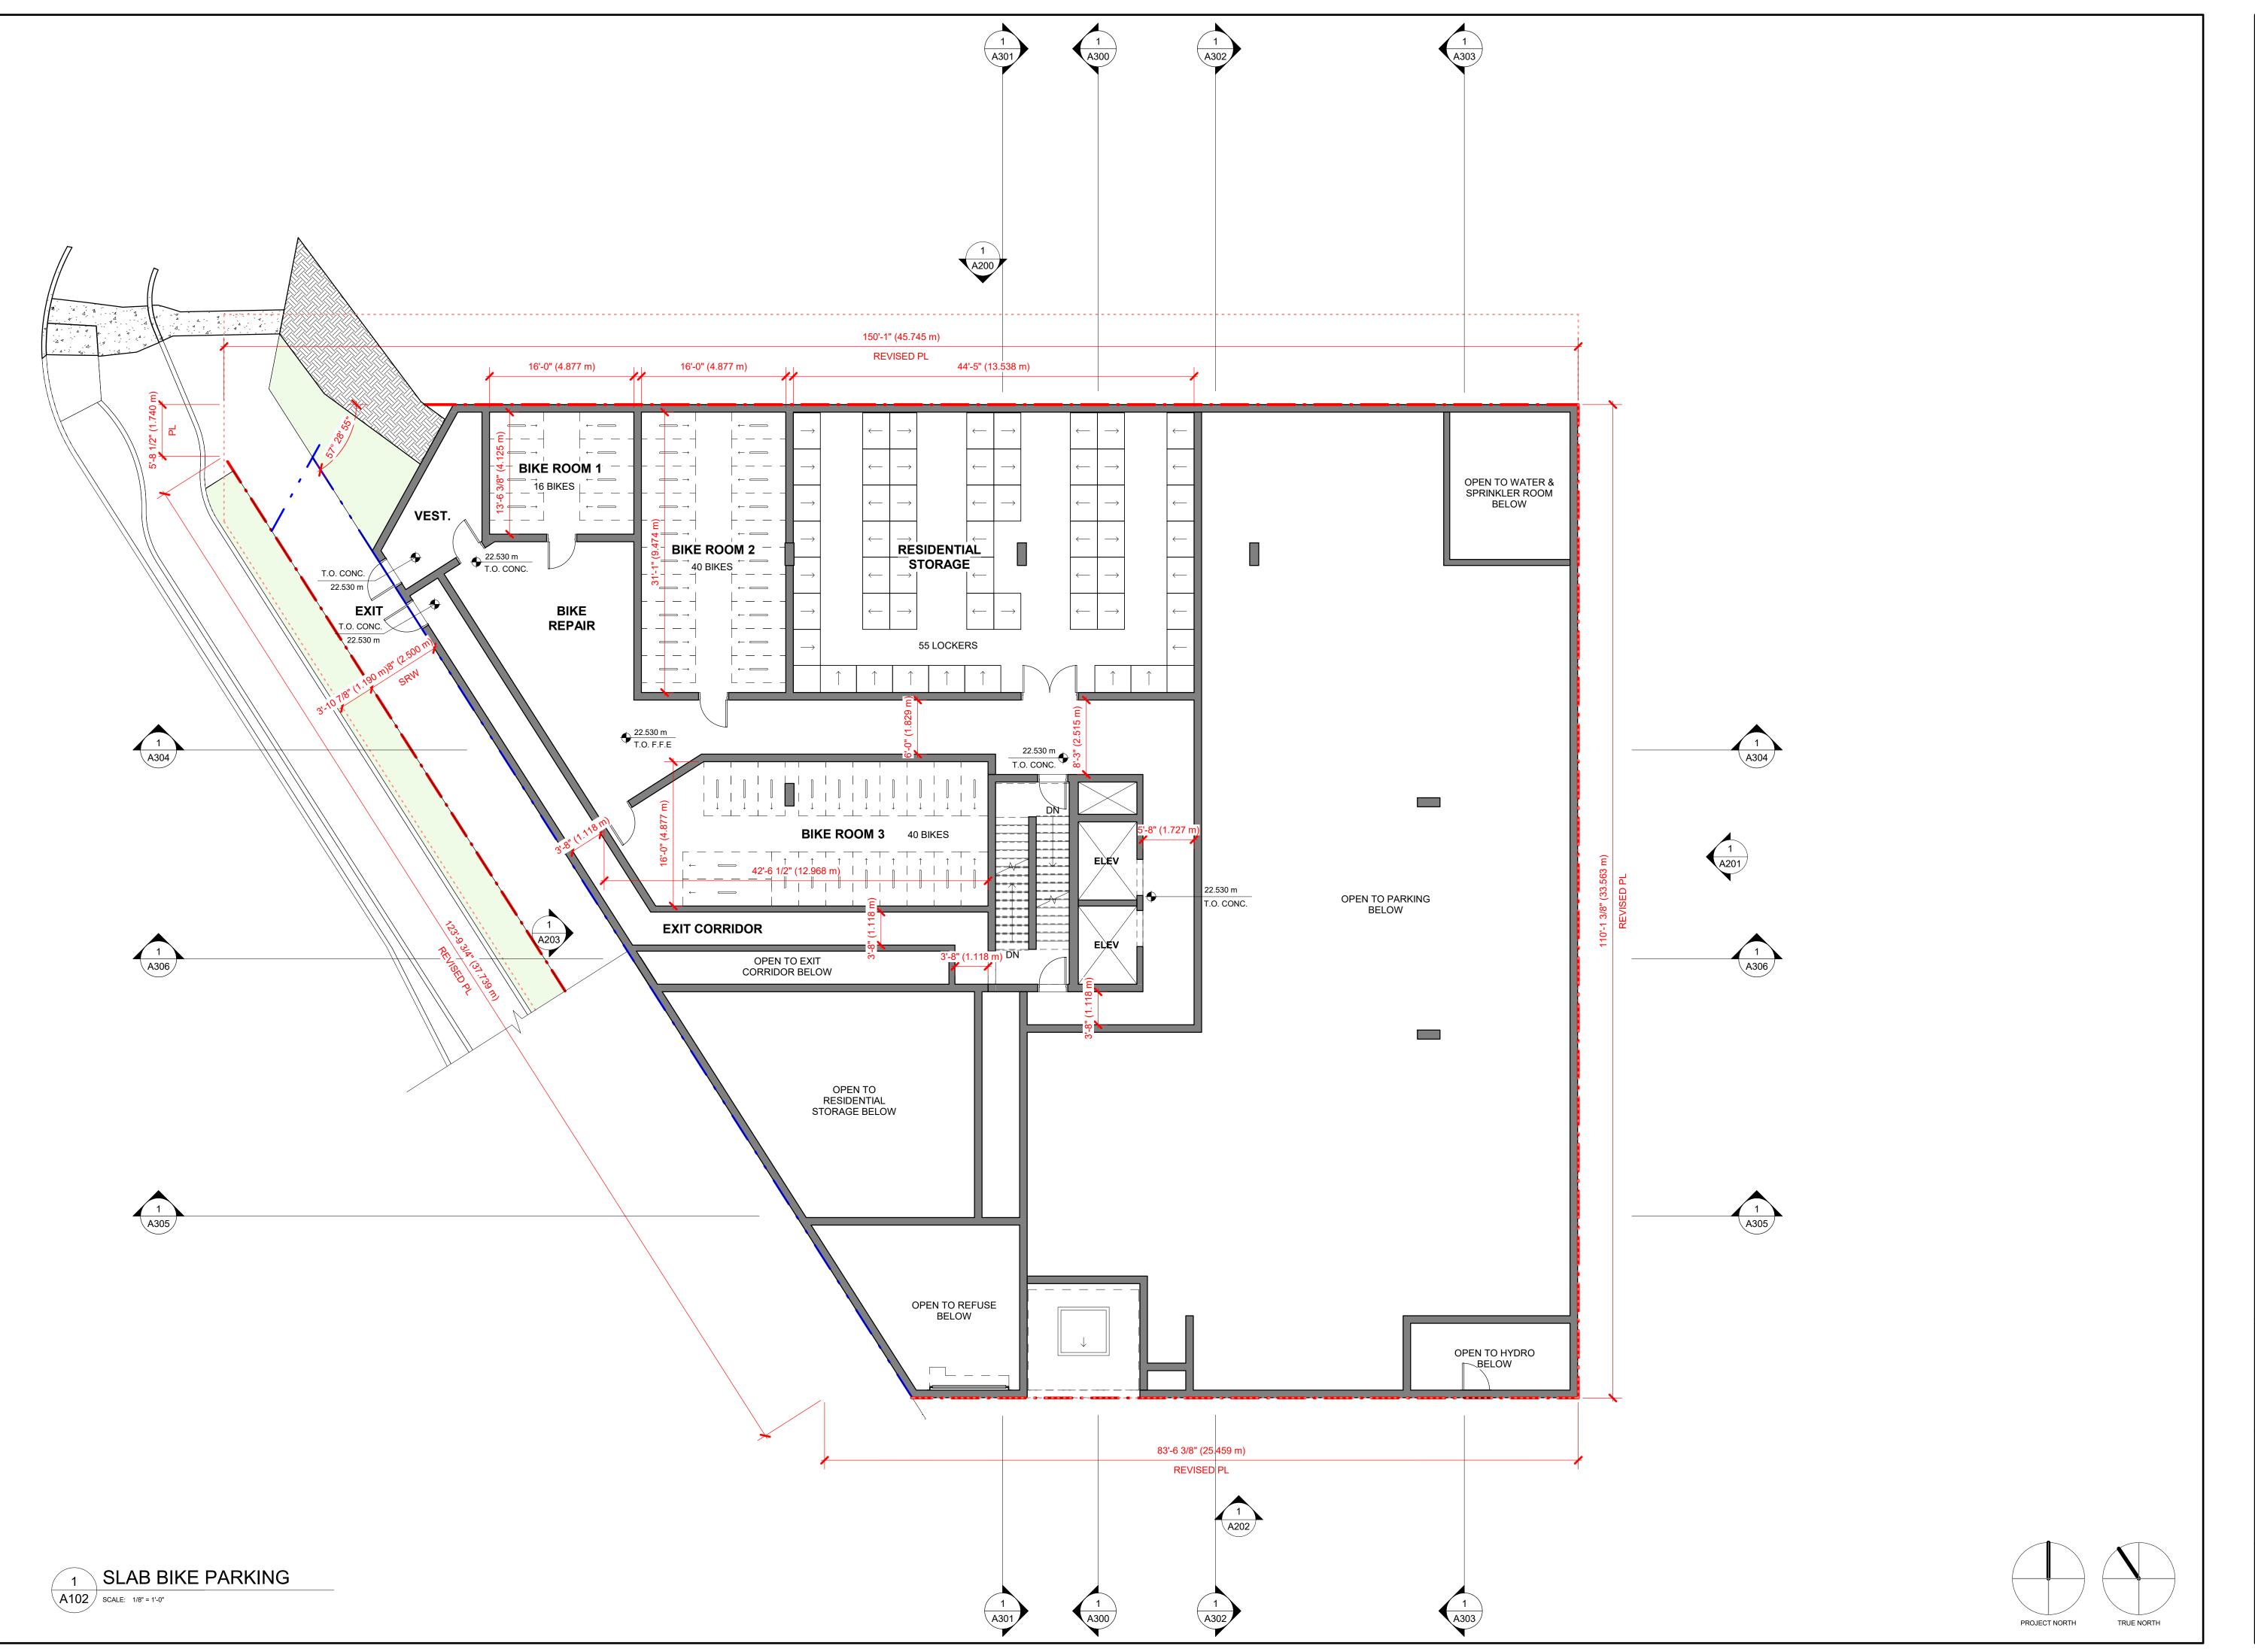
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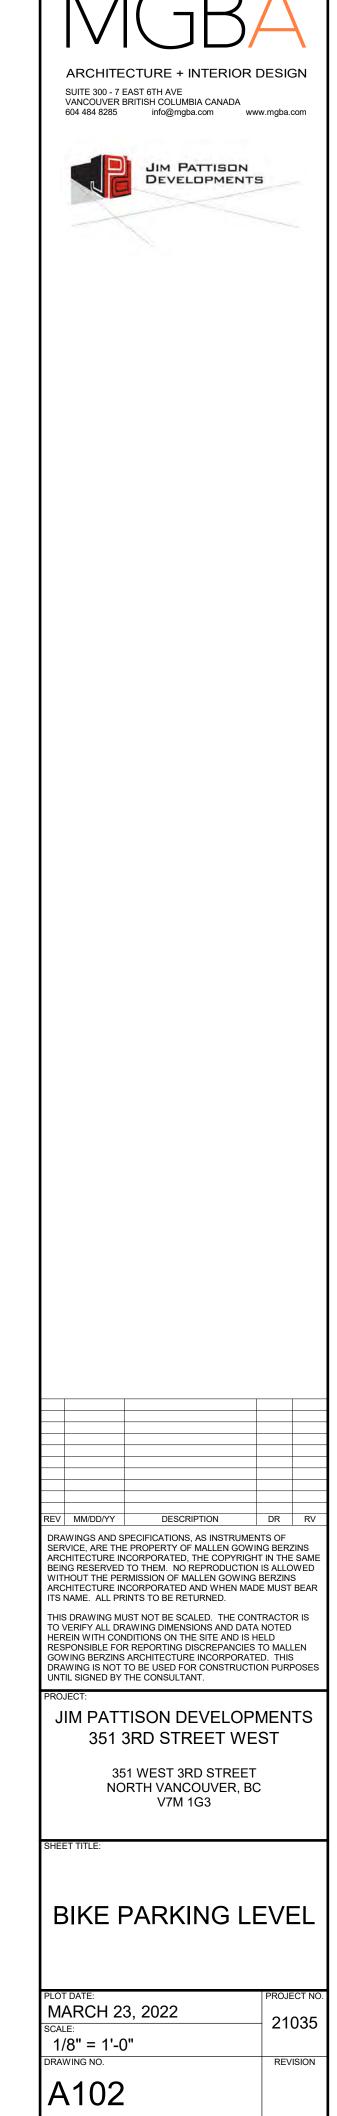
SITE PHOTOS/ RUNNING STREET ELEVATIONS


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MARCH 23, 2022	21035
SCALE:	21000
DRAWING NO.	REVISION
A001	

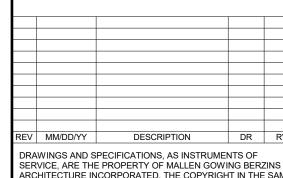










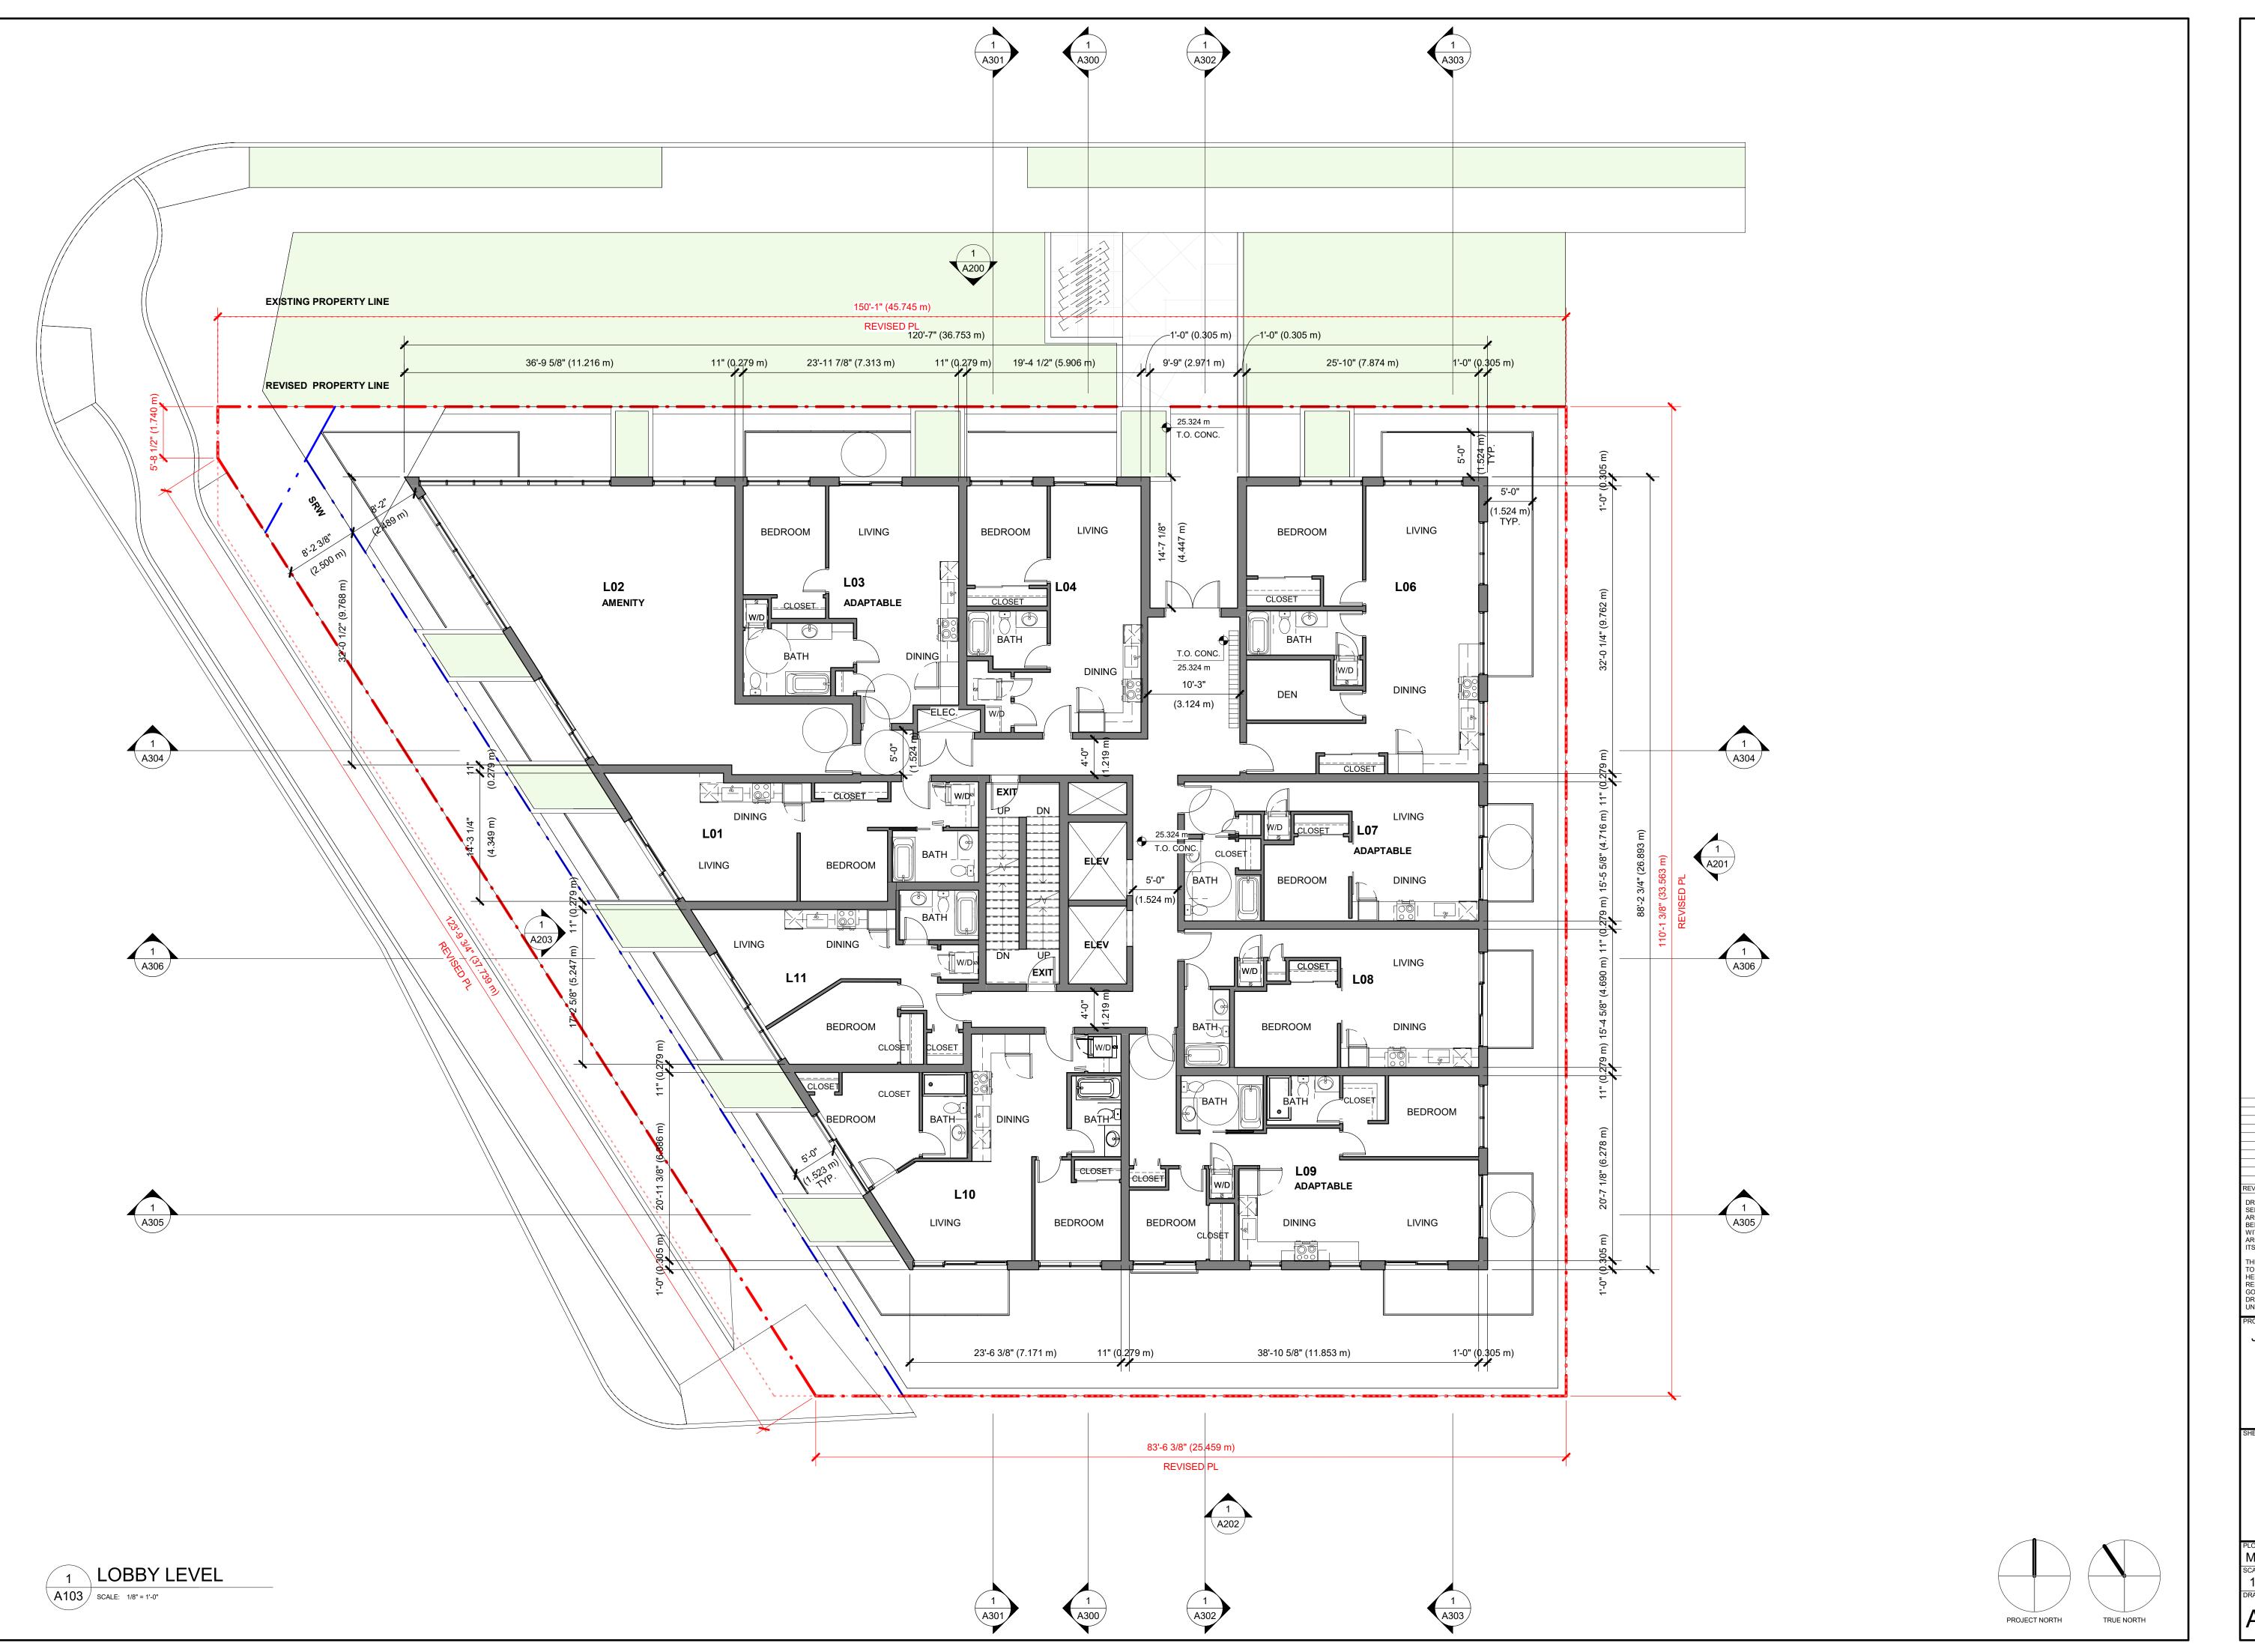

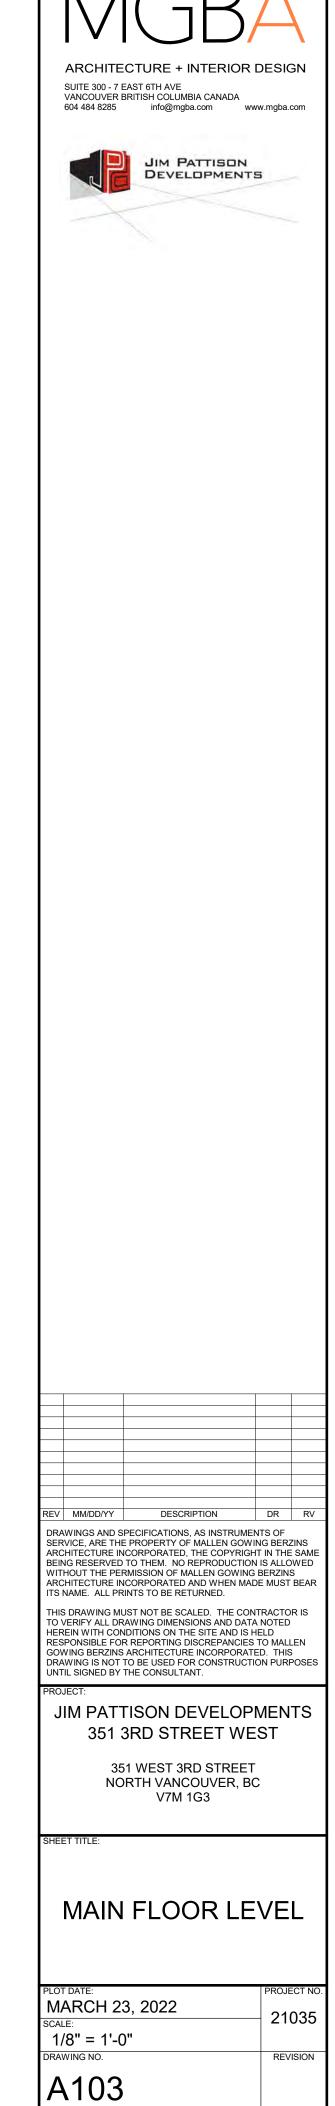

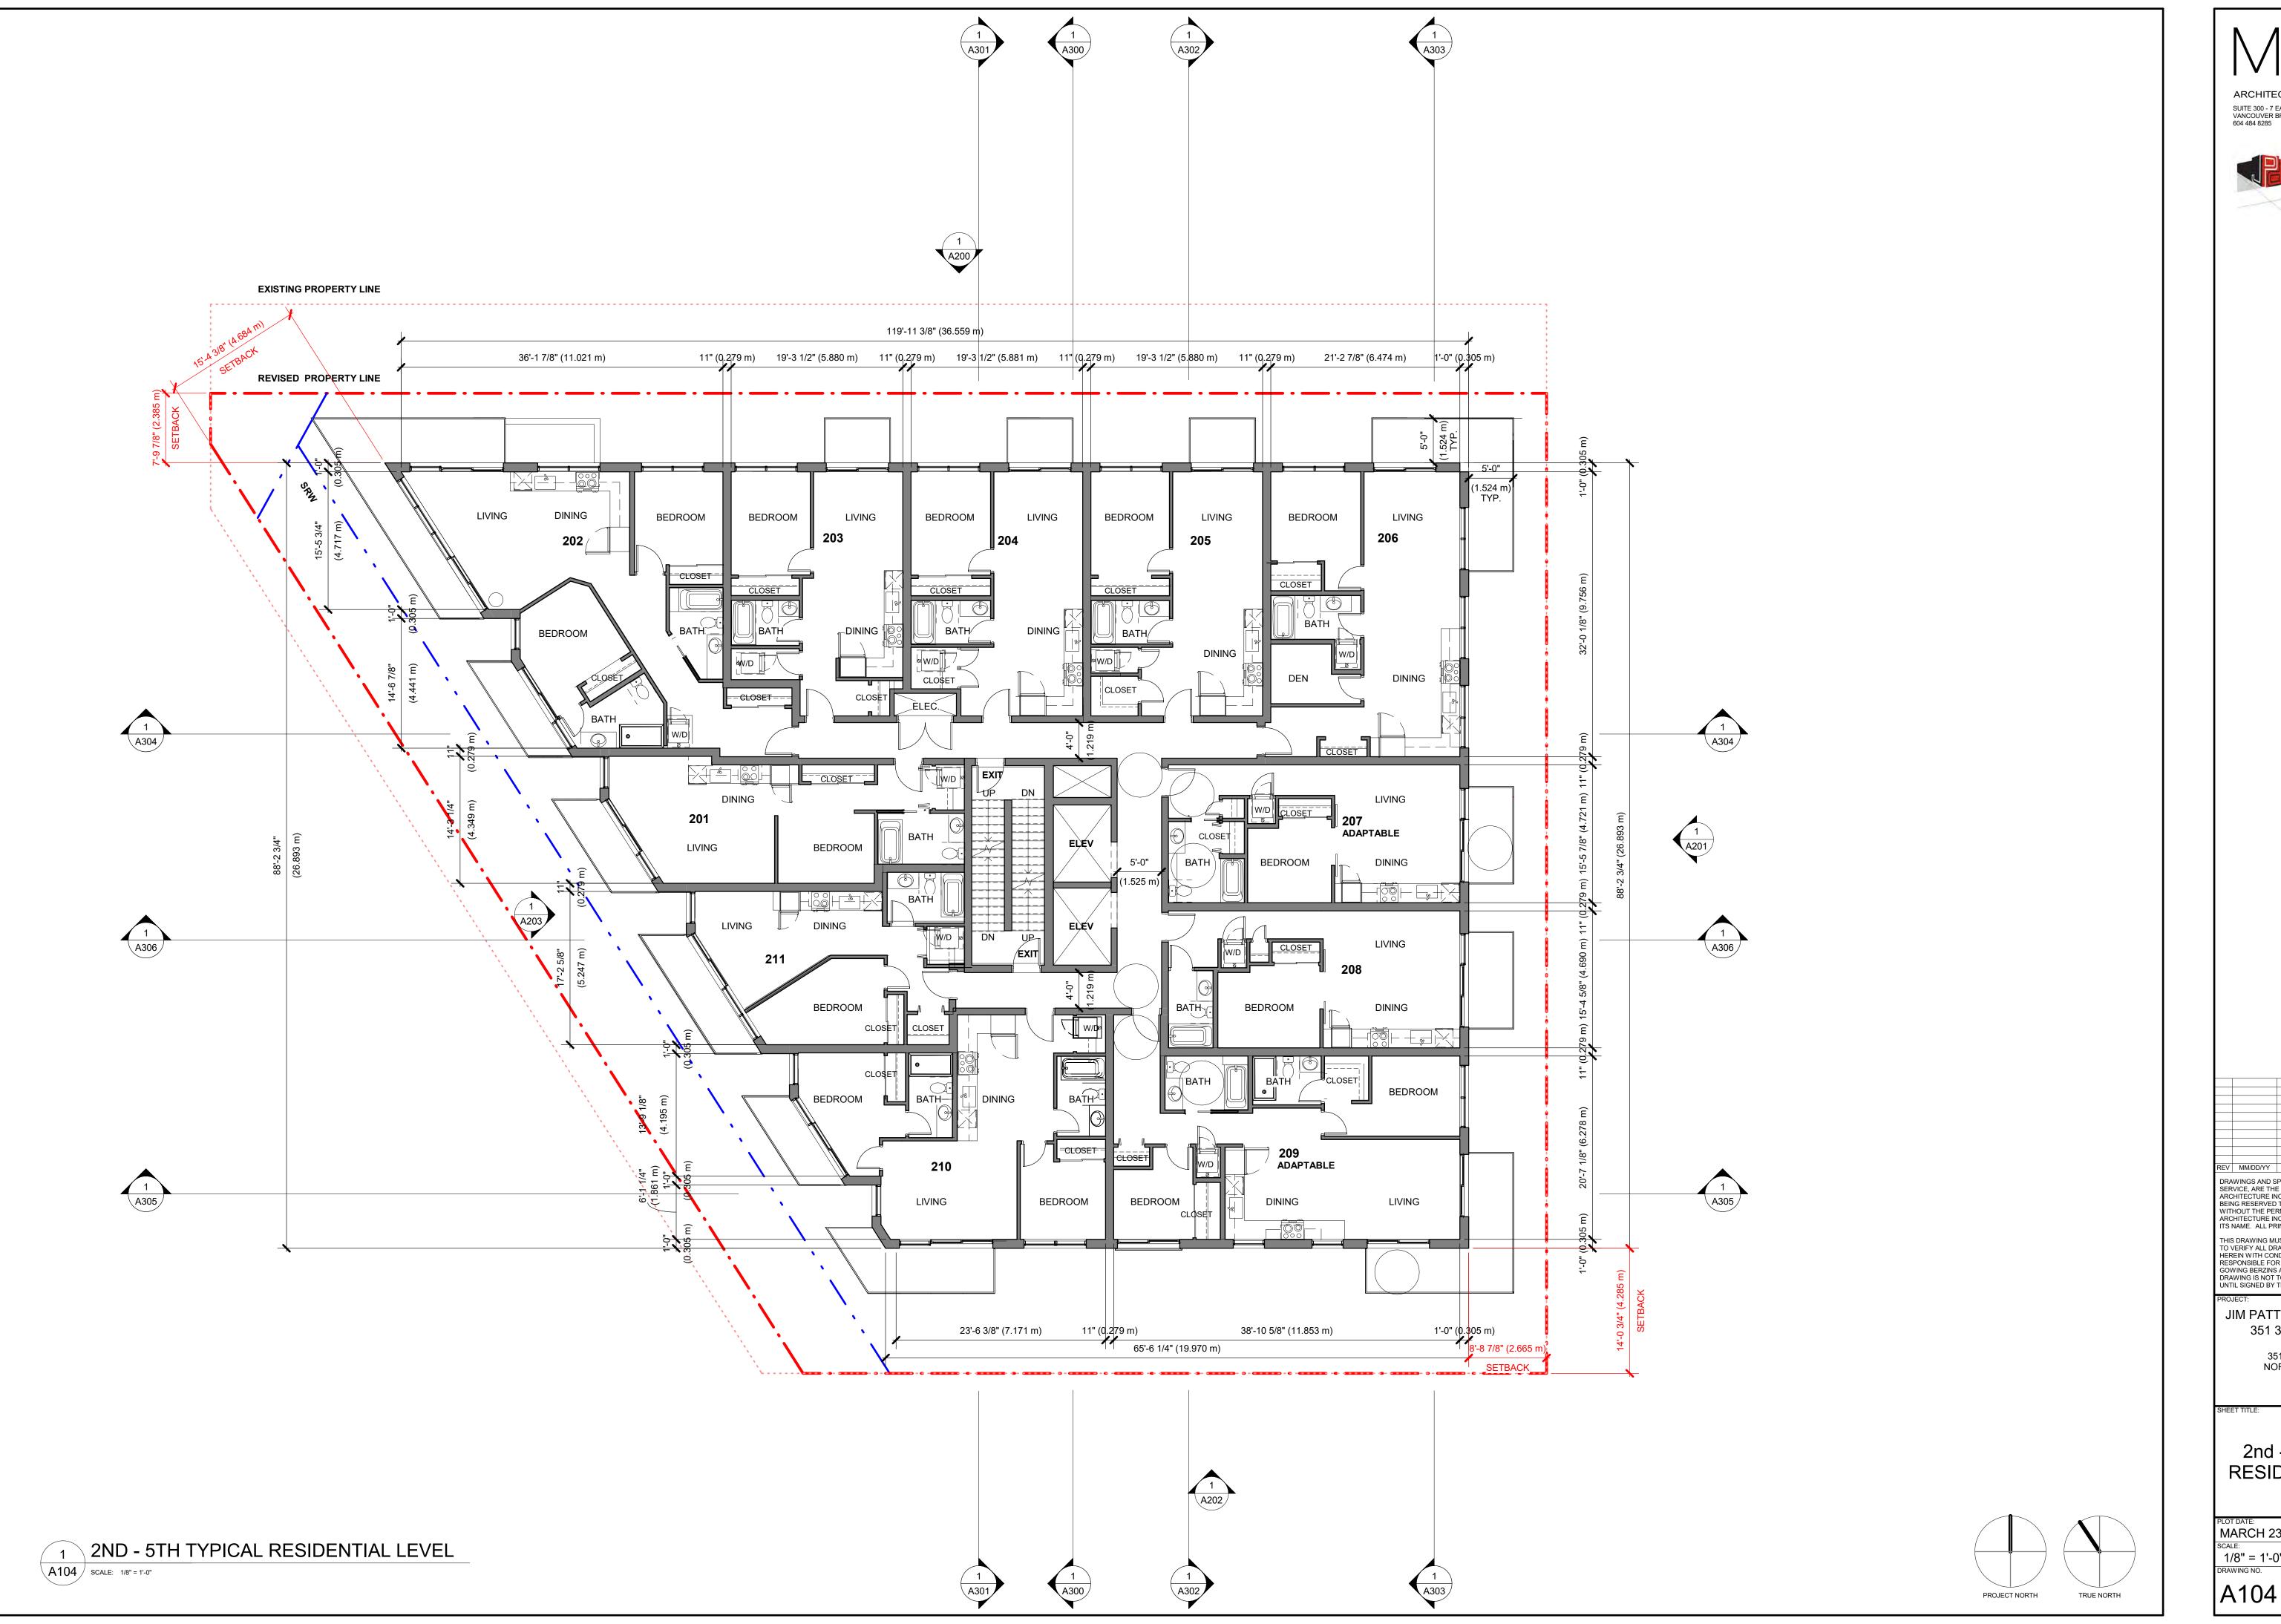

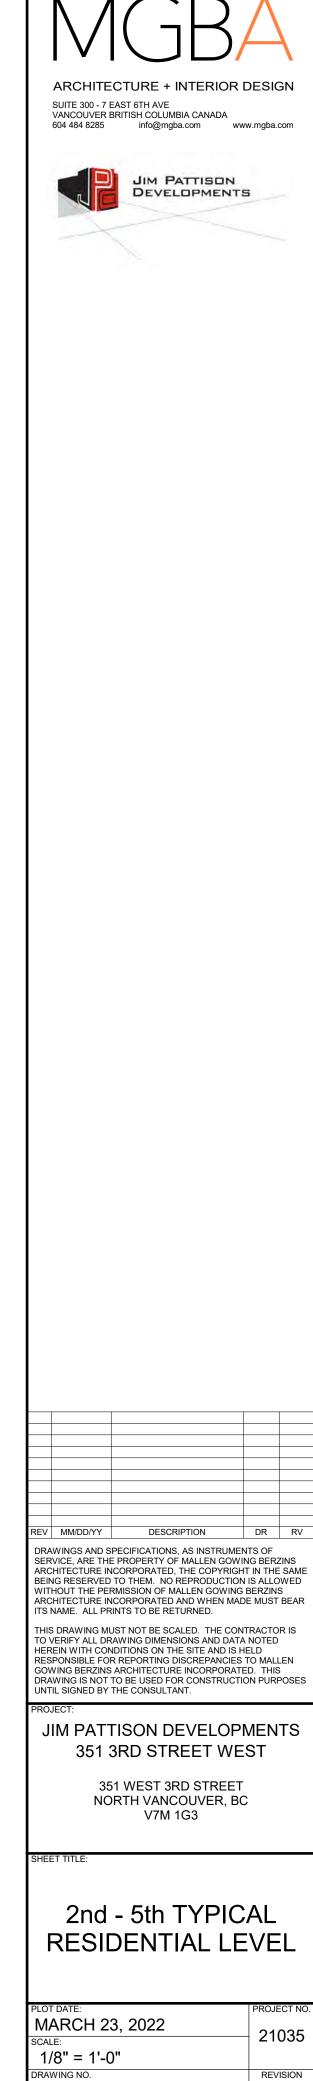





ARCHITECTURE + INTERIOR DESIGN
SUITE 300 - 7 EAST 6TH AVE
VANCOUVER BRITISH COLUMBIA CANADA
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REV MM/DD/YY DESCRIPTION DR RV

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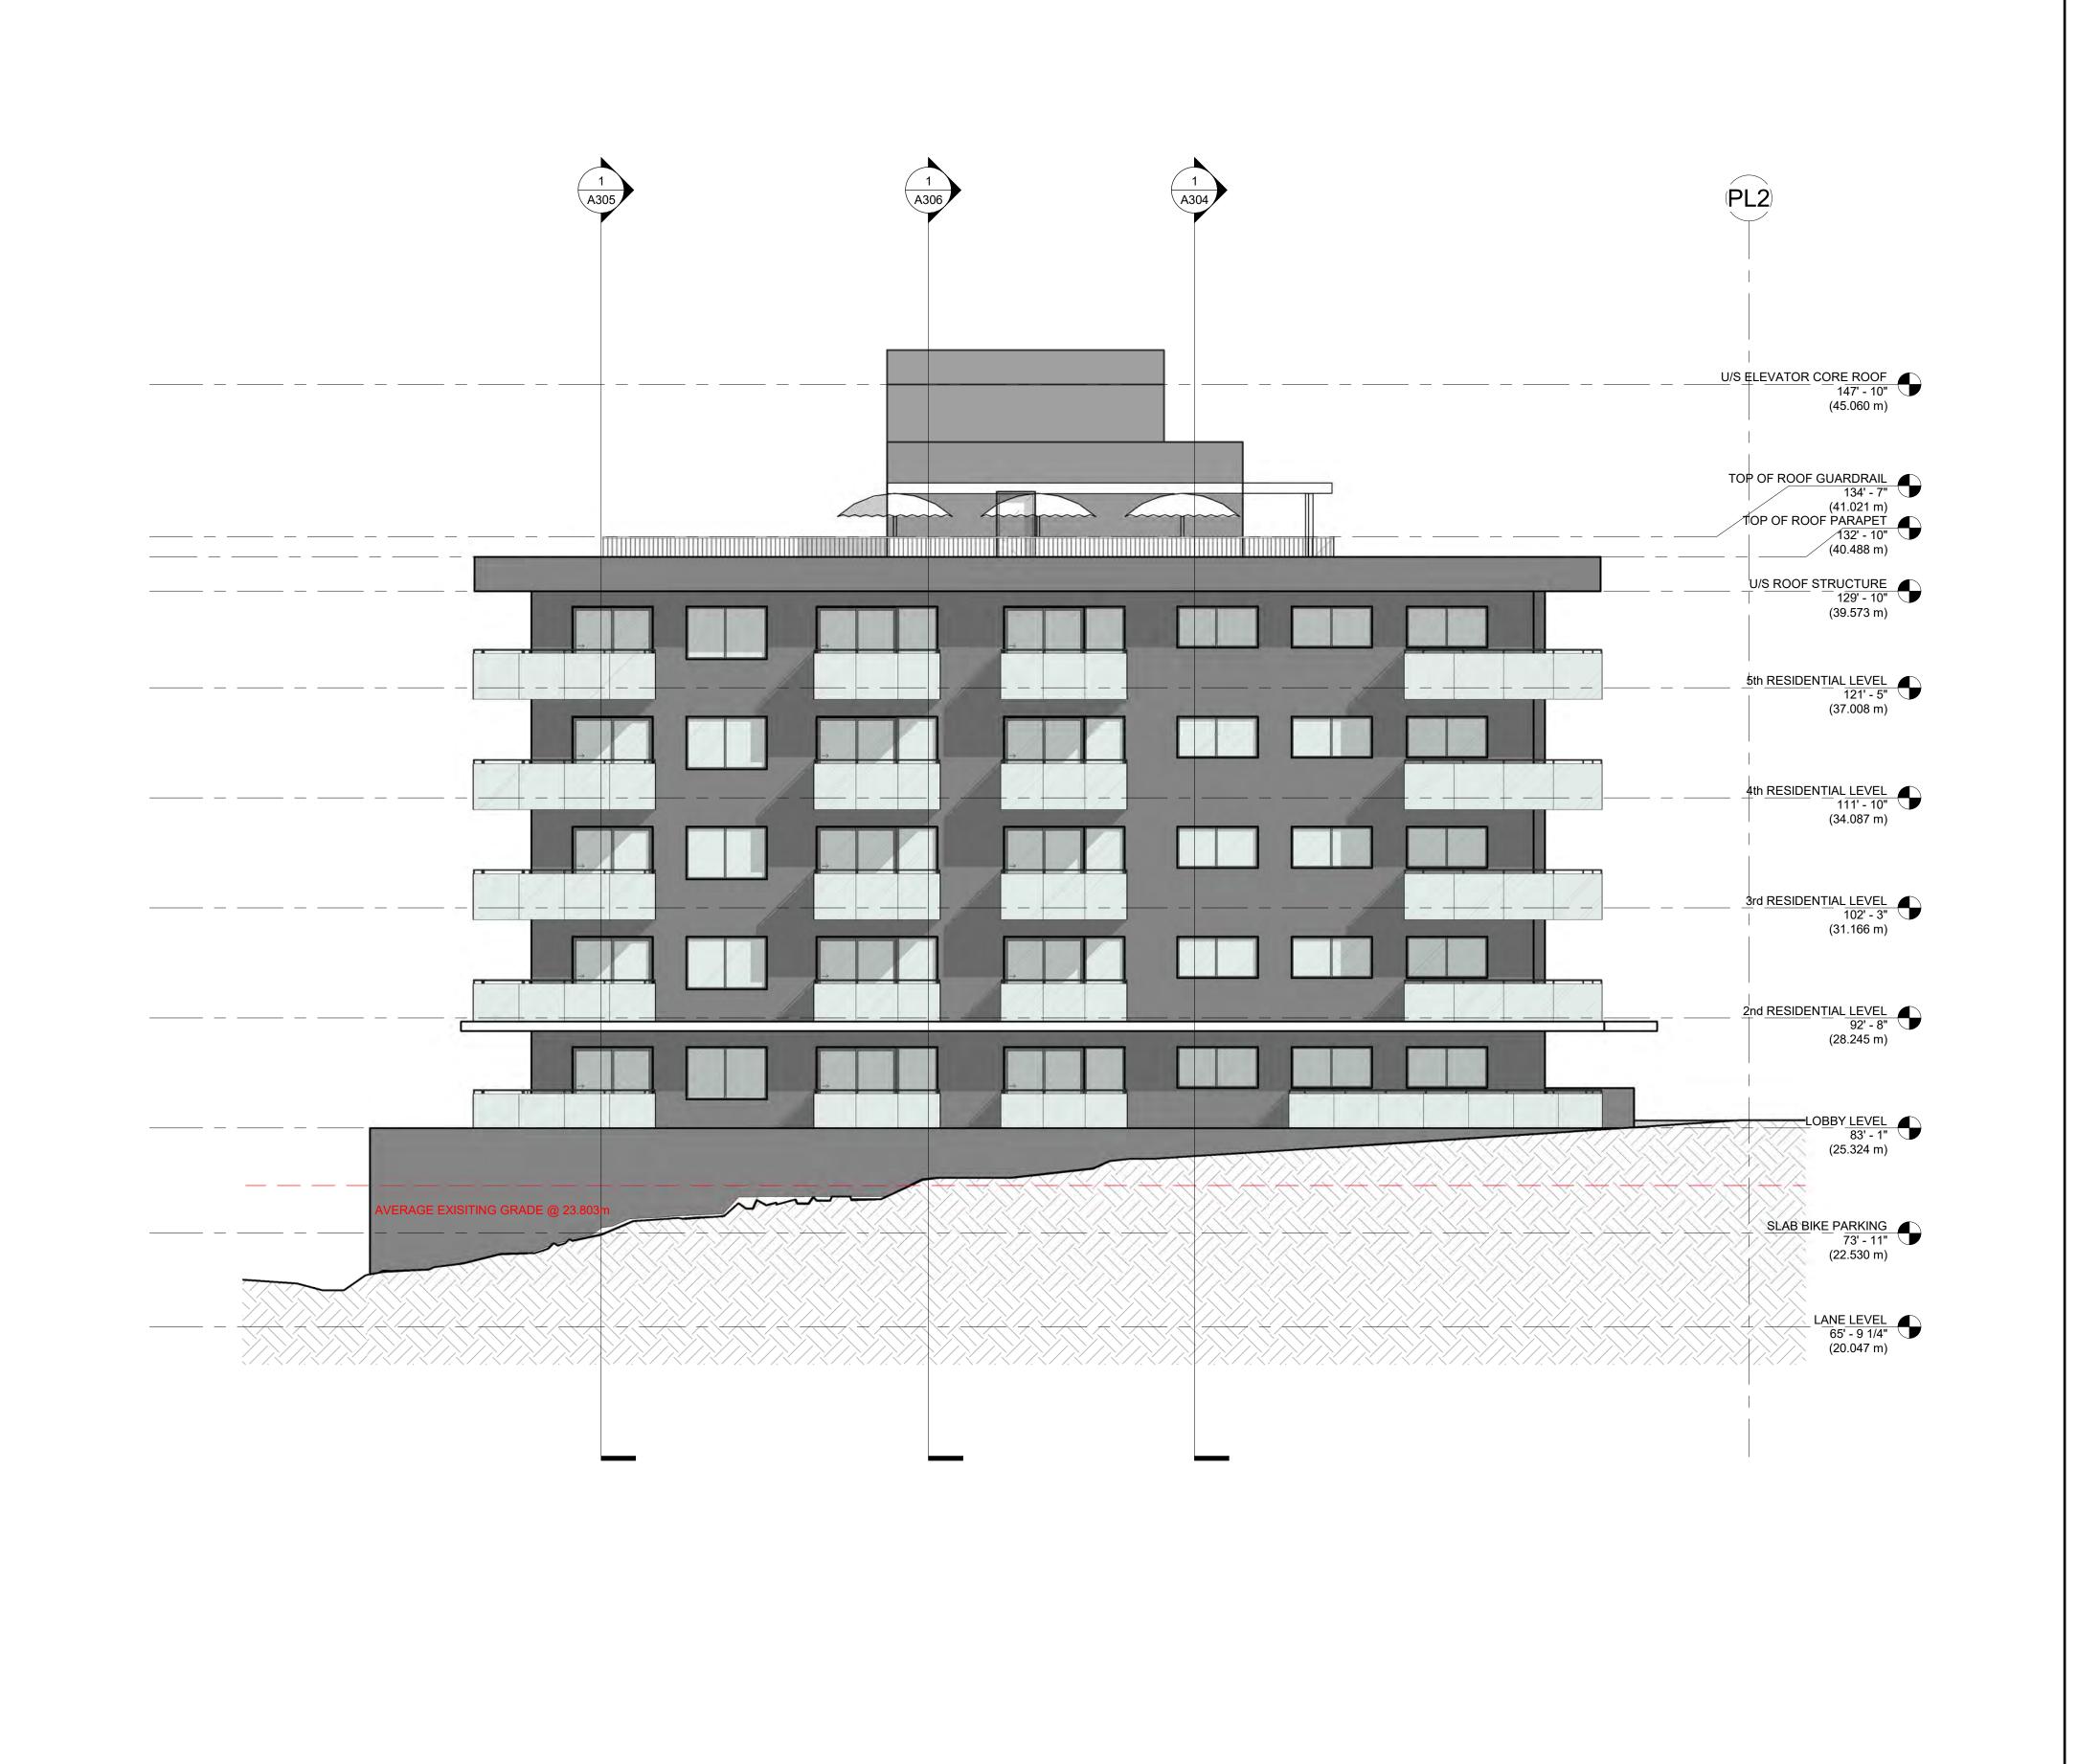
JIM PATTISON DEVELOPMENTS 351 3RD STREET WEST

> 351 WEST 3RD STREET NORTH VANCOUVER, BC V7M 1G3

SHEET TITLE

NORTH ELEVATION

PLOT DATE:	PROJECT NO.
MARCH 23, 2022	21035
SCALE:	21000
1/8" = 1'-0"	
DRAWING NO.	REVISION
A200	





ARCHITECTURE + INTERIOR DESIGN SUITE 300 - 7 EAST 6TH AVE VANCOUVER BRITISH COLUMBIA CANADA 604 484 8285 info@mgba.com www.mgba.com JIM PATTISON DEVELOPMENTS REV MM/DD/YY DESCRIPTION DRAWINGS AND SPECIFICATIONS, AS INSTRUMENTS OF DRAWINGS AND SPECIFICATIONS, AS INSTRUMENTS OF SERVICE, ARE THE PROPERTY OF MALLEN GOWING BERZINS ARCHITECTURE INCORPORATED, THE COPYRIGHT IN THE SAME BEING RESERVED TO THEM. NO REPRODUCTION IS ALLOWED WITHOUT THE PERMISSION OF MALLEN GOWING BERZINS ARCHITECTURE INCORPORATED AND WHEN MADE MUST BEAR ITS NAME. ALL PRINTS TO BE RETURNED. THIS DRAWING MUST NOT BE SCALED. THE CONTRACTOR IS TO VERIFY ALL DRAWING DIMENSIONS AND DATA NOTED HEREIN WITH CONDITIONS ON THE SITE AND IS HELD RESPONSIBLE FOR REPORTING DISCREPANCIES TO MALLEN GOWING BERZINS ARCHITECTURE INCORPORATED. THIS DRAWING IS NOT TO BE USED FOR CONSTRUCTION PURPOSES UNTIL SIGNED BY THE CONSULTANT.

JIM PATTISON DEVELOPMENTS 351 3RD STREET WEST

> 351 WEST 3RD STREET NORTH VANCOUVER, BC V7M 1G3

EAST ELEVATION

PLOT DATE:	PROJECT NO.
MARCH 23, 2022	21035
SCALE:	21033
1/8" = 1'-0"	
DRAWING NO.	REVISION
A201	



1 SOUTH ELEVATION
A202 SCALE: 1/8" = 1'-0"

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DEVELOPMENTS

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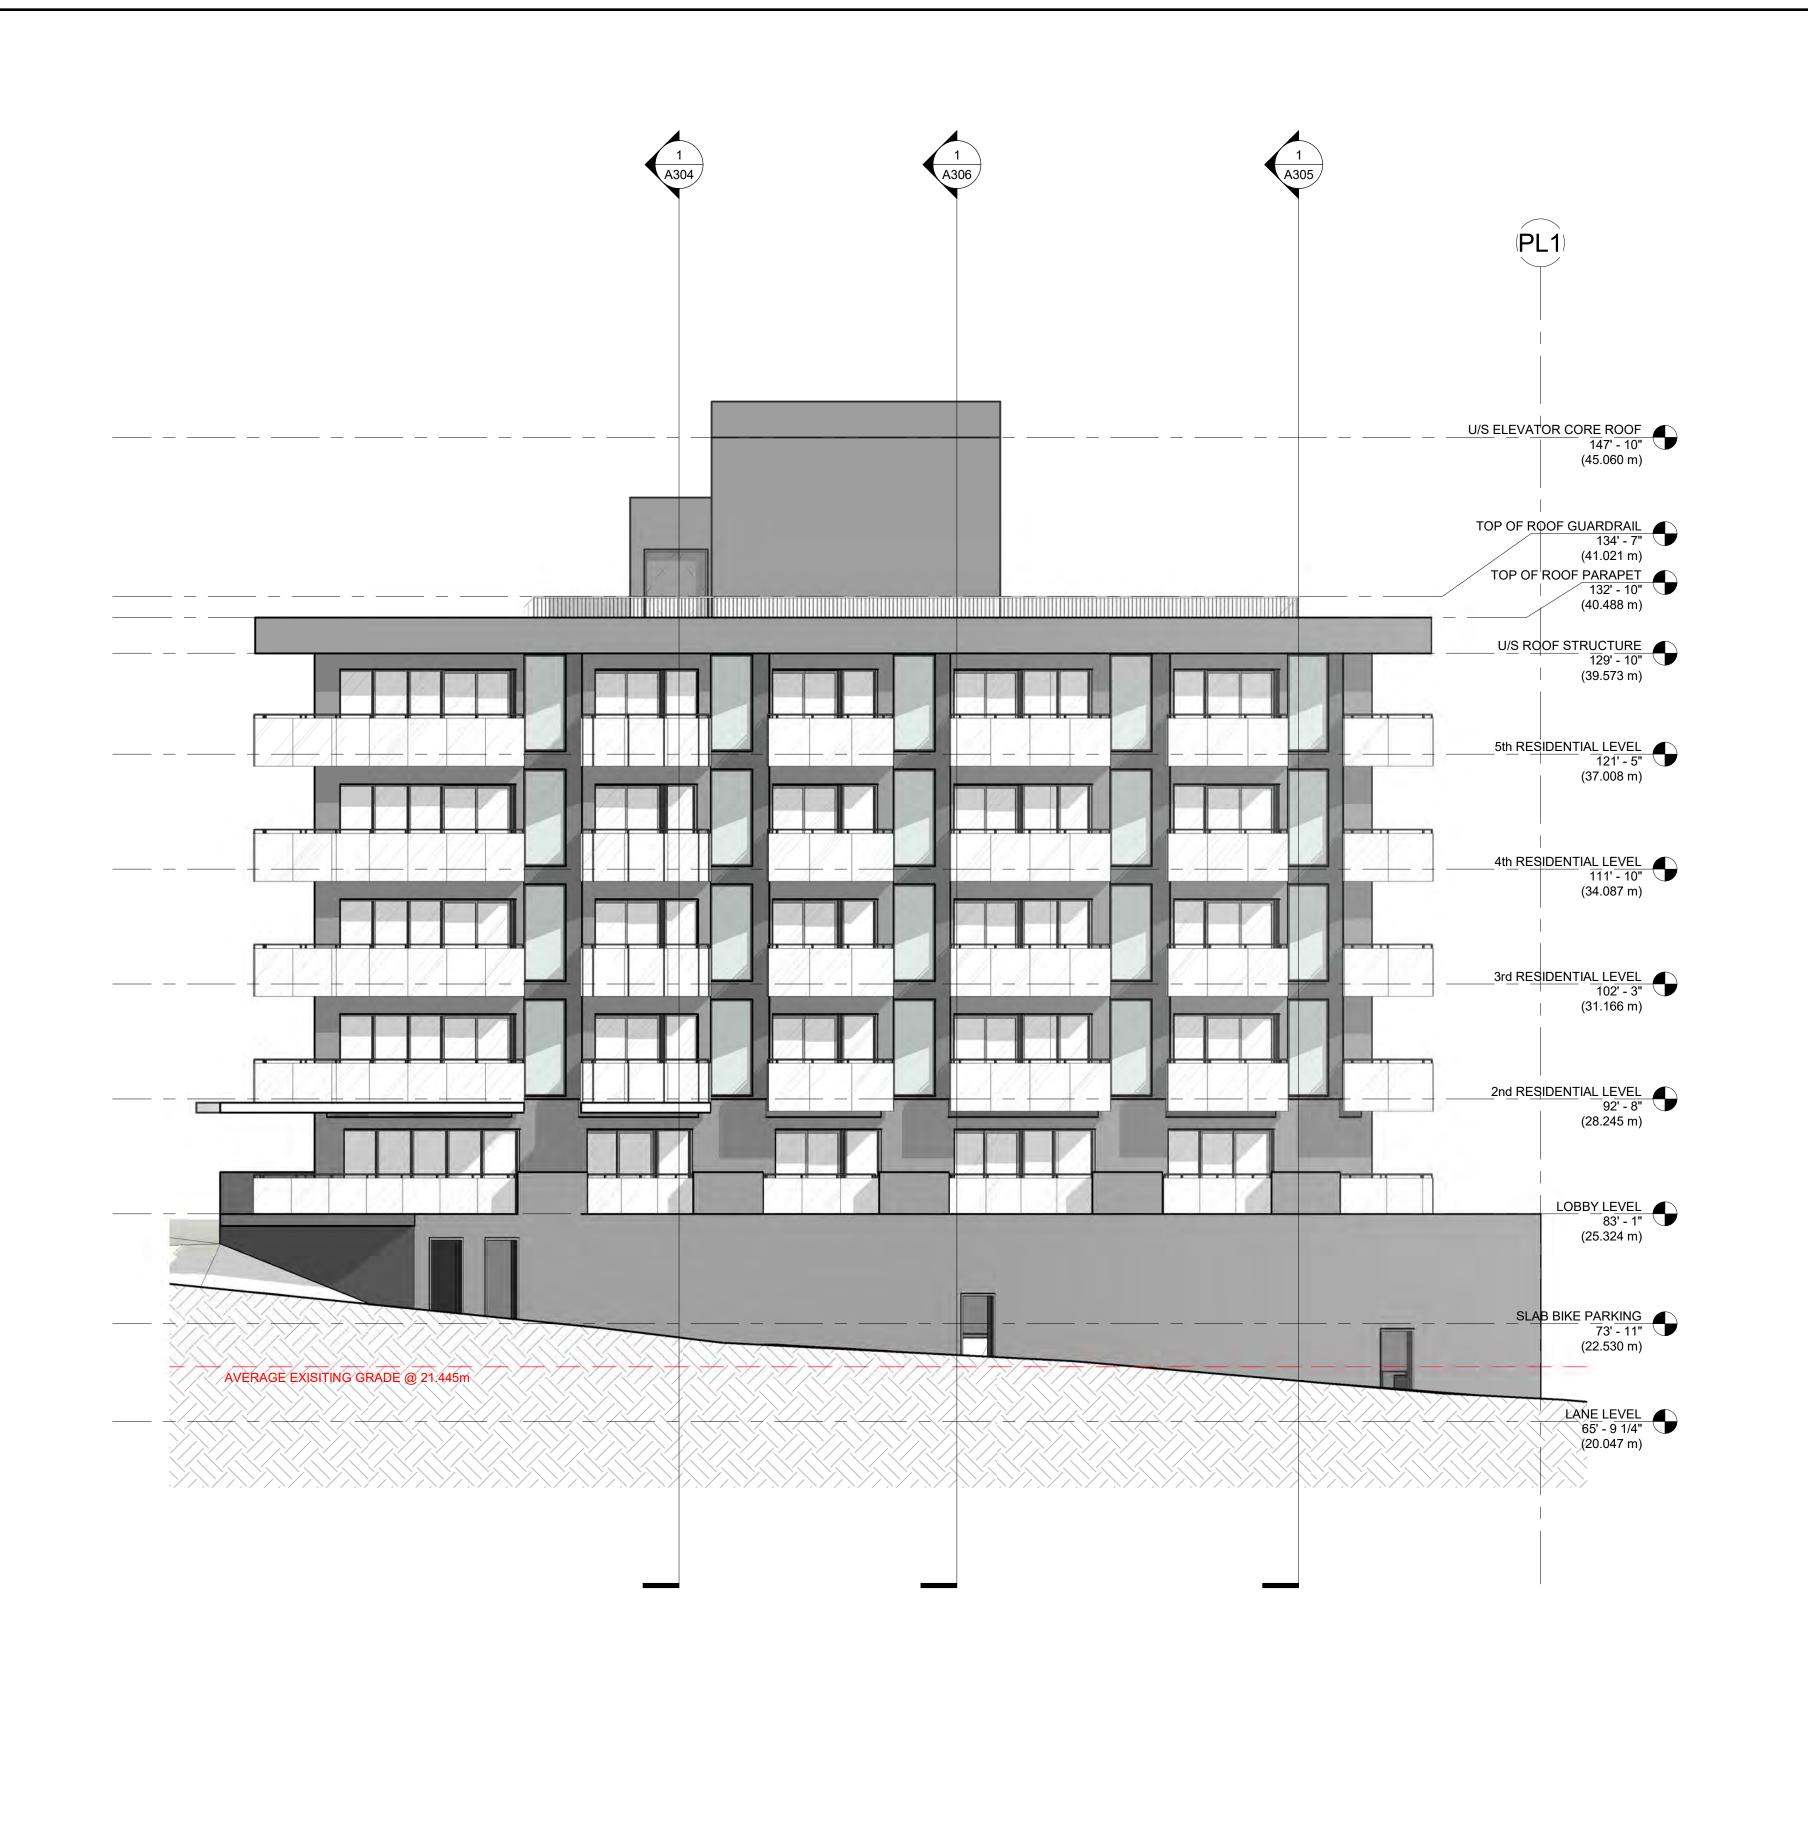
JIM PATTISON DEVELOPMENTS 351 3RD STREET WEST


351 WEST 3RD STREET NORTH VANCOUVER, BC V7M 1G3

SHEET TITLE

SOUTH ELEVATION

PLOT DATE:	PROJECT NO.
MARCH 23, 2022	24025
SCALE:	21035
1/8" = 1'-0"	
DRAWING NO.	REVISION
A202	



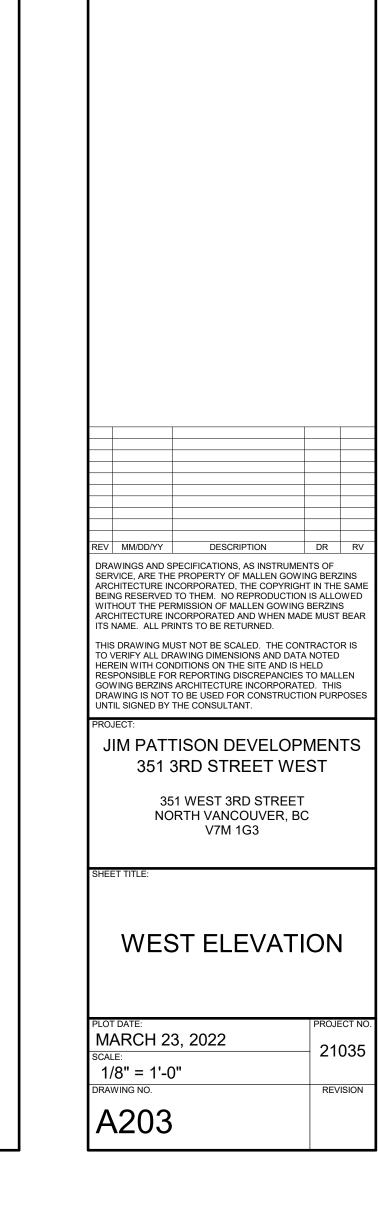

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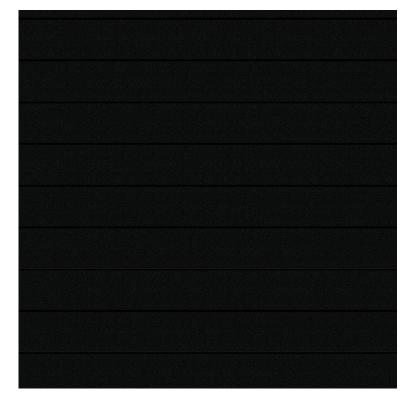
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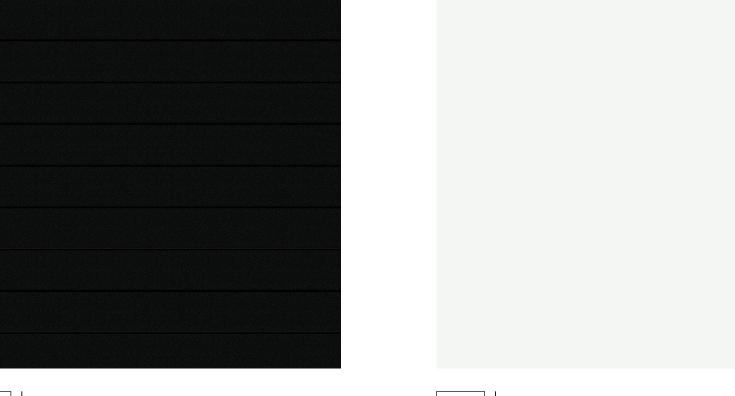
1 WEST ELEVATION
A203 SCALE: 1/8" = 1'-0"



1.1 TIGHT CORRUGATED METAL
Tightly-Spaced Corrugated Metal - Base Cladding Colour: Matte Black



1.2 WIDE CORRUGATED METAL
Wide Corrugated Metal Panel - Base Cladding Opt. 2 Colour: Matte Black



WIDE CORRUGATED METAL Wide Corrugated Metal Panel - Upper Wall Cladding Opt. 1 Colour: Cambridge White




TIGHT CORRUGATED METAL Tightly-Spaced Corrugated Metal - Parapet Cladding Opt. 1 Colour: Matte Black

WIDE CORRUGATED METAL

Hidden Fastener Cladding - Wall - Upper Cladding Opt 2.

Colour: White-White

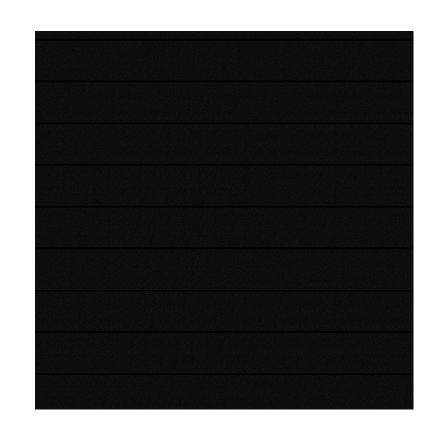

WIDE CORRUGATED METAL Wide Corrugated Metal Panel - Parapet Cladding Opt. 2 Colour: Matte Black





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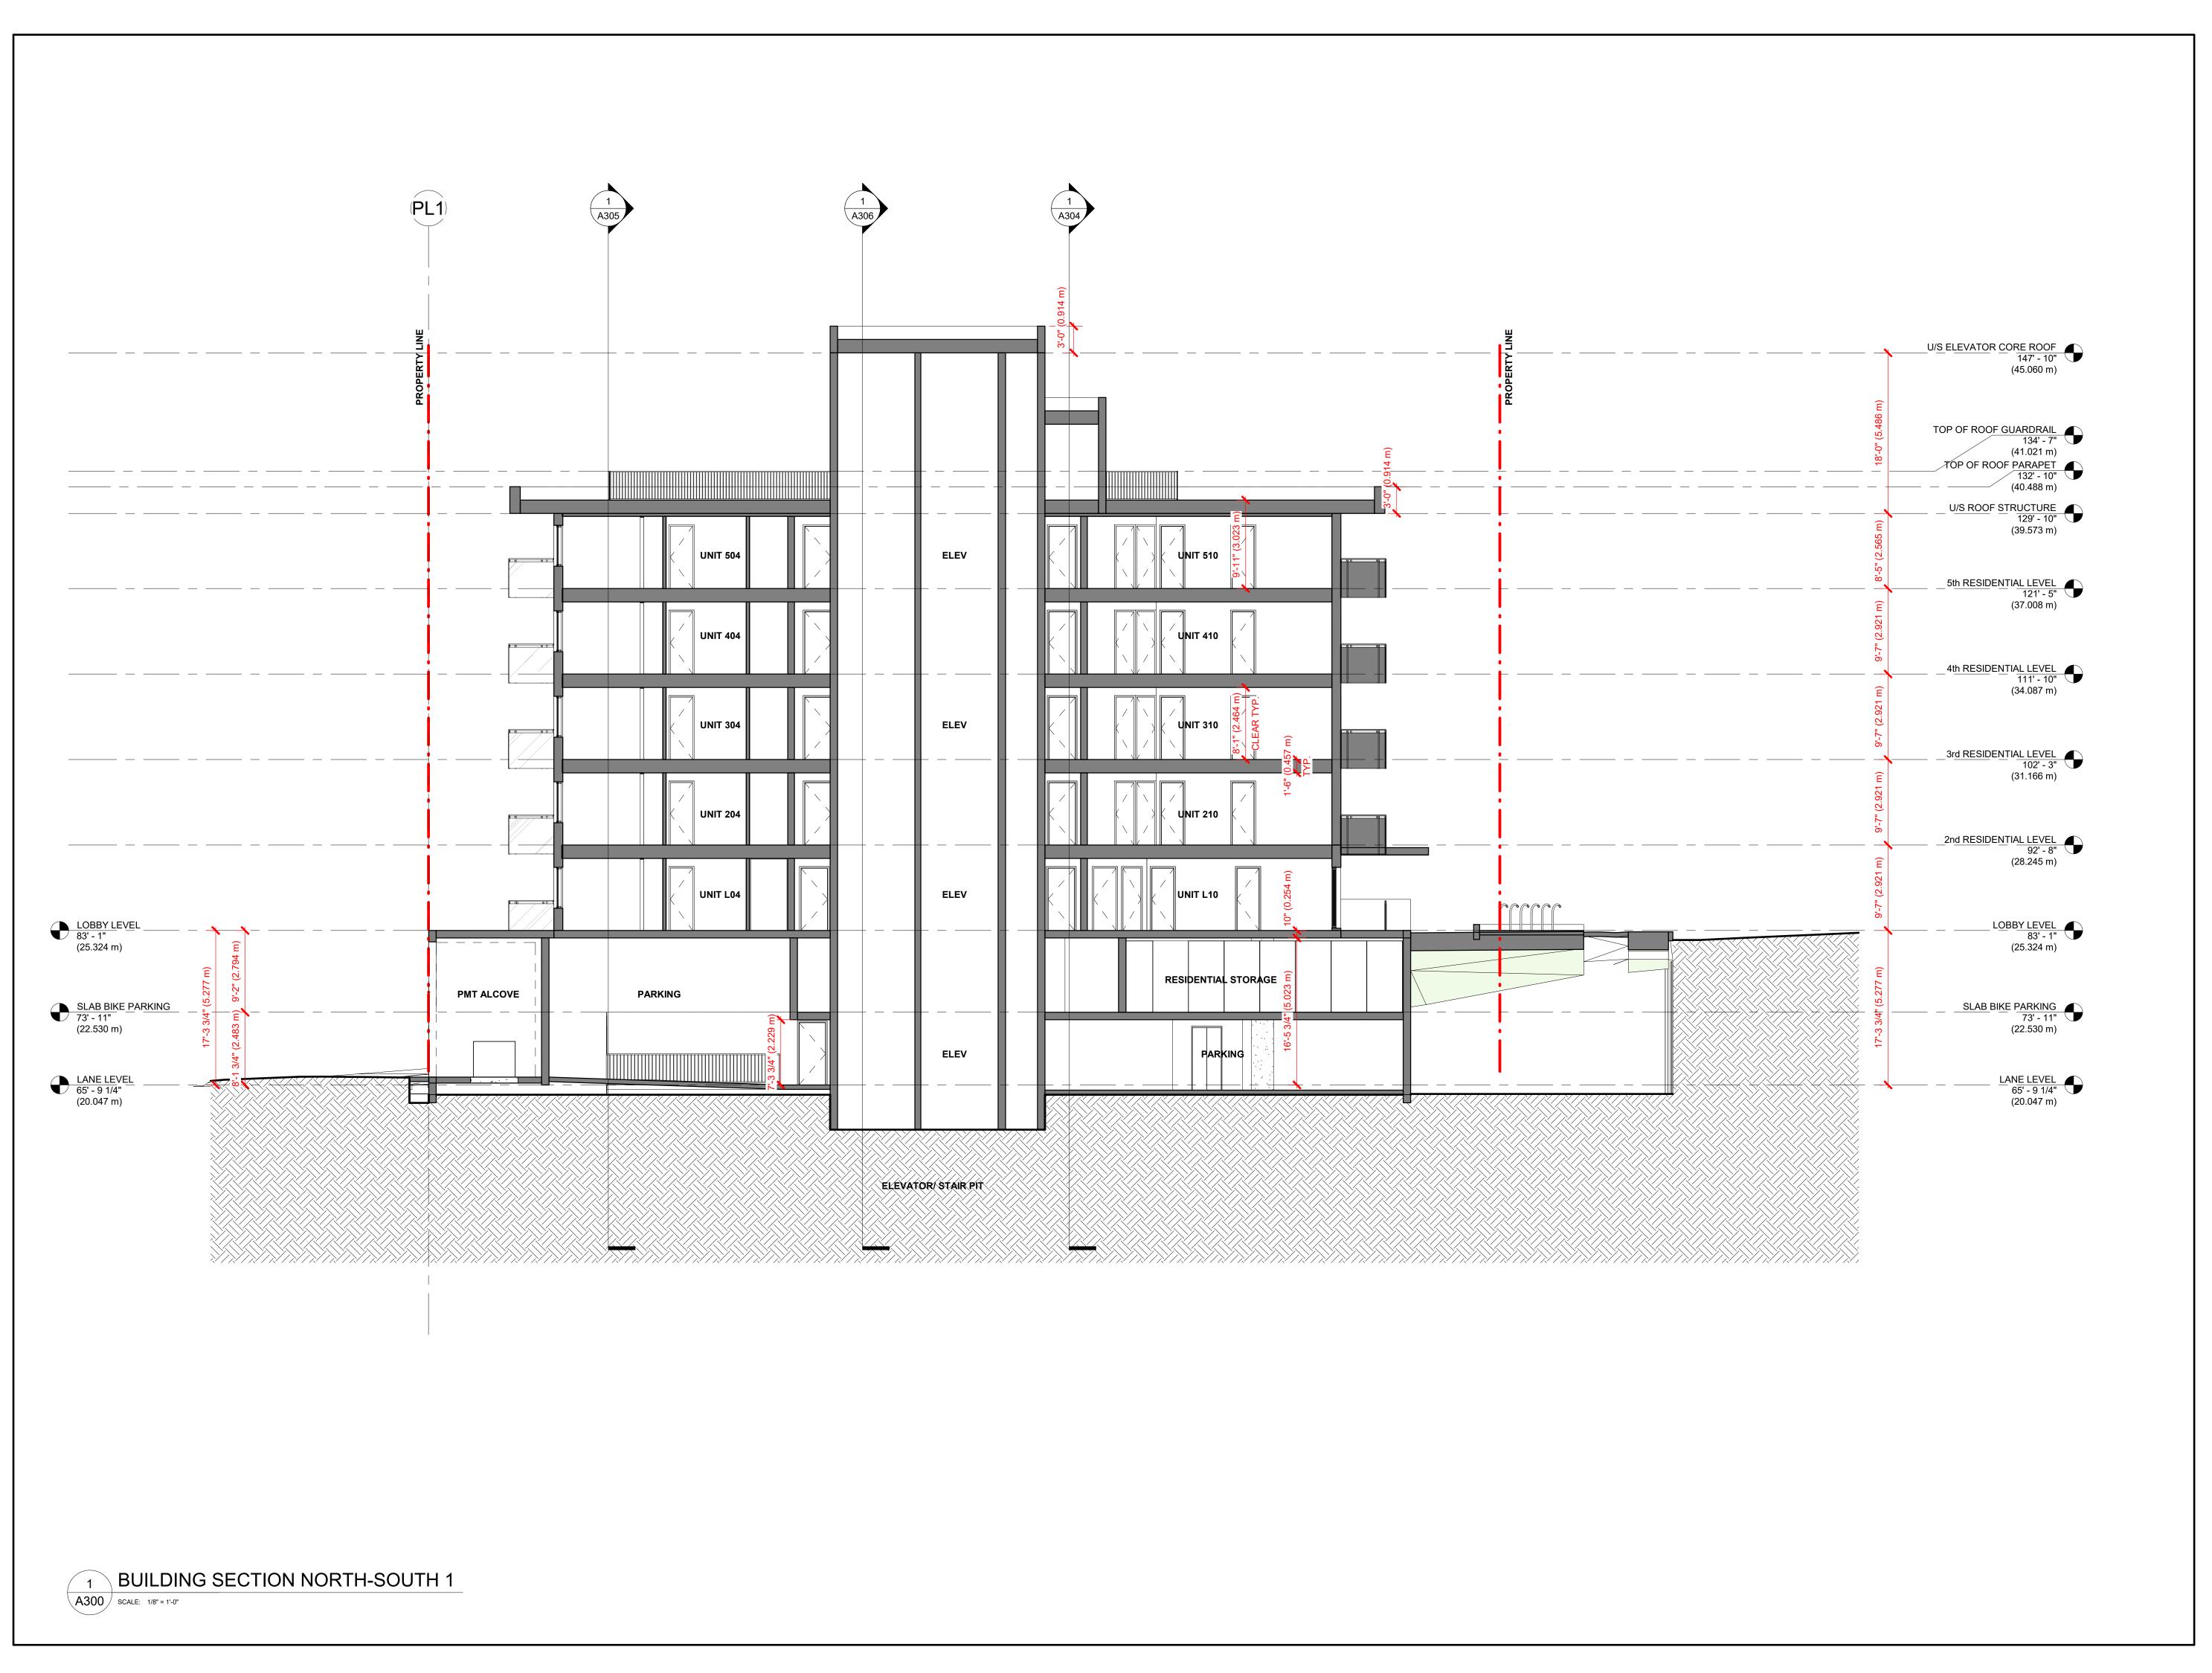
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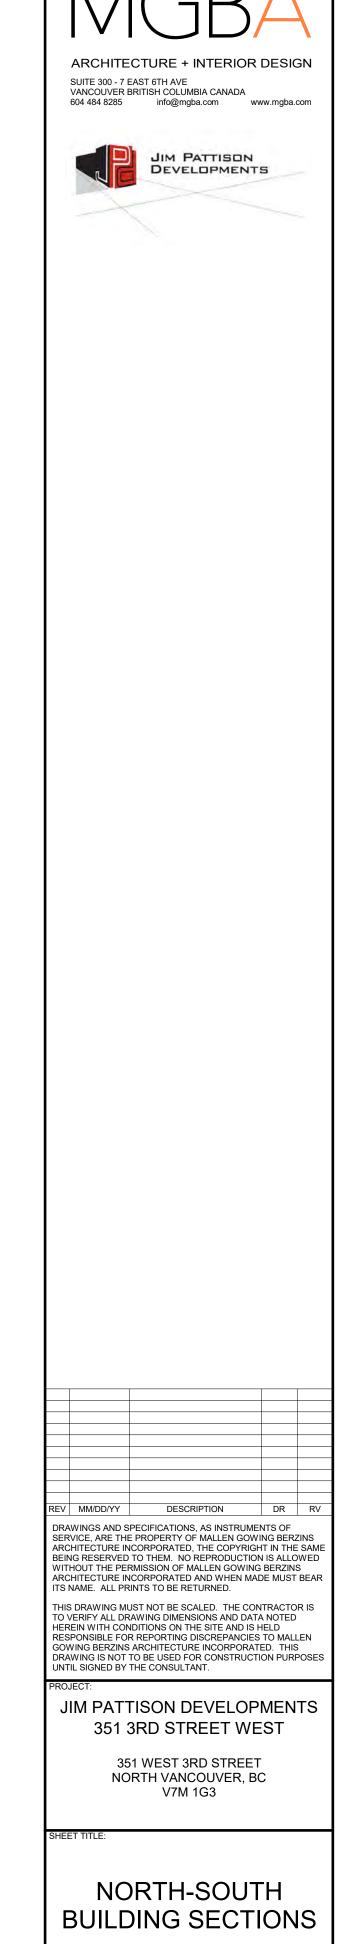
JIM PATTISON DEVELOPMENTS 351 3RD STREET WEST

> 351 WEST 3RD STREET NORTH VANCOUVER, BC V7M 1G3

MATERIAL BOARD

PLOT DATE:	PROJECT NO.
MARCH 23, 2022	21035
SCALE:	21033
1" = 1'-0"	
DRAWING NO.	REVISION
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MARCH 23, 2022


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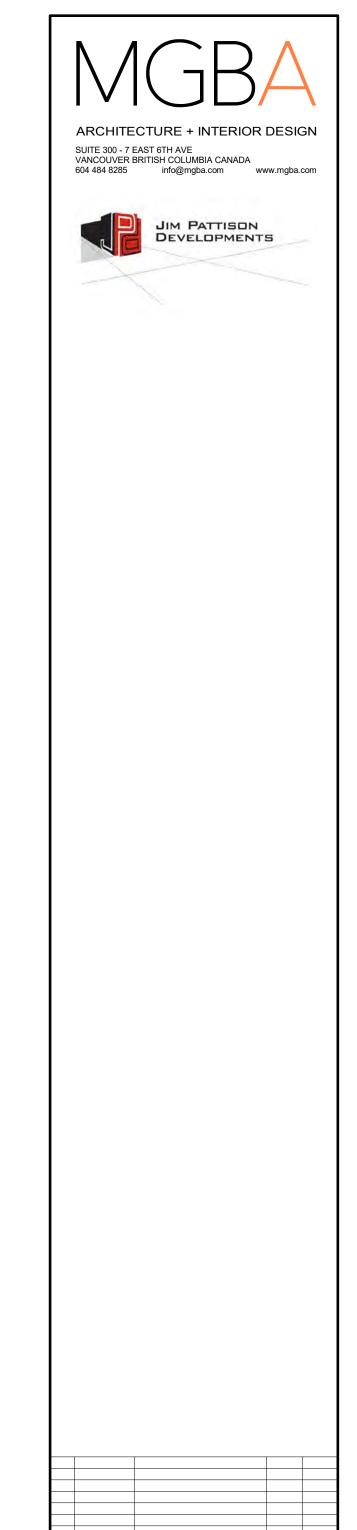
DRAWING NO.

A300

21035

REVISION



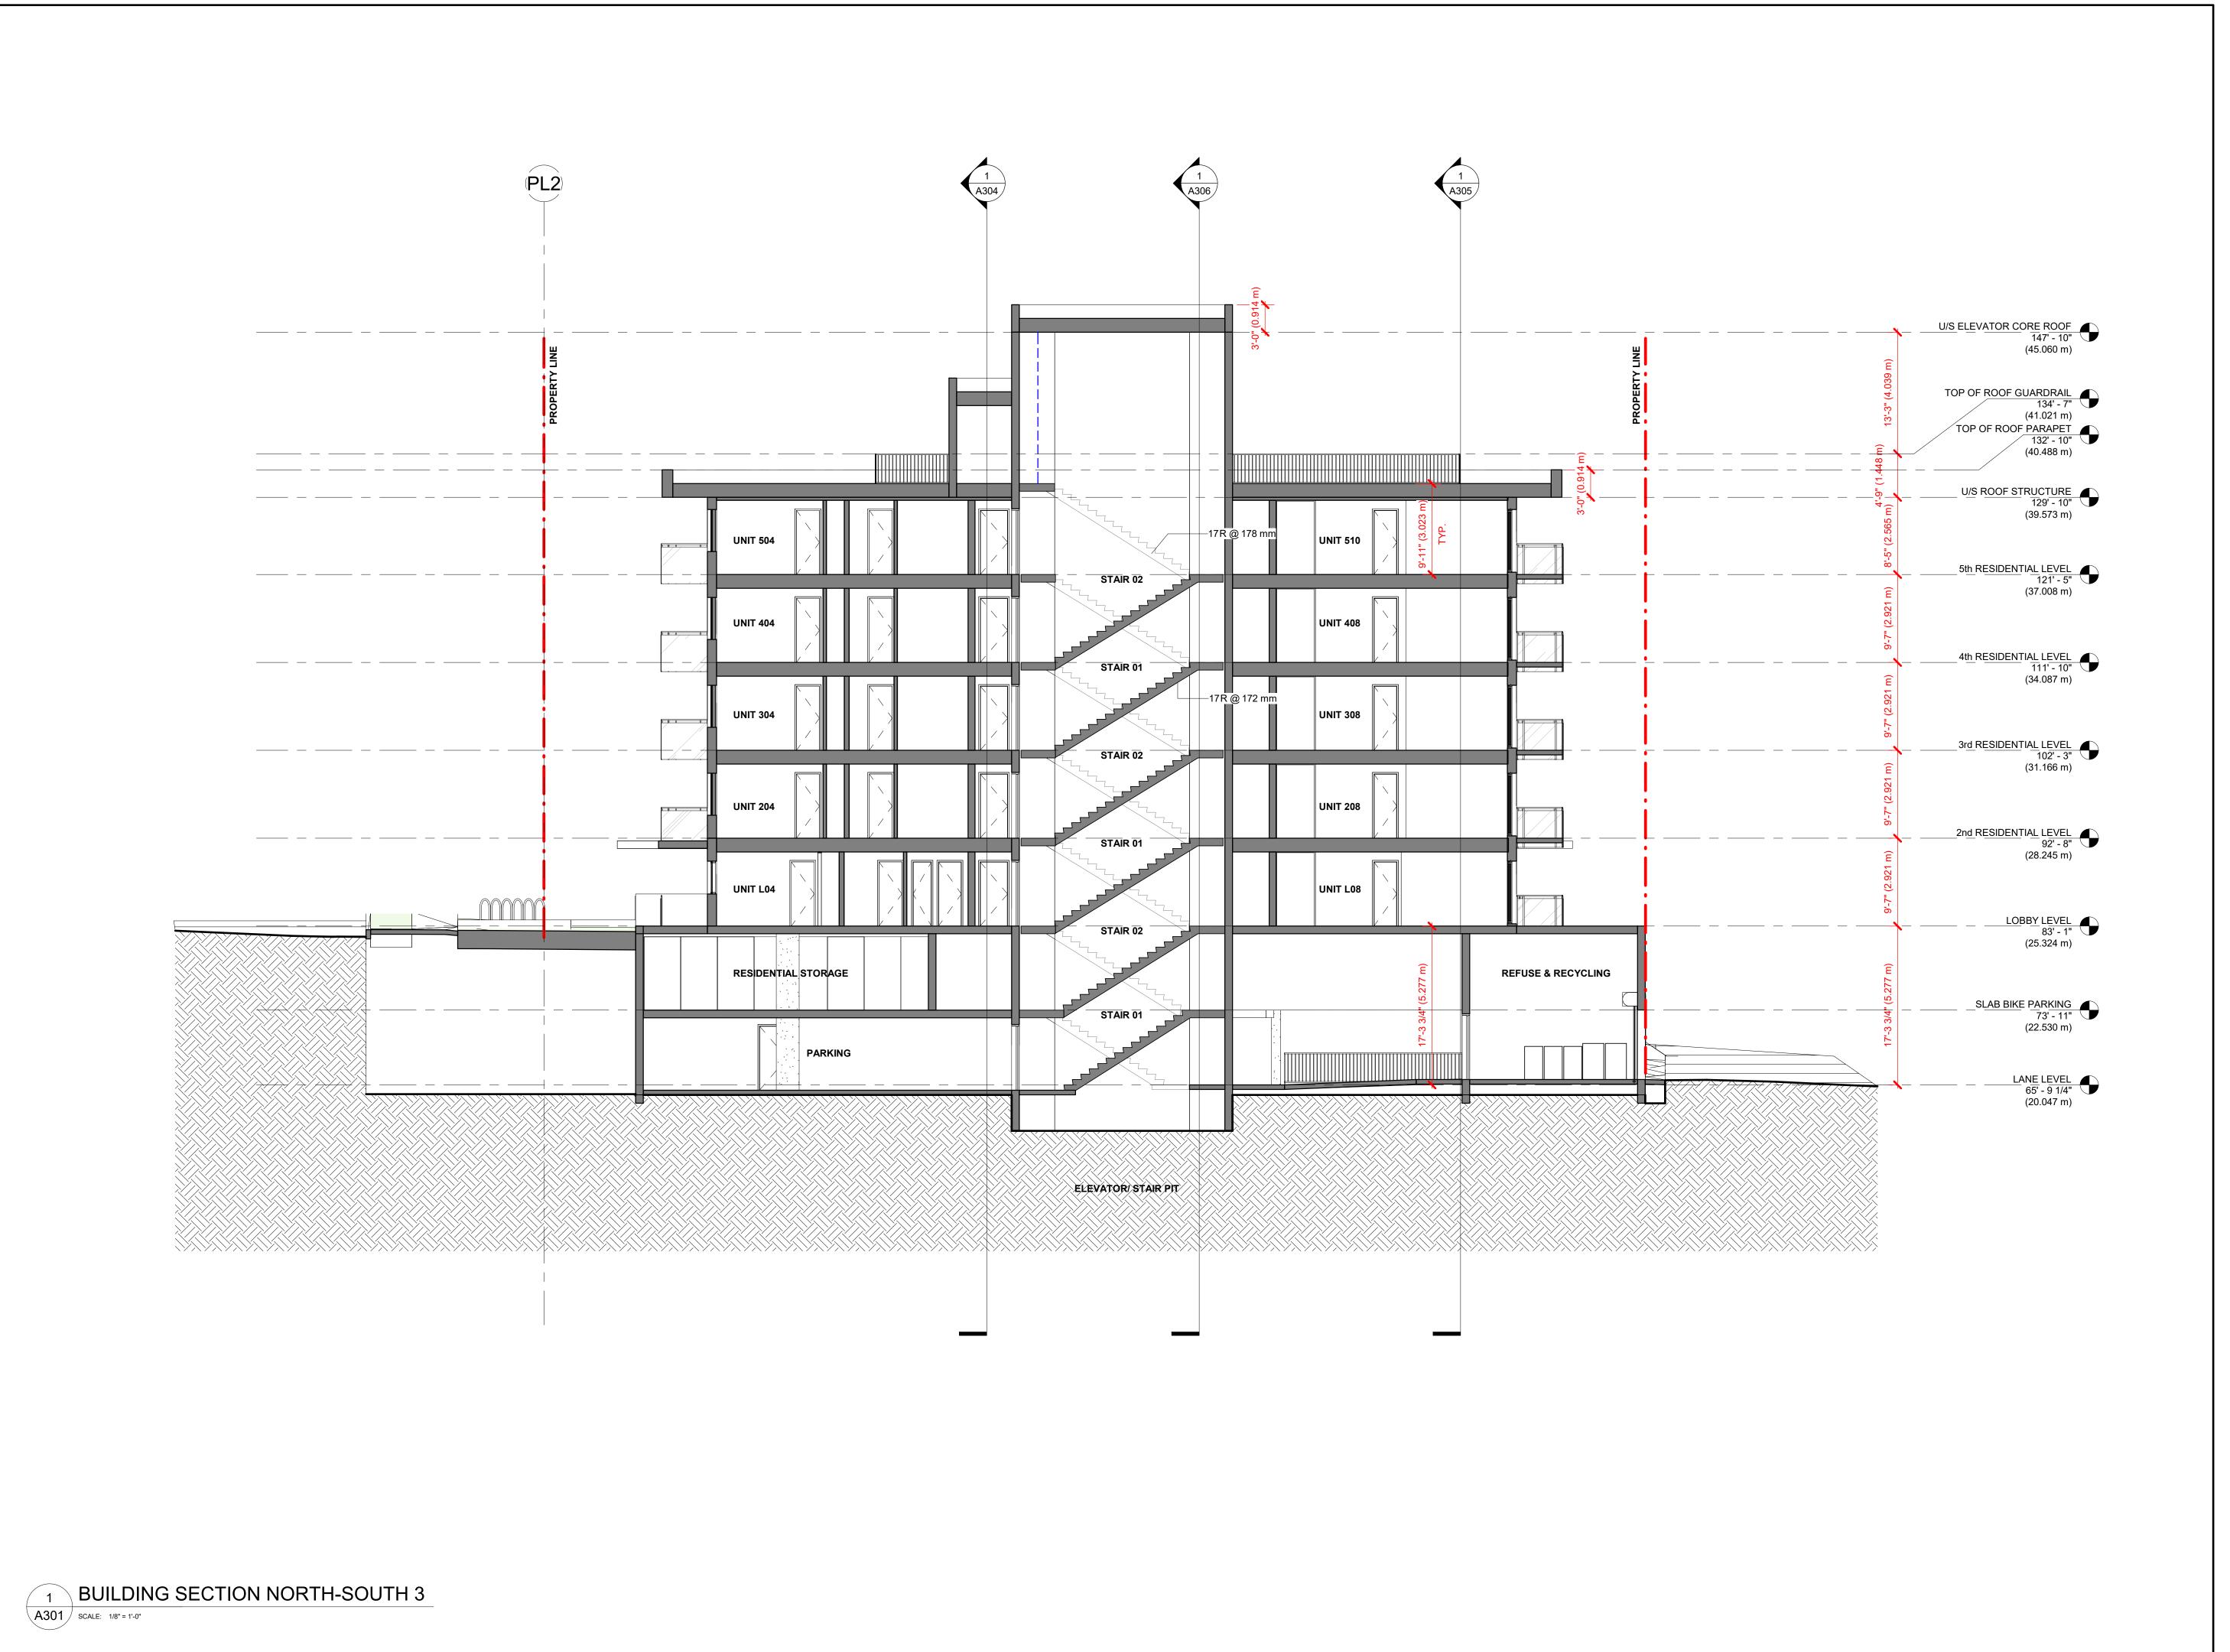

REV MM/DD/YY DESCRIPTION DR RV

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JIM PATTISON DEVELOPMENTS
351 3RD STREET WEST

351 WEST 3RD STREET NORTH VANCOUVER, BC V7M 1G3

SHEET TITLE:

NORTH-SOUTH
BUILDING SECTIONS

PLOT DATE:

MARCH 23, 2022

SCALE:

1/8" = 1'-0"


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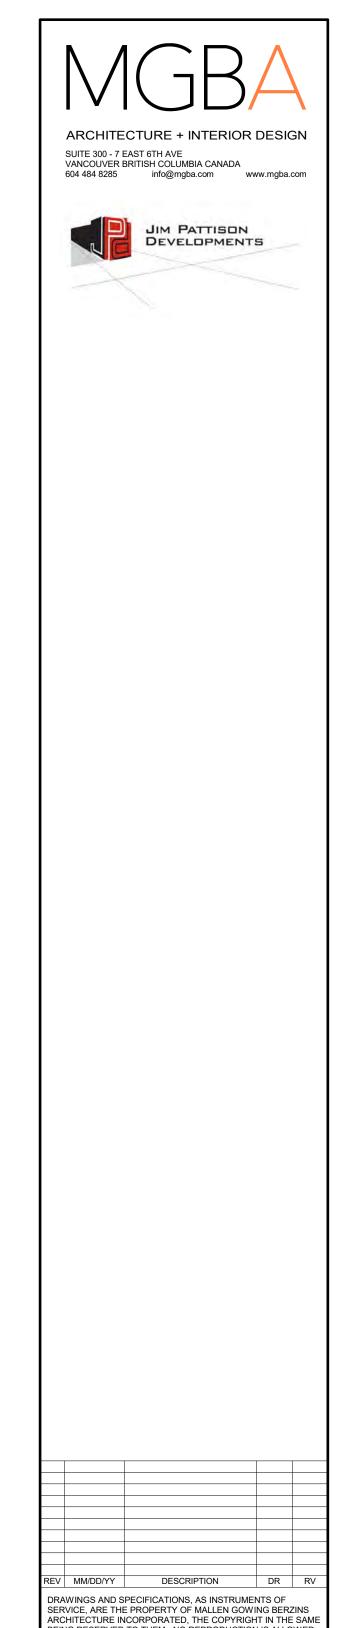
A301

PROJECT NO.

21035

REVISION



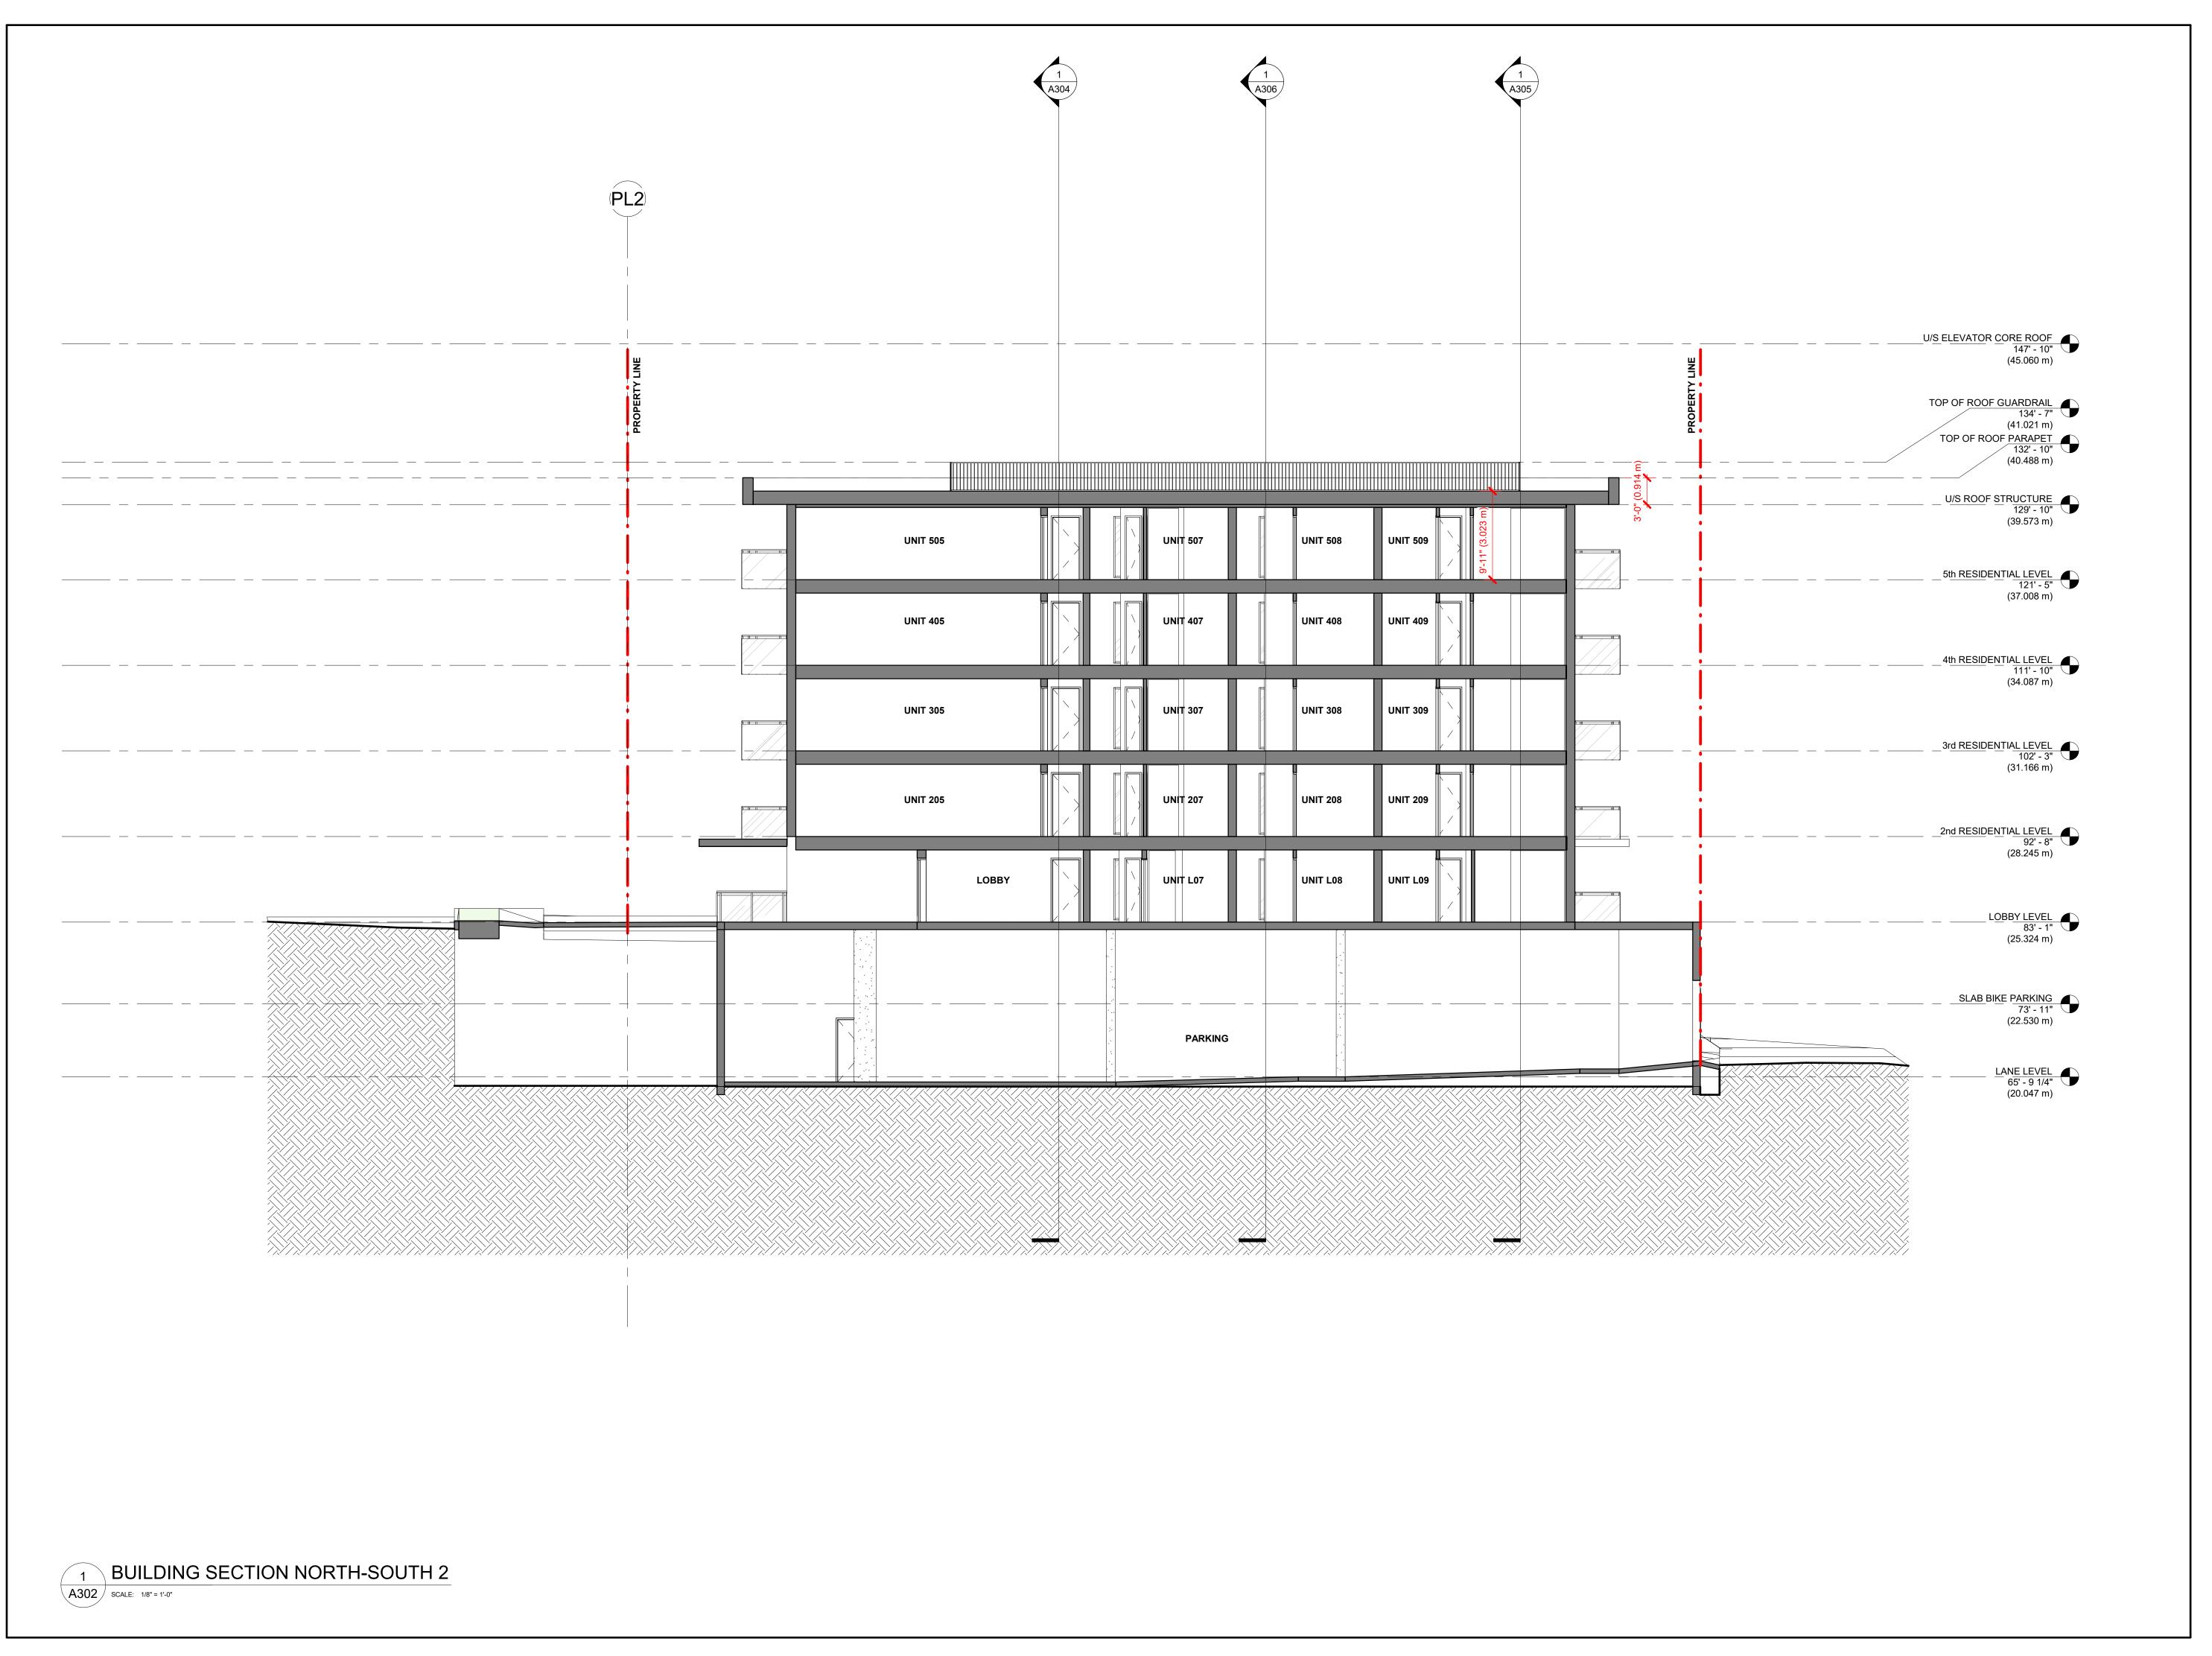

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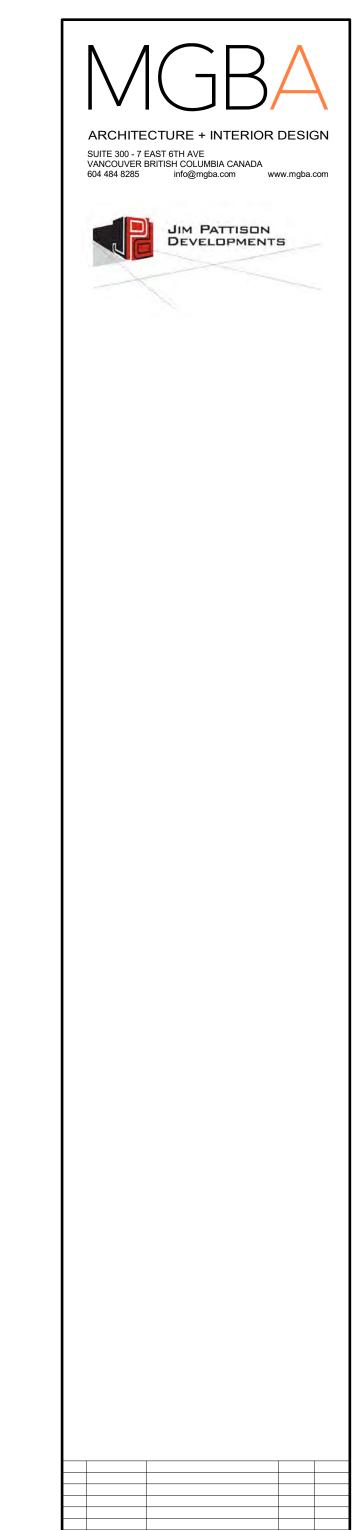
JIM PATTISON DEVELOPMENTS 351 3RD STREET WEST

> 351 WEST 3RD STREET NORTH VANCOUVER, BC V7M 1G3

NORTH-SOUTH **BUILDING SECTIONS**

MARCH 23, 2022 21035 1/8" = 1'-0" REVISION DRAWING NO. A302





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PROJECT:

JIM PATTISON DEVELOPMENTS

351 3RD STREET WEST

351 WEST 3RD STREET NORTH VANCOUVER, BC V7M 1G3

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NORTH-SOUTH BUILDING SECTIONS

PLOT DATE:


MARCH 23, 2022


SCALE:

1/8" = 1'-0"

DRAWING NO.

A303

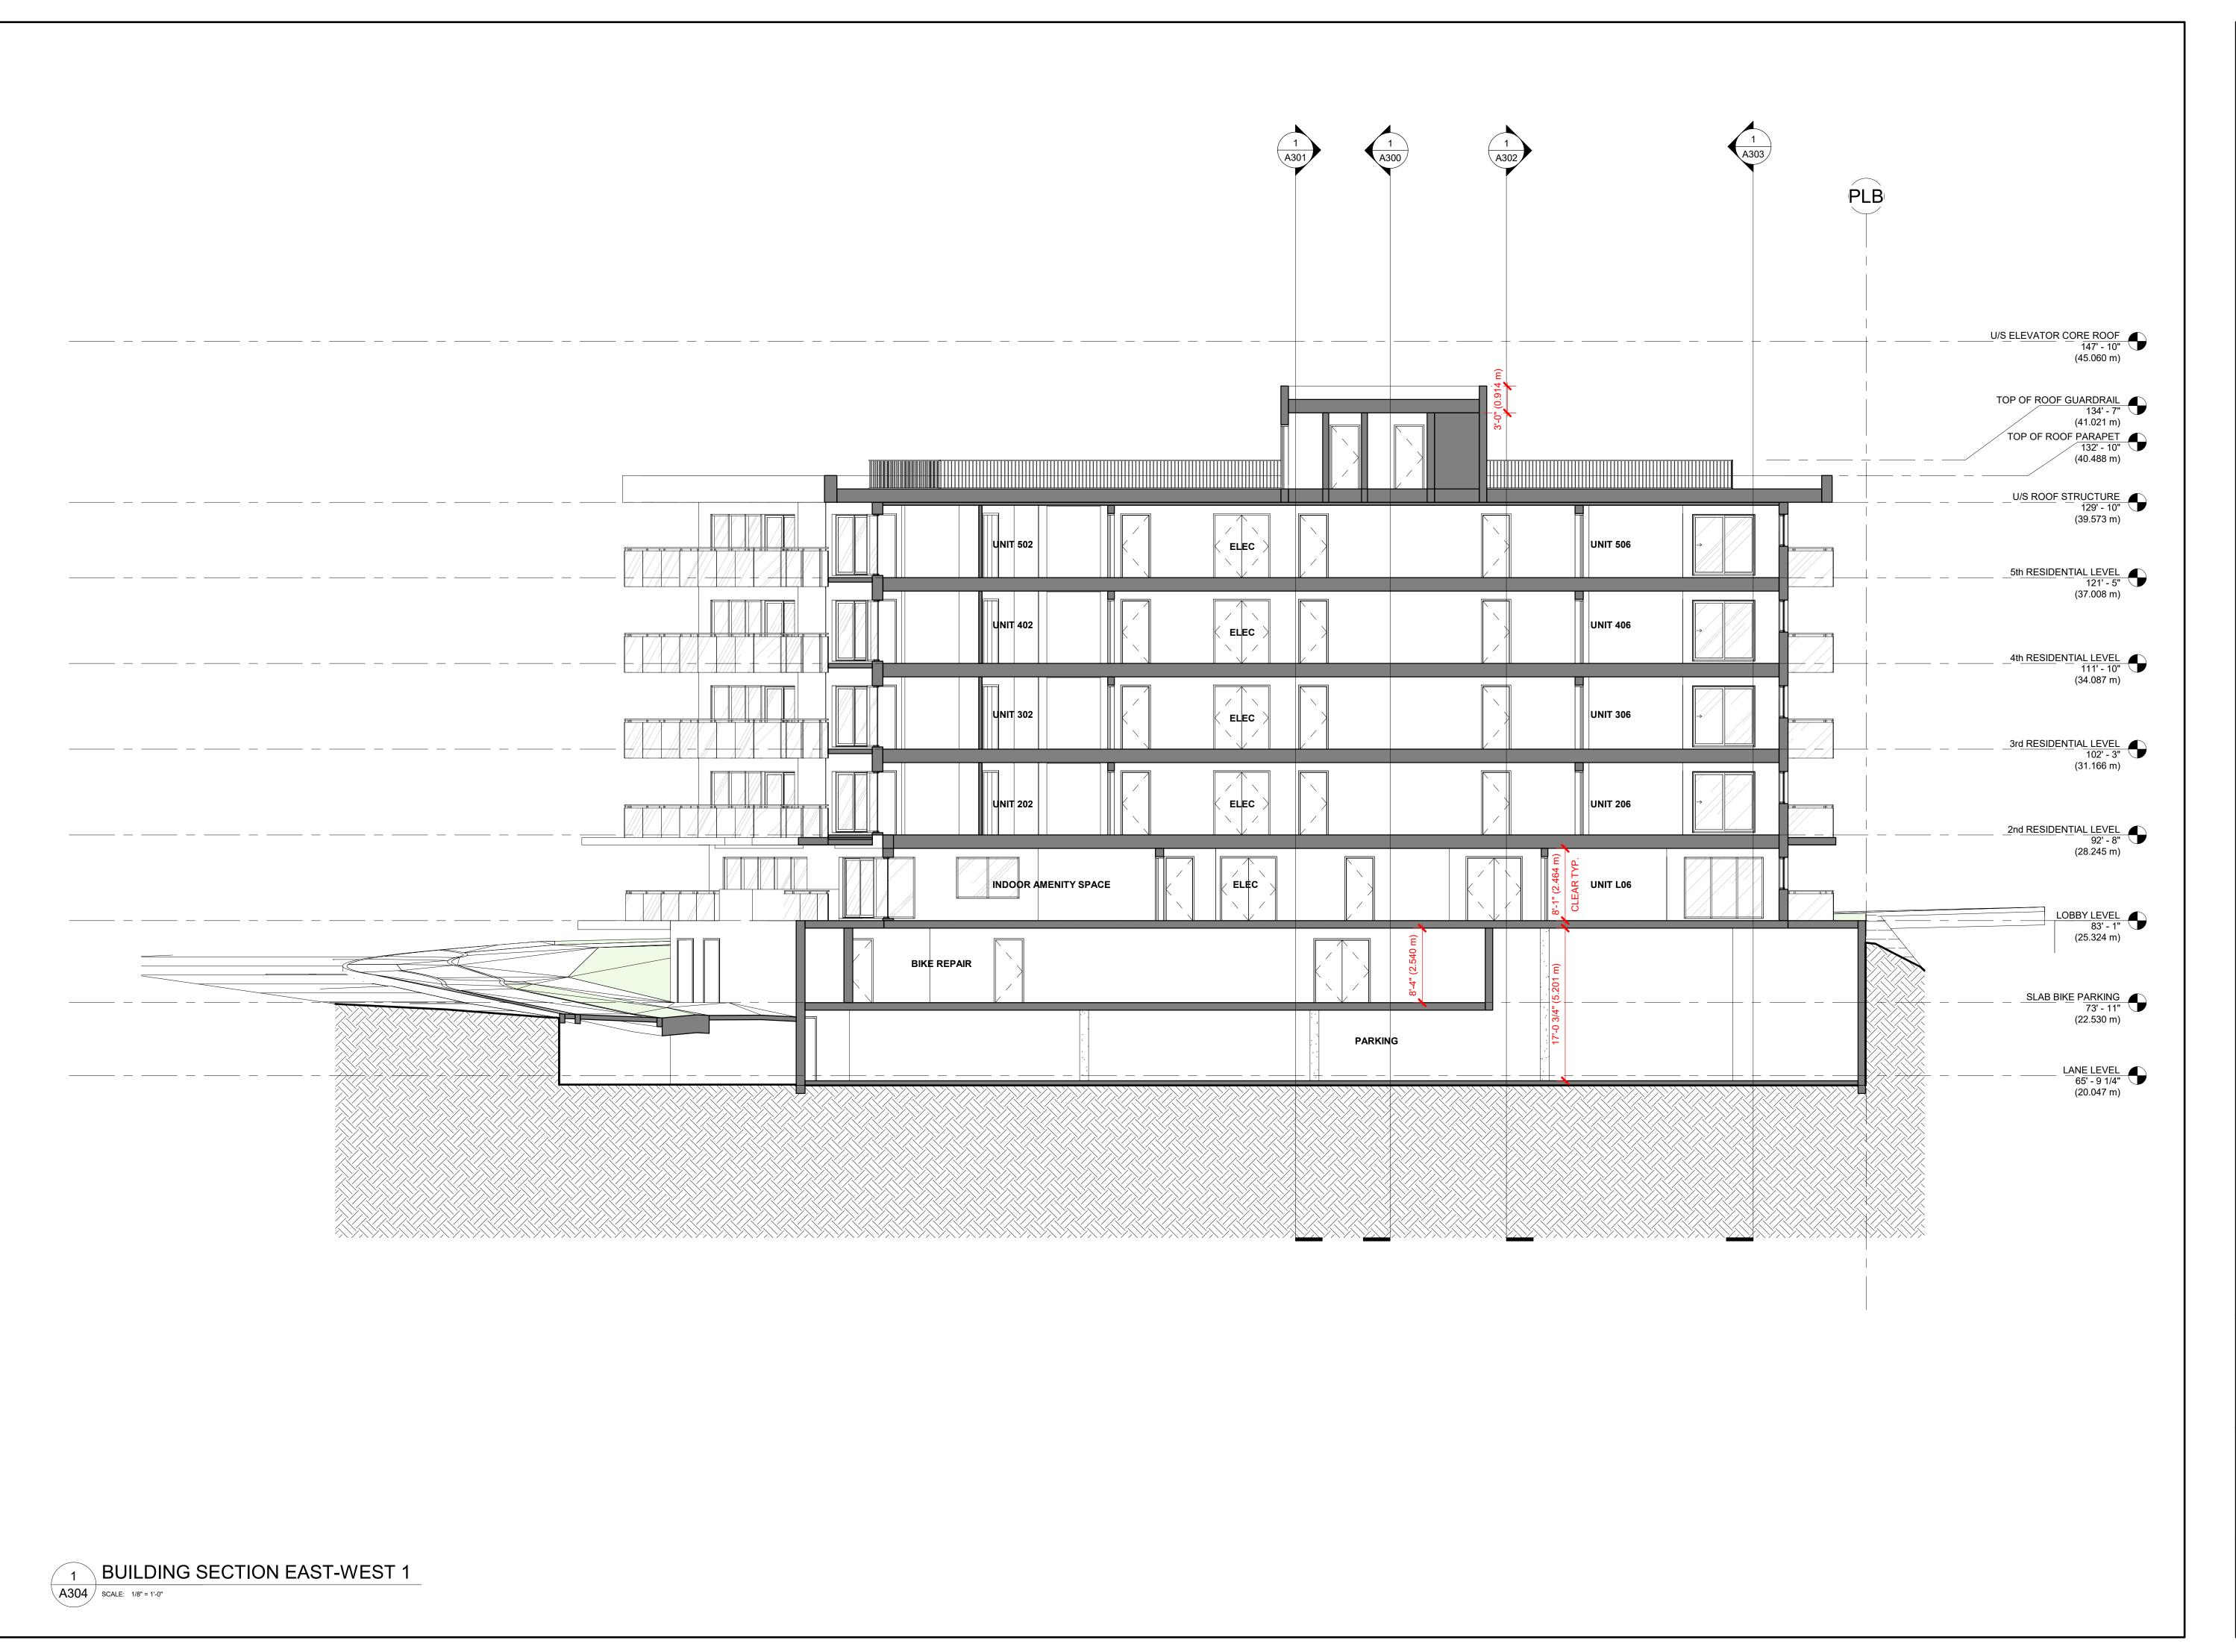

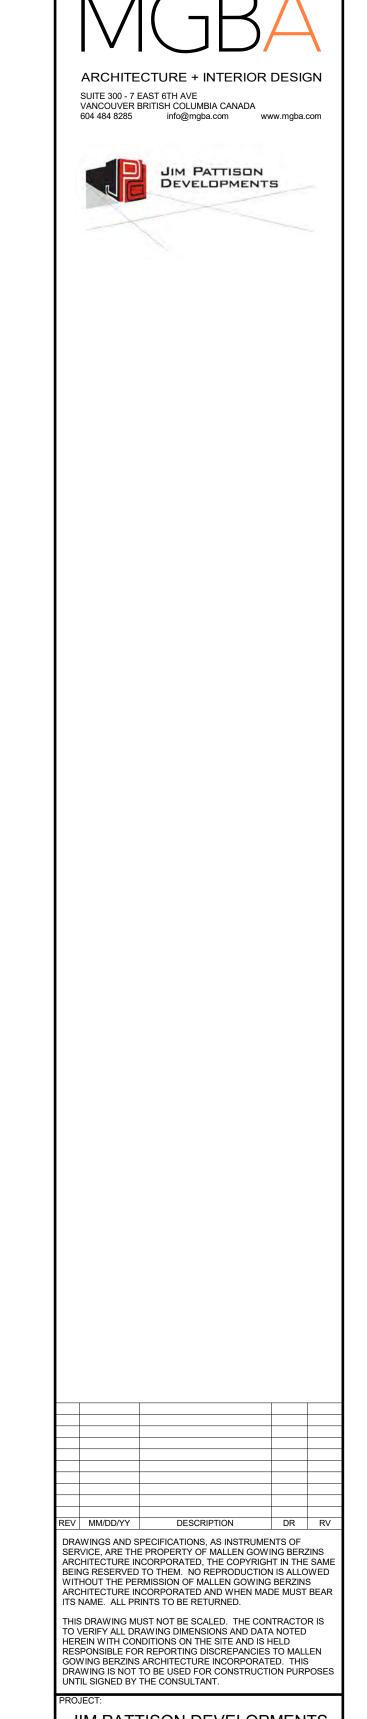


JIM PATTISON DEVELOPMENTS 351 3RD STREET WEST

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SHEET TITLE:

EAST-WEST BUILDING SECTIONS

	DATE:	PROJECT NO.
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ARCHITECTURE + INTERIOR DESIGN SUITE 300 - 7 EAST 6TH AVE VANCOUVER BRITISH COLUMBIA CANADA 604 484 8285 info@mgba.com www.mgba.com JIM PATTISON DEVELOPMENTS DRAWINGS AND SPECIFICATIONS, AS INSTRUMENTS OF SERVICE, ARE THE PROPERTY OF MALLEN GOWING BERZINS ARCHITECTURE INCORPORATED, THE COPYRIGHT IN THE SAME BEING RESERVED TO THEM. NO REPRODUCTION IS ALLOWED WITHOUT THE PERMISSION OF MALLEN GOWING BERZINS ARCHITECTURE INCORPORATED AND WHEN MADE MUST BEAR ITS NAME. ALL PRINTS TO BE RETURNED.


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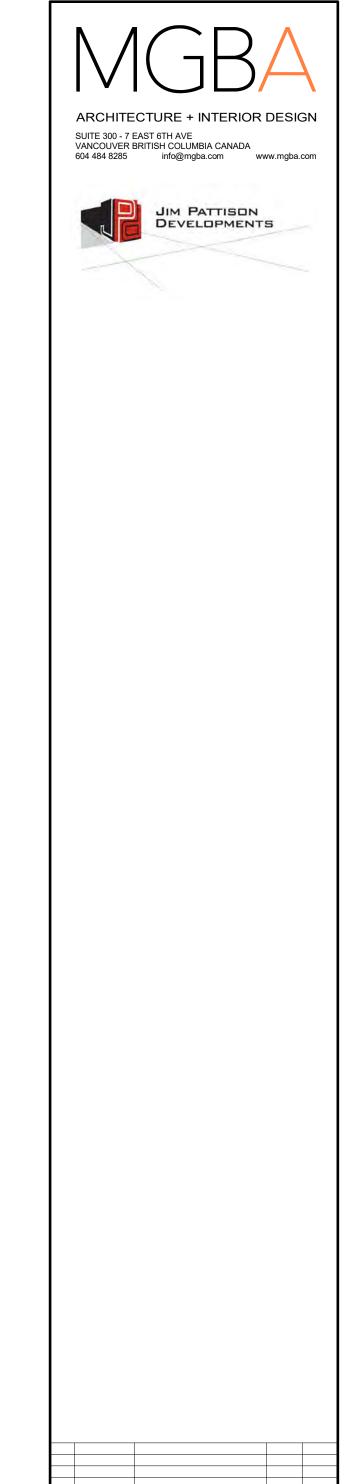
JIM PATTISON DEVELOPMENTS 351 3RD STREET WEST
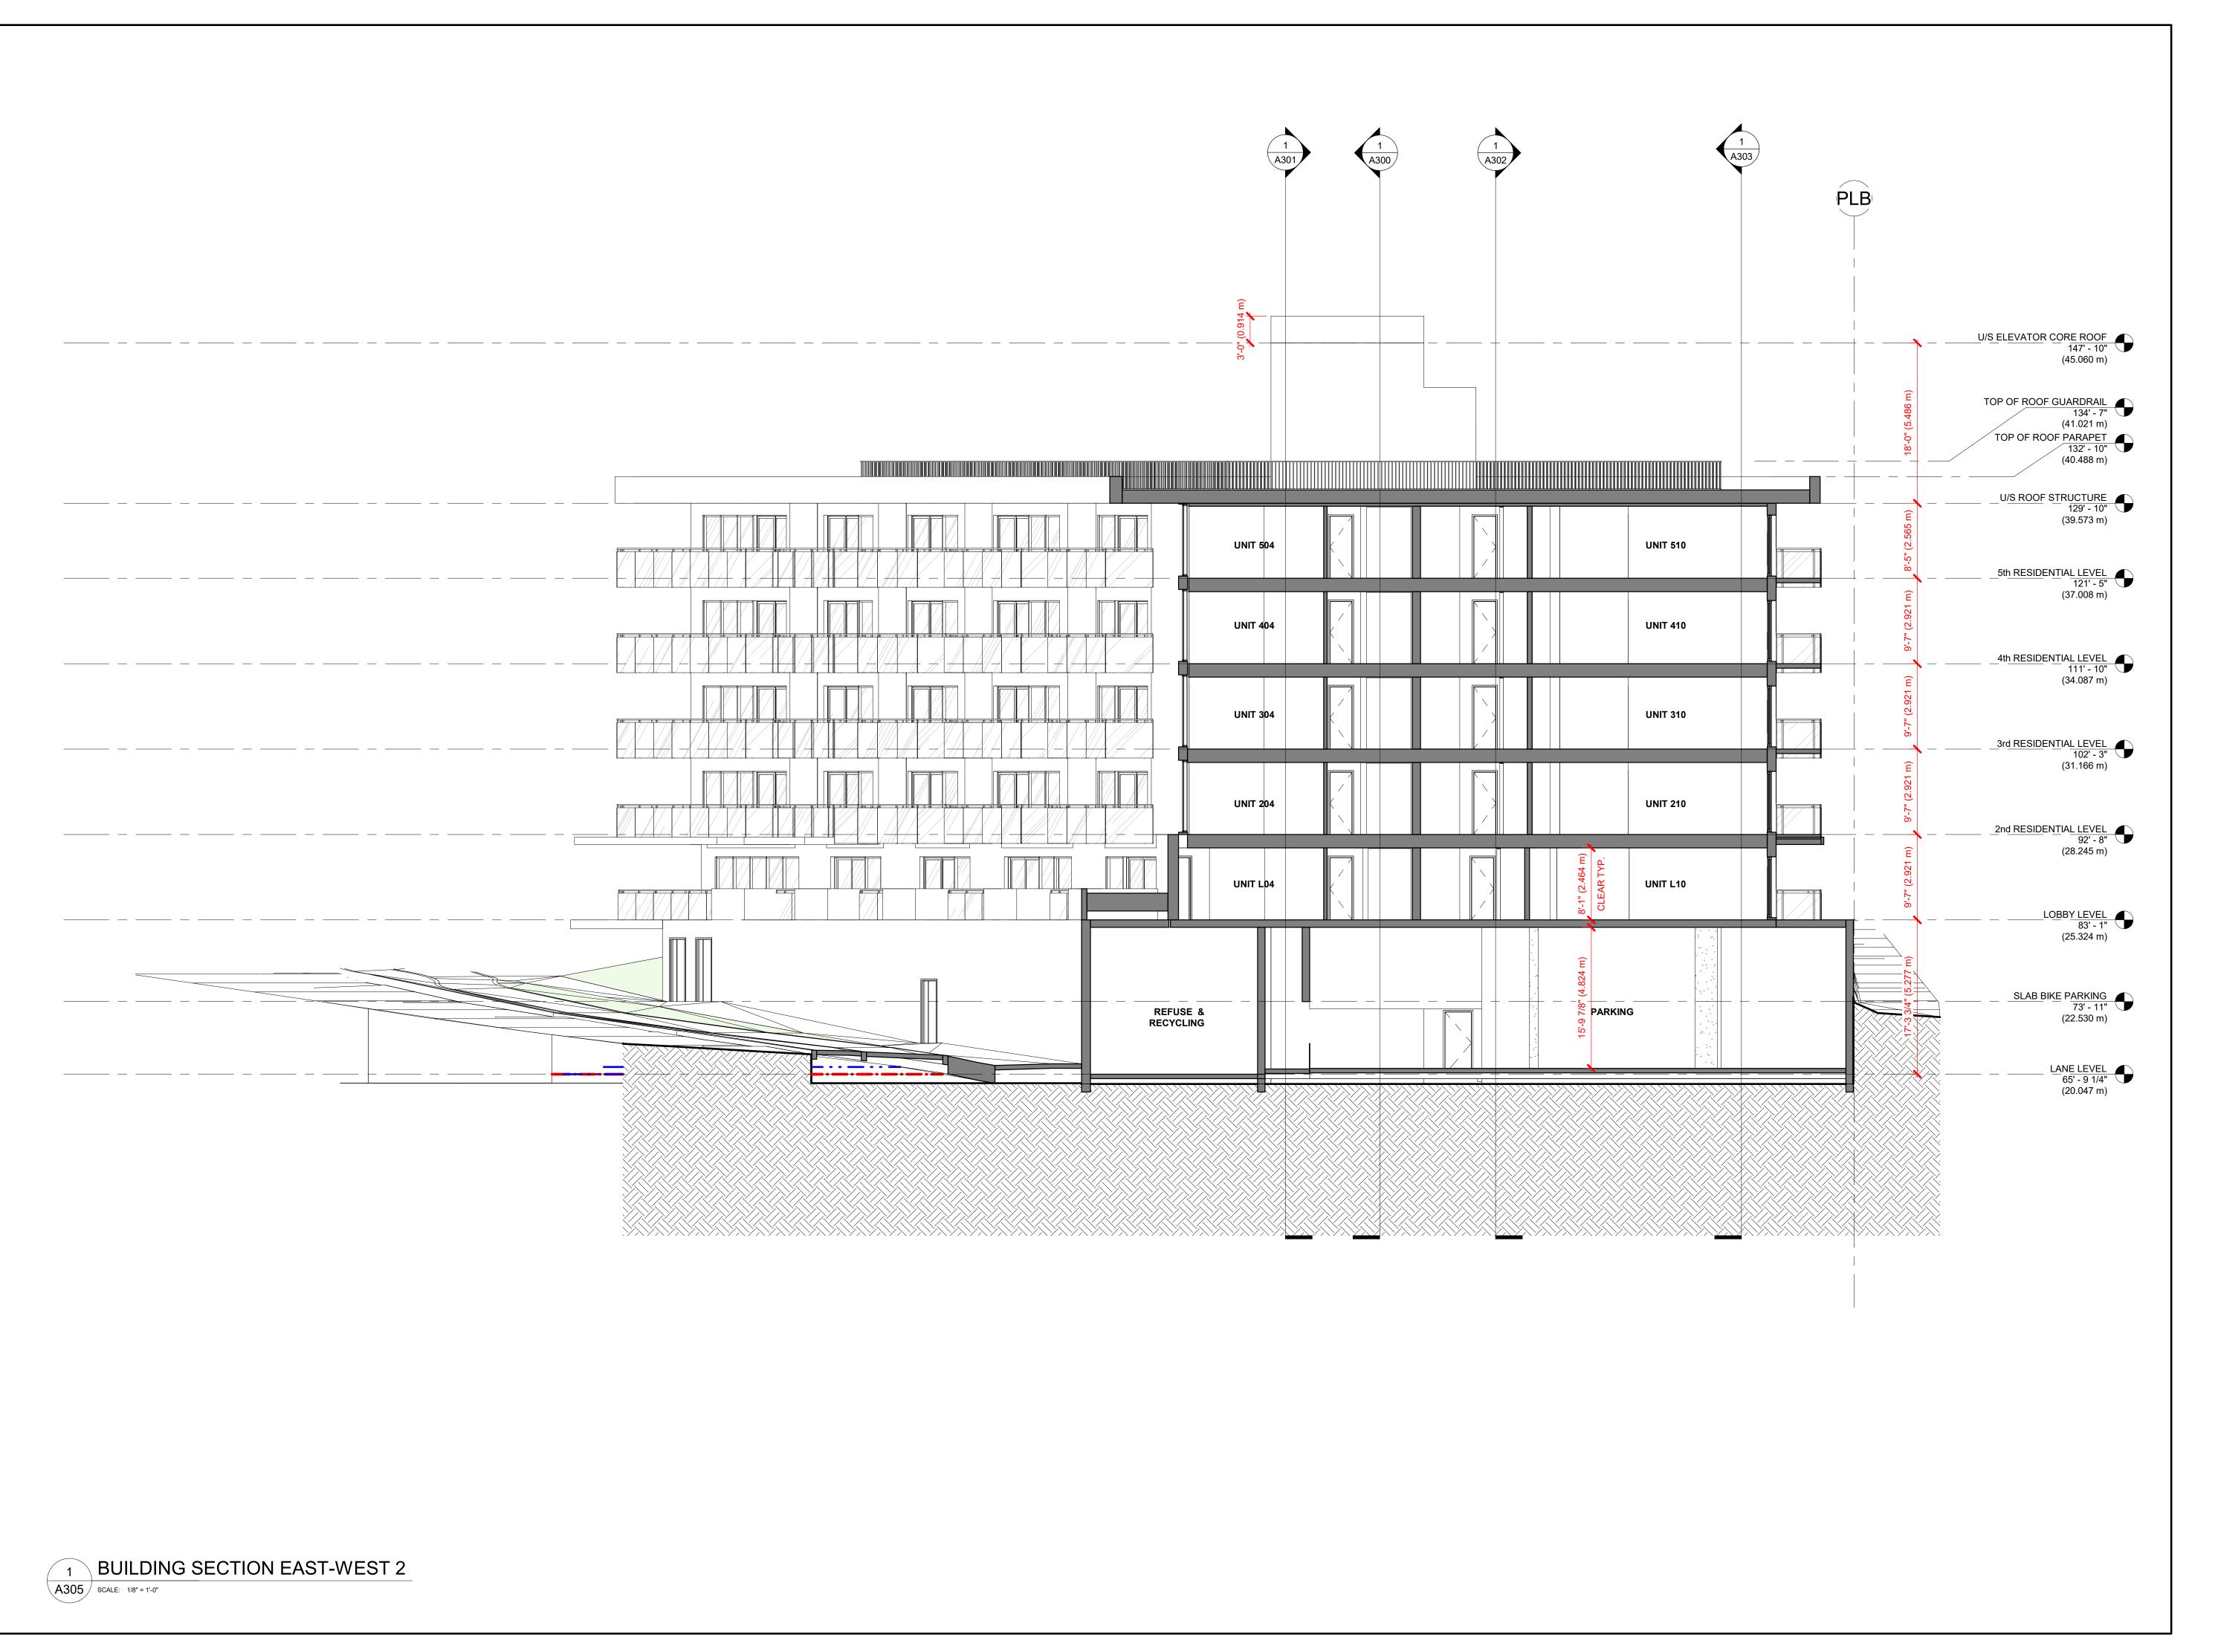
> 351 WEST 3RD STREET NORTH VANCOUVER, BC V7M 1G3

EAST-WEST BUILDING SECTIONS

MARCH 23, 2022 21035 1/8" = 1'-0" REVISION DRAWING NO. A305



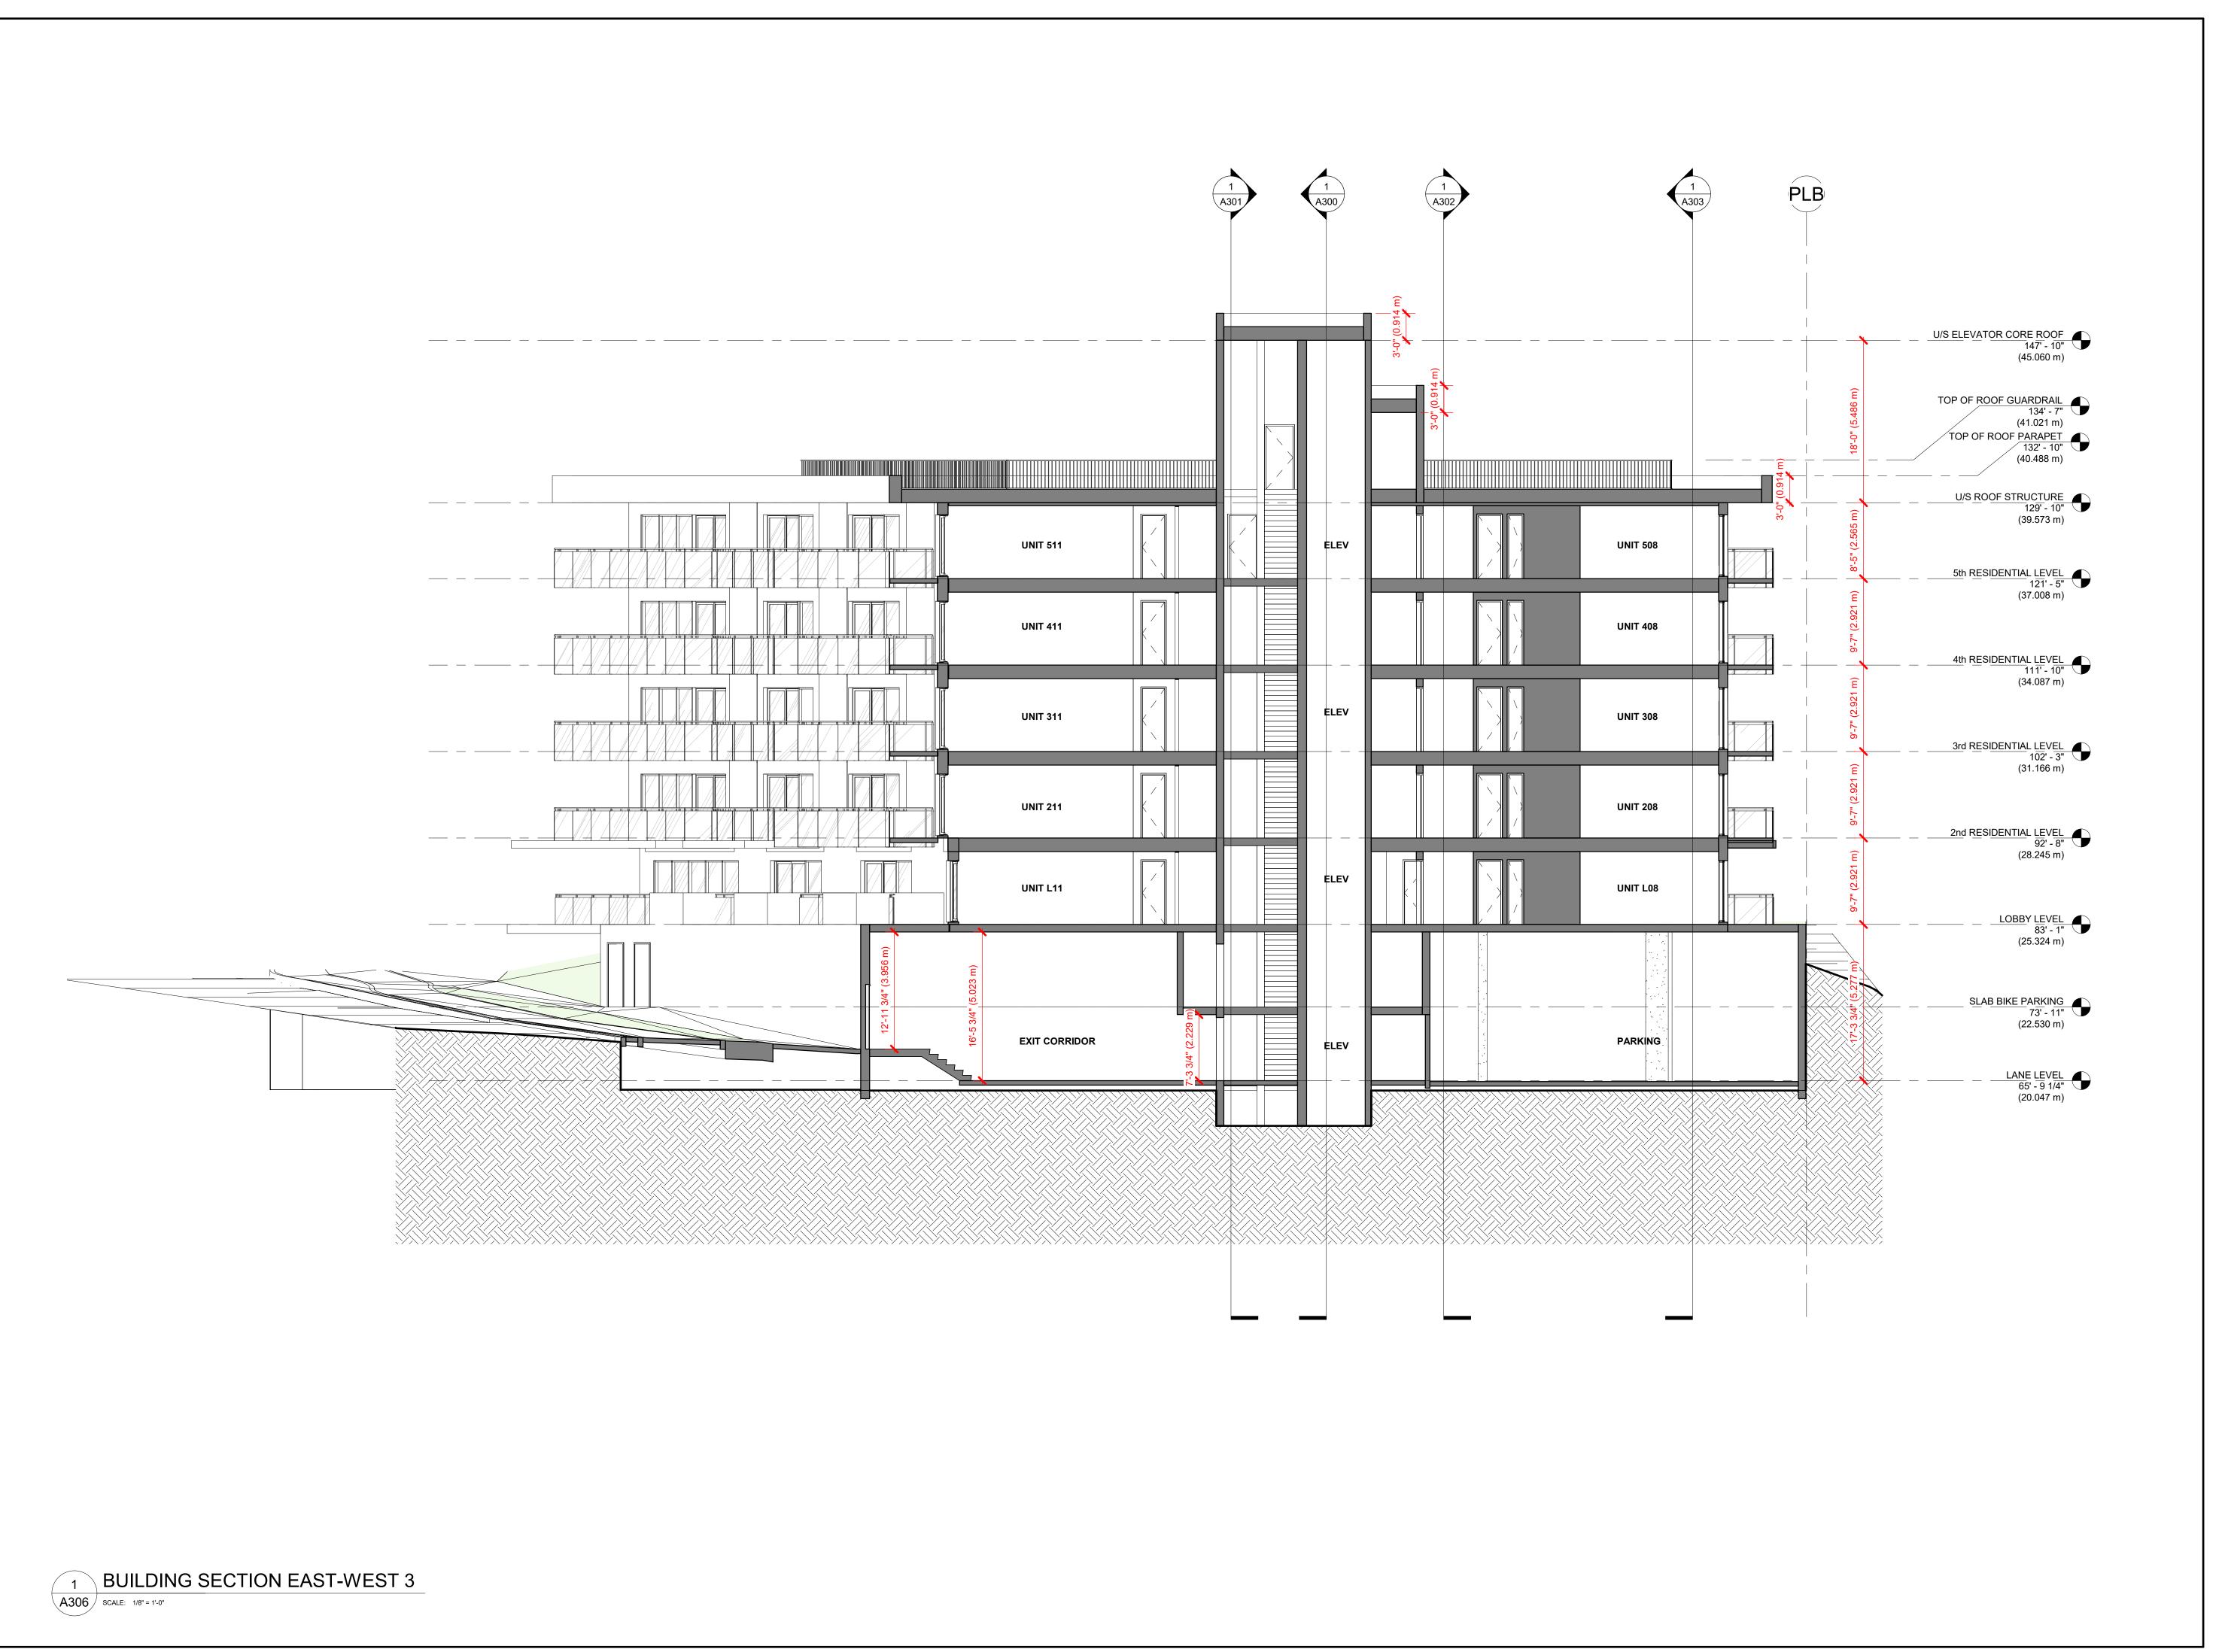

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351 3RD STREET WEST

351 WEST 3RD STREET
NORTH VANCOUVER, BC

V7M 1G3

JIM PATTISON DEVELOPMENTS

SHEET TITLE:

EAST-WEST BUILDING SECTIONS

PLOT DATE:

MARCH 23, 2022

SCALE:

1/8" = 1'-0"

DRAWING NO.

A306

City of North Vancouver Zoning Bylaw, 1995, No. 6700 Amendment Bylaw No. 2005, No. 7721 - Figure 5 - 1

	LEVEL ONE	LEVEL TWO	LEVEL THREE
BUILDING ACCESS	Outside stairs – maximum degree of colour contrast on nosing of each stair	Outside stairs – maximum degree of colour contrast on nosing of each stair	Outside stairs – maximum degree of colour contrast on nosing of each stair
BUILDING ACCESS	Curb cuts have tactile and visual cues	Curb cuts have tactile and visual cues	Curb cuts have tactile and visual cues
BUILDING ACCESS	Unobstructed access to main building entrances from street/sidewalks	Unobstructed access to main building entrances from street/sidewalks	Unobstructed access to main building entrances from street/sidewalks
BUILDING ACCESS		Unobstructed internal access: - from parking levels containing accessible parking (5' or 1520mm corridors; 2' or 610mm clear wall space adjacent to door latch) * - garbage and recycling receptacles and storage lockers - no stairs within building circulation including corridors on residential levels - accessible storage lockers for each unit	Unobstructed internal access: from parking levels containing accessible parking (5' or 1520mm corridors; 2' or 610mm clear wall space adjacent to doo latch) * garbage and recycling receptacles and storage lockers no stairs within building circulation including corridors on residential levels accessible storage lockers for each Leve 3 unit
BUILDING ACCESS	Canopy over main building entrances (3' or 915mm) and enterphone	Canopy over main building entrances (3' or 915mm) and enterphone	Canopy over main building entrances (3' or 915mm and enterphone
BUILDING ACCESS		Provide automatic door opener for at least one building entry door at ground level as well as doors leading into the building on each underground parkade level where disability parking is provided	Provide automatic door opener for at least on building entry door at ground level as well as doors leading into the building on each underground parkade level where disability parking is provided
BUILDING ACCESS	Disability Parking provided in accordance with Zoning bylaw Figure 9-4 as attached	Disability Parking provided in accordance with Zoning bylaw Figure 9-4 as attached.	Disability Parking provided in accordance with Zoning bylaw Figure 9-4 as attached
BUILDING ACCESS		3' or 915mm building and suite entry doors	3' or 915mm building and suite entry doors
BUILDING ACCESS	Flush thresholds throughout the building (maximum ½" or 13mm height)	Flush thresholds throughout the building (maximum ½" or 13mm height)	Flush thresholds throughout the building (maximum ½" or 13mm height)
BUILDING ACCESS	Accessible building enterphone, call buttons and, where provided, suite door bells *	Accessible building enterphone, call buttons and, where provided, suite door bells *	Accessible building enterphone, call buttons and, where provided, suite door bells *

* Illustrations available
** Options considered - 1 of 3
Design Elements
July 2005

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COMMON AREAS		Accessible mailboxes for all AD Level 2 units, and	Accessible mailboxes for all AD Level 3 units,
COMMICH PARENCE		5' or 1520mm turning radius in front *	and 5' or 1520mm turning radius in front *
CIRCULATION	Corridors minimum 4' or 1220mm wide (except	Corridors minimum 4' or 1220mm wide (except for	Corridors minimum 4' or 1220mm wide (except
	for service access areas) *	service access areas) *	for service access areas) *
		Provide 5' or 1520mm turning radius inside and	Provide 5' or 1520mm turning radius inside
CIRCULATION		outside the entry corridor of each dwelling unit *	and outside the entry corridor of each dwelling
			unit *
SUITE CIRCULATION		Provide wiring for an automatic door opener for	Provide wiring for an automatic door opener
		the suite entry door	for the suite entry door
		Provide 2' or 610mm clear wall space adjacent to	Provide wiring for an automatic door opener
		door latches where door swings toward user	for the suite entry door. Provide 2' or 610mm
SUITE CIRCULATION		(pocket doors acceptable for bathrooms and	clear wall space adjacent to door latches
		bedrooms)*	where door swings toward user (pocket doors
		Mileter and the Manager and Indianae and the desired	acceptable for bathrooms and bedrooms)*
00000		Minimum one bathroom, minimum one bedroom	Minimum one bathroom, minimum one
DOORS		and storage room doors 2'-10" or 860mm clear	bedroom and storage room doors 2'-10" or
		opening*	860mm clear opening
PATIOS & BALCONIES		Minimum one door 2' - 10" or 860mm clear door	Minimum one door 2 - 10" or 860mm clear
		opening	door opening
PATIOS & BALCONIES		Minimum one patio or balcony doorsill with	Minimum one patio or balcony doorsill with
		maximum ½" or 13mm threshold**	maximum ½" or 13mm threshold **
PATIOS & BALCONIES		Minimum 5' or 1520mm turning radius on patio /	Minimum 5' or 1520mm turning radius on patio
		balcony	/ balcony
MINDOMO		Opening mechanism maximum 46" or 1168mm	Opening mechanism maximum 46" or
WINDOWS		above floor (provide notation on window schedule)	1168mm above floor (provide notation on window schedule)
		Descride minimum 6 01 on 1000-ray beginnedel	,
		Provide minimum 6-0' or 1800mm horizontal windows in living room, dining room and minimum	Provide minimum 6-0' or 1800mm horizontal windows in living room, dining room and
WINDOWS		one bedroom where sills are not more than 2'- 6"	minimum one bedroom where sills are not
		or 750mm above the floor	more than 2'- 6" or 750mm above the floor
KITCHEN		Continuous counter between sink and stove*	Continuous counter between sink and stove*
KITCHEN		Continuous counter between sink and stove	Sink cabinet minimum 2'8" or 810mm wide
KIICHEN			
KITCHEN			Provide sufficient space for future installation
			of cooktop and wall oven Provide for potential 2'8" or 810mm wide
KITCHEN			
			undercounter workspace
KITCHEN			Lower edge of upper cupboards 4'6" or
			1350mm above floor

* Illustrations available
** Options considered - 2 of 3
Design Elements
July 2005

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KITCHEN		Minimum 4' or 1220mm floor space between base cabinets / walls (possible with removal o sink cabinet) *
MIN. ONE BATHROOM	Toilet located adjacent to wall (min 3' or 915mm length) *	Toilet located adjacent to wall (min 4'6" or 1370mm length) *
MIN. ONE BATHROOM	Provide turning radius within bathroom (may result from removal of vanity cabinet)*	Provide turning radius within bathroom (may result from removal of vanity cabinet)*
MIN. ONE BATHROOM	3' or 915mm clearance along full length of tub *	3' or 915mm clearance along full length of tub *
MIN. ONE BATHROOM	Tub control valve placed at outer edge of tub, with tub spout remaining in central position *	Tub control valve placed at outer edge of tub, with tub spout remaining in central position *
MIN. ONE BATHROOM	Accessible storage *	Accessible storage*
MIN. ONE BATHROOM		Provide pocket door or door swing out *
MIN. ONE BATHROOM		Space under sink minimum 2'8" or 810mm wide *
MIN. ONE BATHROOM		Provide for the possible future installation of a accessible shower stall, sized at least 3'-0" x 5'-0" or 910mm x 1500mm - refer to the 1998 BC Building Access Handbook for details
MIN. ONE BEDROOM		Sufficient manoeuvring room between closet and double bed *
MIN. ONE BEDROOM		Provide 3' or 915mm access to window opening *
LAUNDRY FACILITIES		Provide front loading side-by-side washer / dryer in-suite or in common area
LAUNDRY FACILITIES		4' or 1220mm manoeuvring space in front of washer / dryer

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* Illustrations available
** Options considered - 3 of 3
Design Elements
July 2005

ADAPTABLE DESIGN GUIDELINES

FIXTURES AND FINISHES

	LEVEL ONE	LEVEL TWO	LEVEL THREE
BASIC	Easy to read building address numbers (min. 4" or 100mm high in contrasting colours)	Easy to read building address numbers (min. 4" or 100mm high in contrasting colours)	Easy to read building address numbers (min. 4" or 100mm high in contrasting colours)
BASIC	Lighting levels to a minimum of 100 lux outside and inside main building entries and suite entries	Lighting levels to a minimum of 100 lux outside and inside main building entries and suite entries	Lighting levels to a minimum of 100 lux outside and inside main building entries and suite entries
BASIC	No polished finish on building entry flooring (provide flooring samples)	No polished finish on building entry flooring (provide flooring samples)	No polished finish on building entry flooring (provide flooring samples)
BASIC	Except for pocket doors, sliding doors, or doors equipped with openers, lever door handles are required on all doors (provide notation on door schedule)	Except for pocket doors, sliding doors, or doors equipped with openers, lever door handles are required on all doors (provide notation on door schedule)	Except for pocket doors, sliding doors, or doors equipped with openers, lever door handles are required on all doors (provide notation on door schedule)
BASIC	Signage throughout common areas has well contrasted colours	Signage throughout common areas has well contrasted colours	Signage throughout common areas has well contrasted colours
BASIC	Elevators have well contrasted control buttons	Elevators have well contrasted control buttons	Elevators have well contrasted control buttons
CIRCULATION		Slip resistant flooring	Slip resistant flooring
CIRCULATION		Colour contrasting exit doors	Colour contrasting exit doors
BUILDING MEETING / AMENITY ROOMS		Provide carpet and drapes to absorb sound and decrease echoes	Provide carpet and drapes to absorb sound and decrease echoes
UNIT ENTRIES		Adjustable door closers to reduce force to open door to maximum 22N or 5 lbs.	Adjustable door closers to reduce force to open door to maximum 22N or 5 lbs.
UNIT ENTRIES		Door handle at 40" or 1000mm above the floor, with deadbolts placed immediately above or below	Door handle at 40" or 1000mm above the floor, with deadbolts placed immediately above or below
UNIT ENTRIES			Two door viewers: 3'5" or 1050mm and 5' or 1520mm
UNIT FLOORING		Non-slip flooring in kitchen and minimum one bathroom (provide flooring samples)	Non-slip flooring in kitchen and minimum one bathroom (provide flooring samples)
UNIT FLOORING		High density, low level loop carpet and underlay maximum ½" or 13mm height	High density, low level loop carpet and underlay maximum ½" or 13mm height
PATIOS AND BALCONIES		Outdoor light fixture provided	Outdoor light fixture provided
PATIOS AND BALCONIES		Electrical outlet provided	Electrical outlet provided

* Illustrations available

Fixtures & Finishes
- 1 of 3

July 2005

	LEVEL ONE	LEVEL TWO	LEVEL THREE 7 of 11
ELECTRICAL		Switches, controls, thermostats and the highest breaker in the suite panel, to be installed no higher than 46" or 1170mm above finished floor	Switches, controls, thermostats and the highest breaker in the suite panel, to be installed no higher than 46" or 1170mm above finished floor
ELECTRICAL		Electrical outlets, cable outlets, telephone jacks not lower than 18" or 450mm above floor	Electrical outlets, cable outlets, telephone jacks not lower than 18" or 450mm above floor
ELECTRICAL	Within suites a duplex outlet is required within 8" or 200mm of a telephone jack	Within suites a duplex outlet is required within 8" or 200mm of a telephone jack	Within suites a duplex outlet is required within 8" or 200mm of a telephone jack
ELECTRICAL	Wiring for visual alarm system in living room and minimum one bedroom, connected to fire alarm system	Wiring for visual alarm system in living room and minimum one bedroom, connected to fire alarm system	and minimum one bedroom, connected to fire
ELECTRICAL		Rocker switches	Rocker switches
ELECTRICAL			Double bulb ceiling fixtures
ELECTRICAL			Provide wiring for automatic door opener and strike at unit entry
WINDOWS		Easily grasped and operated mechanism for opening and locking windows	Easily grasped and operated mechanism for opening and locking windows
KITCHEN		Task lighting of at least 100 lux level at sink, stove and work areas in addition to general overhead lighting	Task lighting of at least 100 lux level at sink, stove and work areas in addition to general overhead lighting
KITCHEN		Pull-out work boards at 2'8" or 810mm height *	Pull-out work boards at 2'8" or 810mm height *
KITCHEN		Lever handle faucets and cabinet handles which can be easily used with an open hand eg. "D" or "J" cabinet handles	Lever handle faucets and cabinet handles which can be easily used with an open hand eg. "D" or "J" cabinet handles
KITCHEN		Adjustable shelves in all cabinets	Adjustable shelves in all cabinets
KITCHEN			Drawer storage in key areas*
KITCHEN			Provision for removal of sink cabinet and lowering of counter height
KITCHEN			Provision in water supply and drain to allow for a 4" (100mm) drop in sink height (offset plumbing)
KITCHEN			Provision for the future installation of at least one counter receptacle in front of cabinets
KITCHEN			Where regular refrigerator installed initially, provide adequate space for side by side model
KITCHEN			Contrasting knobs on stove / cook top

* Illustrations available

LEVEL ONE

LEVEL TWO

LEVEL THREE

Solid blocking provided in walls of tub / shower and toilet areas, and behind towel bars *

MIN. ONE BATHROOM

Pressure balanced tub / shower valves

Pressure balanced tub / shower valves

Provision in water supply and drain to allow for a 4" (100mm) drop in vanity height (offset)

LEVEL THREE

Solid blocking provided in walls of tub / shower and toilet areas, and behind towel bars *

Pressure balanced tub / shower valves

Provision in water supply and drain to allow for a 4" (100mm) drop in vanity height (offset)

A of 11

LEVEL THREE

Solid blocking provided in walls of tub / shower and toilet areas, and behind towel bars *

Pressure balanced tub / shower valves

Provision in water supply and drain to allow for a 4" (100mm) drop in vanity height (offset)

Provision in water supply and drain to allow for MIN. ONE BATHROOM a 4" (100mm) drop in vanity height (offset a 4" (100mm) drop in vanity height (offset Provision for vanity sink removal Provision for vanity sink removal MIN. ONE BATHROOM Adjustable height shower head or hand-held Adjustable height shower head or hand-held MIN. ONE BATHROOM shower head on adjustable bracket* shower head on adjustable bracket * Water temperature regulator on tub / shower MIN. ONE BATHROOM LIVING ROOM One switched electrical outlet One switched electrical outlet Three-way switched outlet at bed area and Three-way switched outlet at bed area and BEDROOMS BEDROOMS Provide light fixture in or adjacent to closet Provide light fixture in or adjacent to closet

Telephone jack

Provide light and electrical outlet

Telephone jack

Provide light and electrical outlet

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Telephone jack

BEDROOMS

IN-SUITE STORAGE

* Illustrations available

- 3 of 3 Fixtures & Finishes
July 2005

6 of 11

ARCHITECTURE + INTERIOR DESIGN
SUITE 300 - 7 EAST 6TH AVE
VANCOUVER BRITISH COLUMBIA CANADA
604 484 8285 info@mgba.com www.mgba.com



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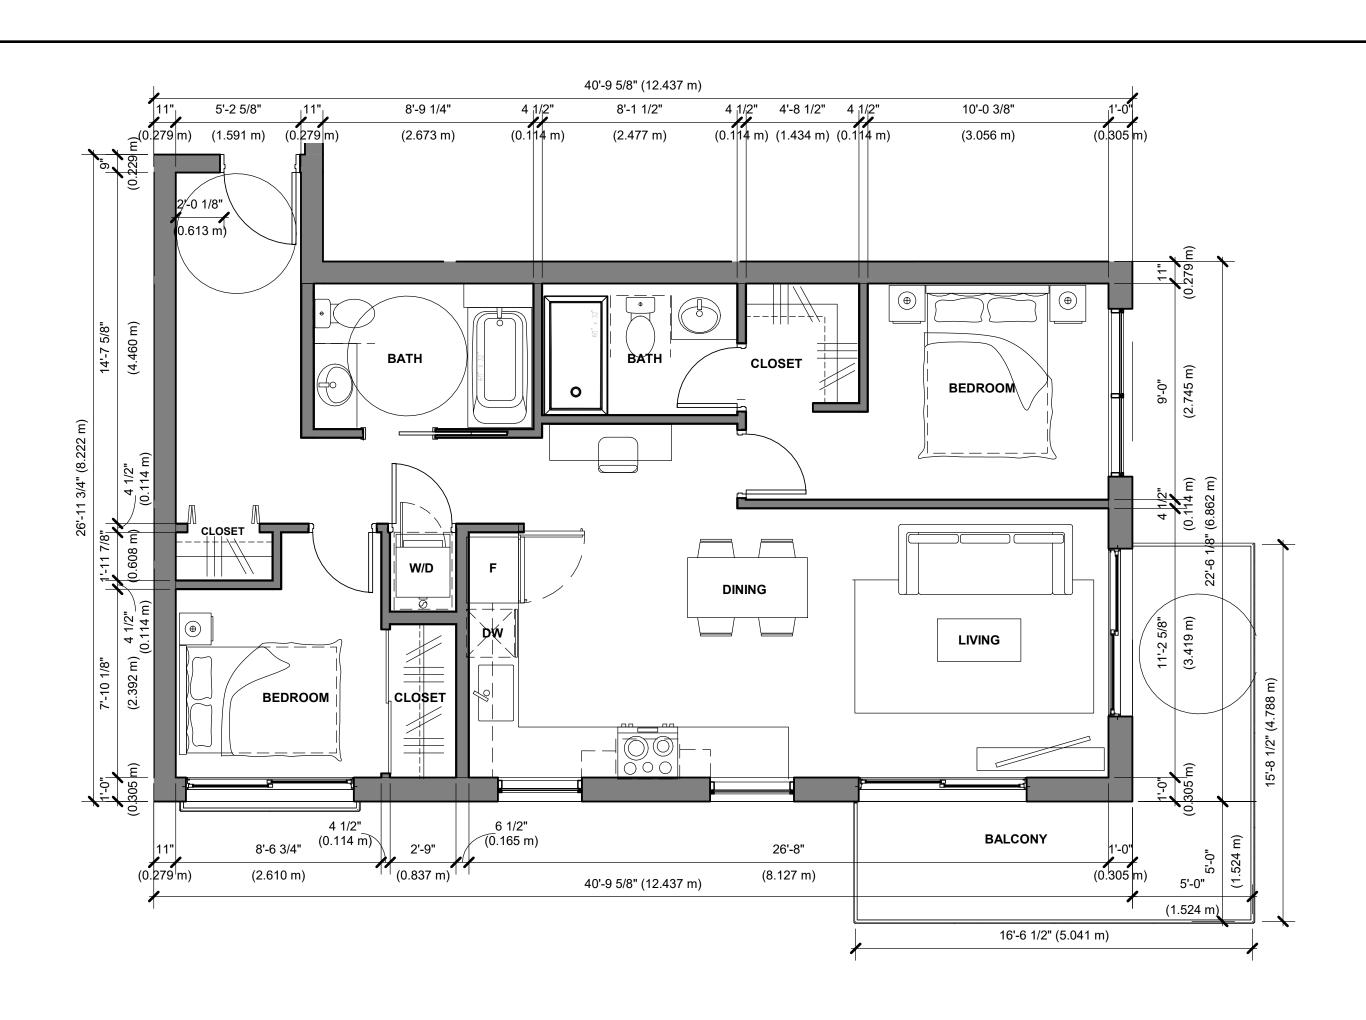
JIM PATTISON DEVELOPMENTS
351 3RD STREET WEST

351 WEST 3RD STREET NORTH VANCOUVER, BC V7M 1G3

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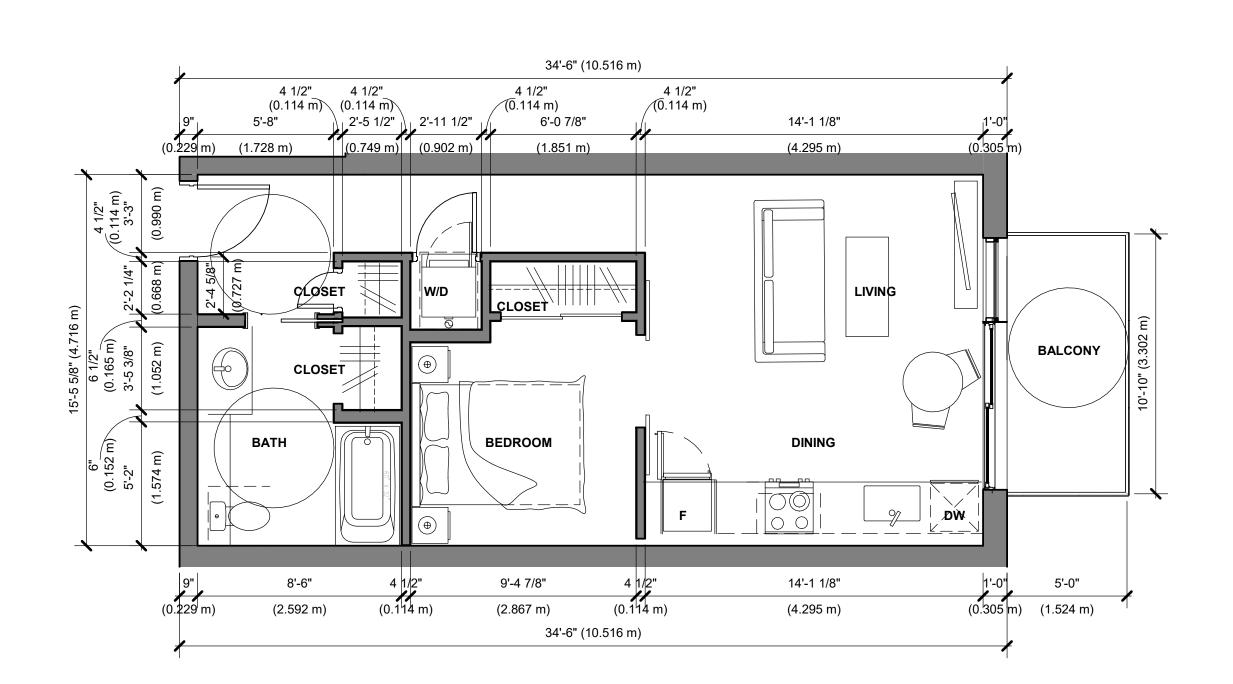
ADAPTABLE UNIT GUIDELINES

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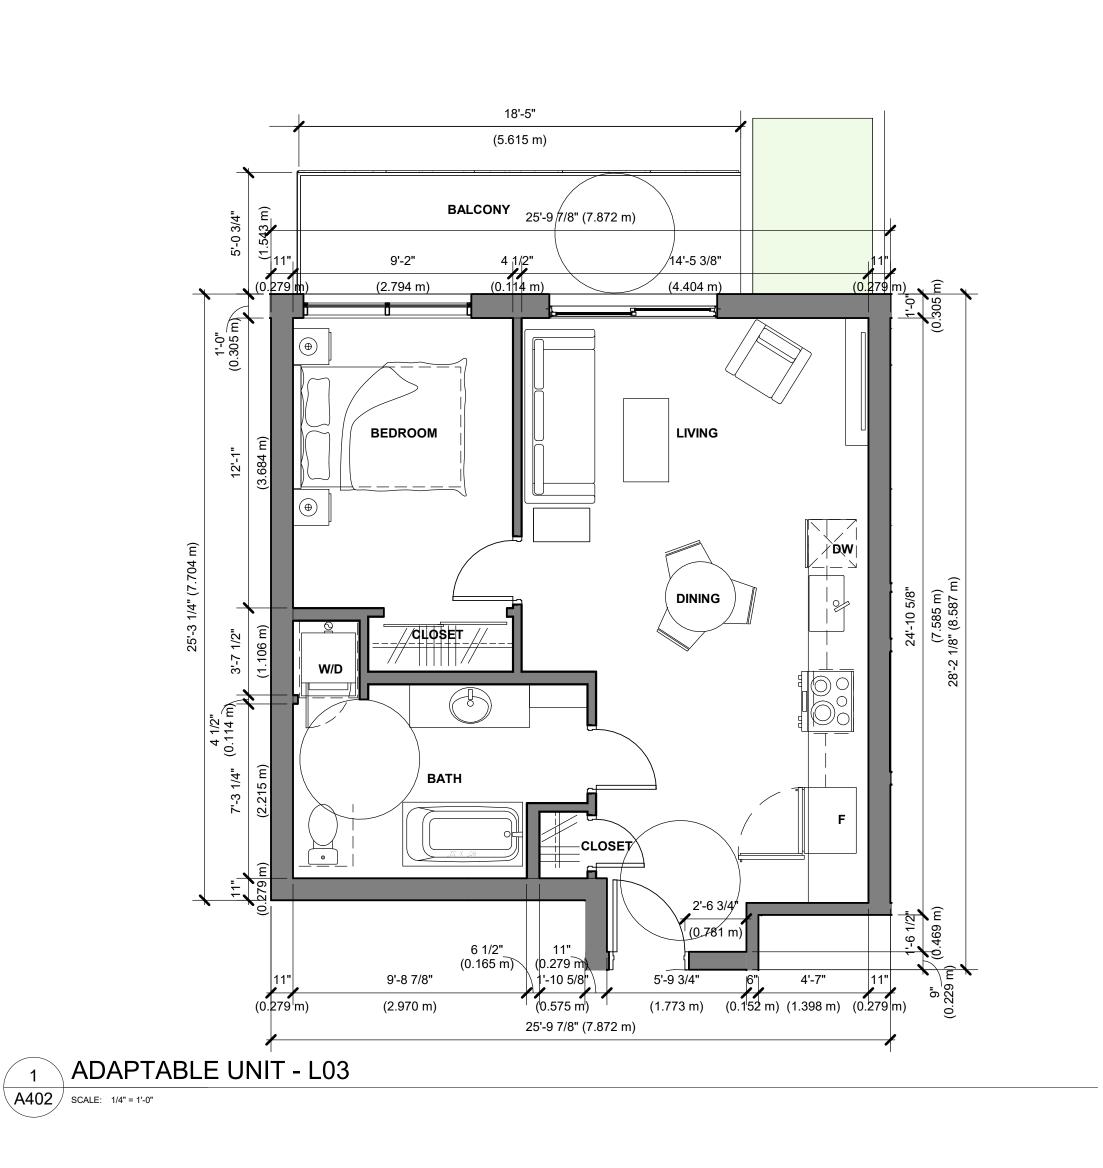



3 ADAPTABLE UNIT - L09, 209-509

A402 SCALE: 1/4" = 1'-0"







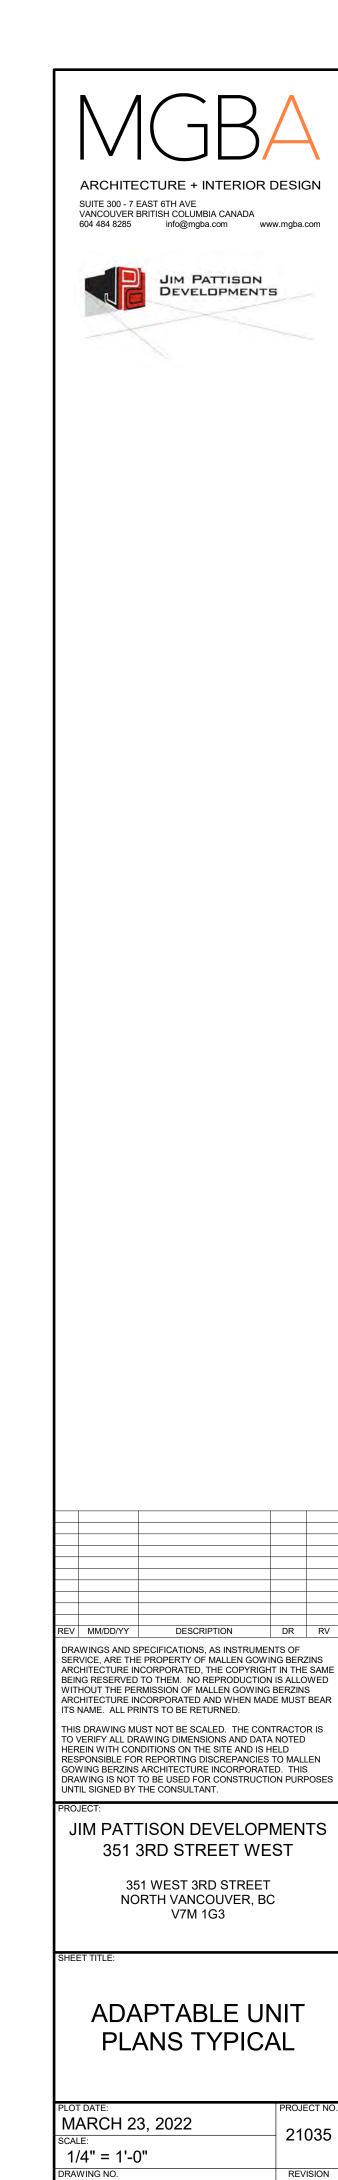


A402

AREAS INCLUDED IN FSR CALCULATION

COLOUR FILL	AREA TYPE
	RESIDENTIAL ELEVATOR & STAIRS
	RESIDENTIAL UNIT


AREAS EXCLUDED IN FSR CALCULATION


COLOUR FILL	AREA TYPE
	AMENITY
	ADAPTABLE UNIT
	COMMON STORAGE/ BICYCLE PARKING
	SERVICE ROOM
	UNIT BALCONY & OPEN DECK

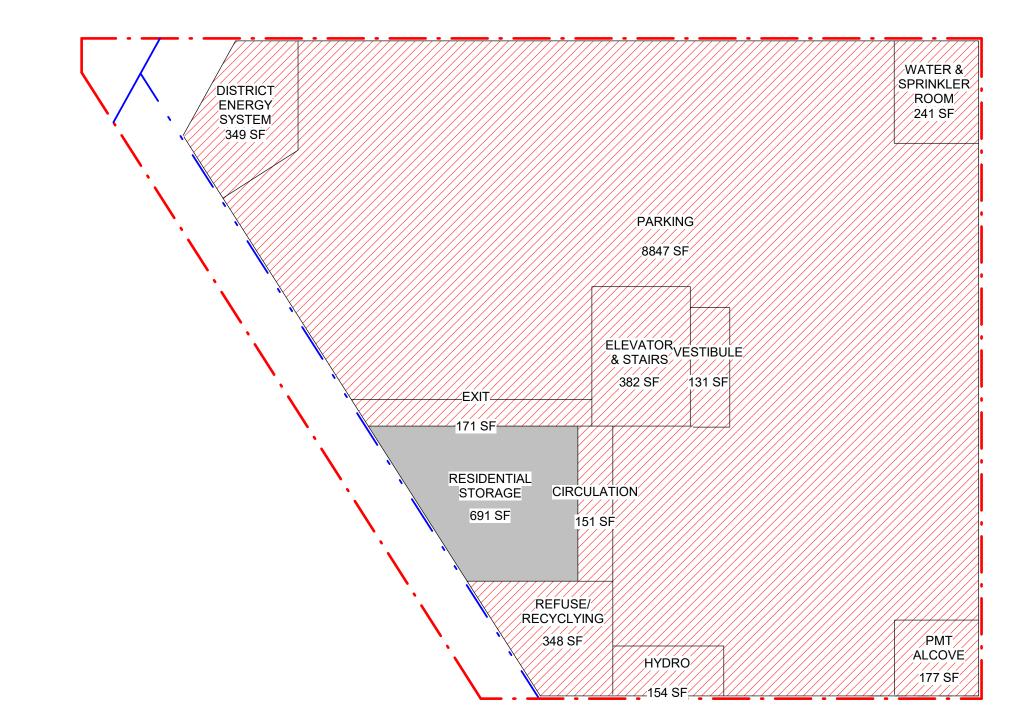

3 LANE LEVEL - FSR OVERLAY
A701 SCALE: 1/16" = 1'-0"

\A701

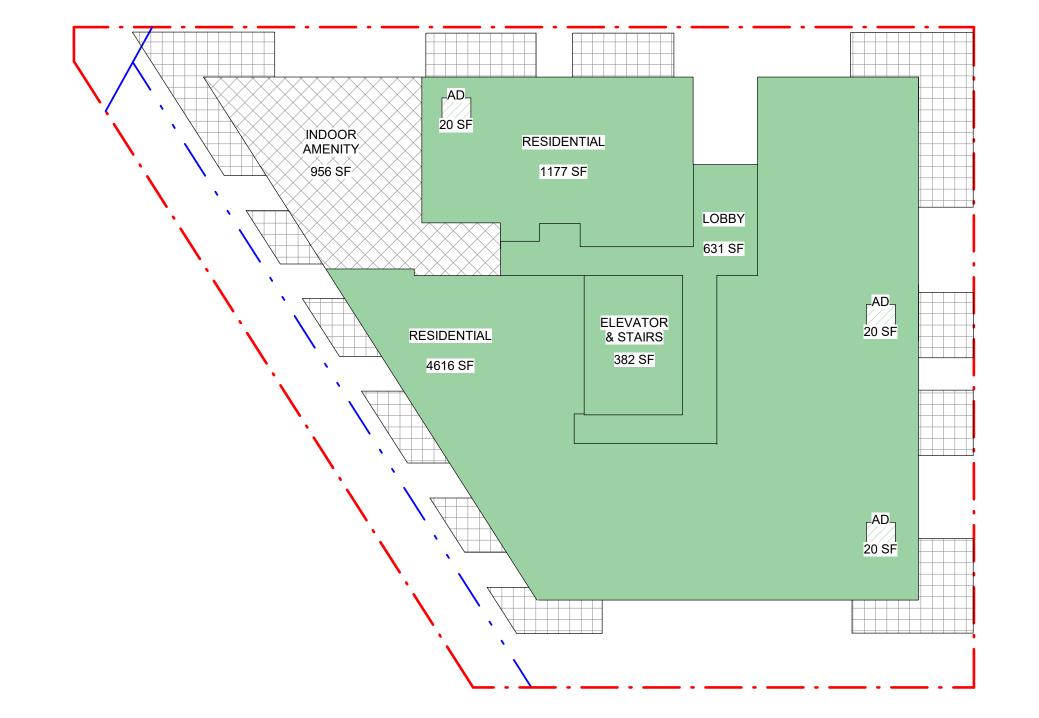

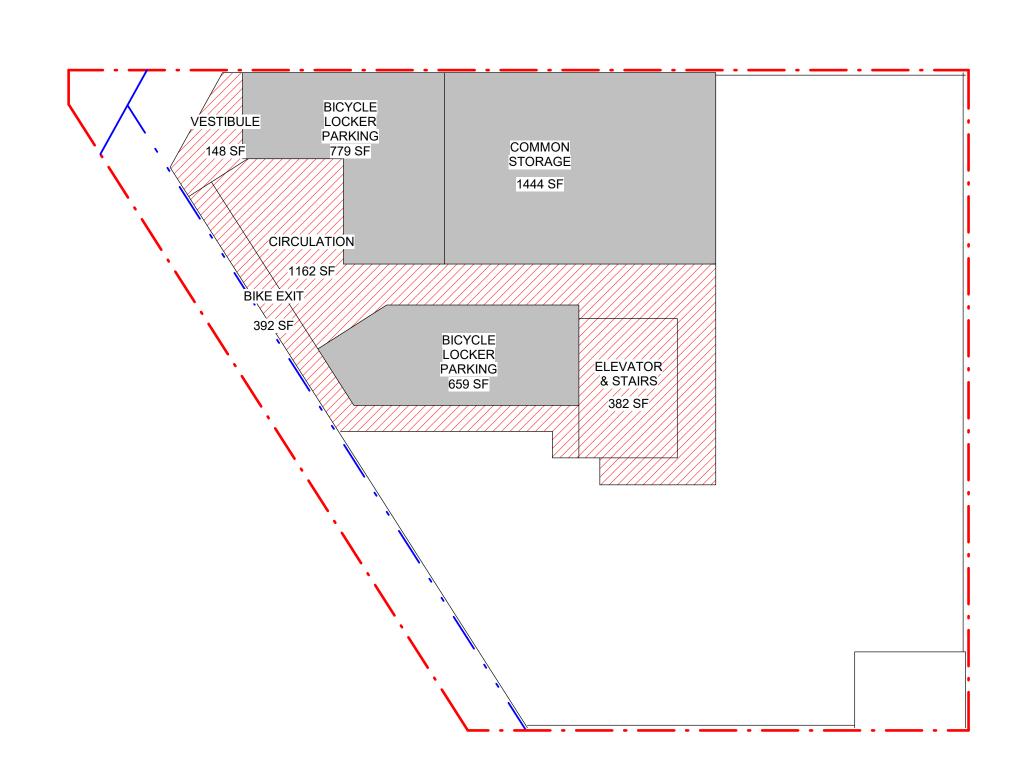

2 MAIN FLOOR LEVEL - FSR OVERLAY
A701 SCALE: 1/16" = 1'-0"

1 BIKE PARKING - FSR OVERLAY
A701 SCALE: 1/16" = 1'-0"

ARCHITECTURE + INTERIOR DESIGN
SUITE 300 - 7 EAST 6TH AVE
VANCOUVER BRITISH COLUMBIA CANADA
604 484 8285 info@mgba.com www.mgba.com

JIM PATTISON
DEVELOPMENTS

REV	MM/DD/YY	DESCRIPTION	DR	RV
SER ARC BEIN WIT ARC	EVICE, ARE THE CHITECTURE IN NG RESERVED HOUT THE PER CHITECTURE IN	PECIFICATIONS, AS INSTRUMEI E PROPERTY OF MALLEN GOW! ICORPORATED, THE COPYRIGH TO THEM. NO REPRODUCTION RMISSION OF MALLEN GOWING ICORPORATED AND WHEN MAI INTS TO BE RETURNED.	ING BERZ IT IN THE N IS ALLO BERZINS	SAME WED
TO V HER RES GOV DRA	VERIFY ALL DR REIN WITH CON PONSIBLE FOI WING BERZINS WING IS NOT	JST NOT BE SCALED. THE CON AWING DIMENSIONS AND DATA IDITIONS ON THE SITE AND IS H R REPORTING DISCREPANCIES ARCHITECTURE INCORPORATI TO BE USED FOR CONSTRUCTI THE CONSULTANT.	A NOTED HELD TO MALI ED. THIS	EN


JIM PATTISON DEVELOPMENTS
351 3RD STREET WEST

351 WEST 3RD STREET NORTH VANCOUVER, BC V7M 1G3


SHEET TITL

FSR OVERLAY DIAGRAMS - BELOW GRADE, LANE, LOBBY

PROJECT NO.
21035
21000
REVISION

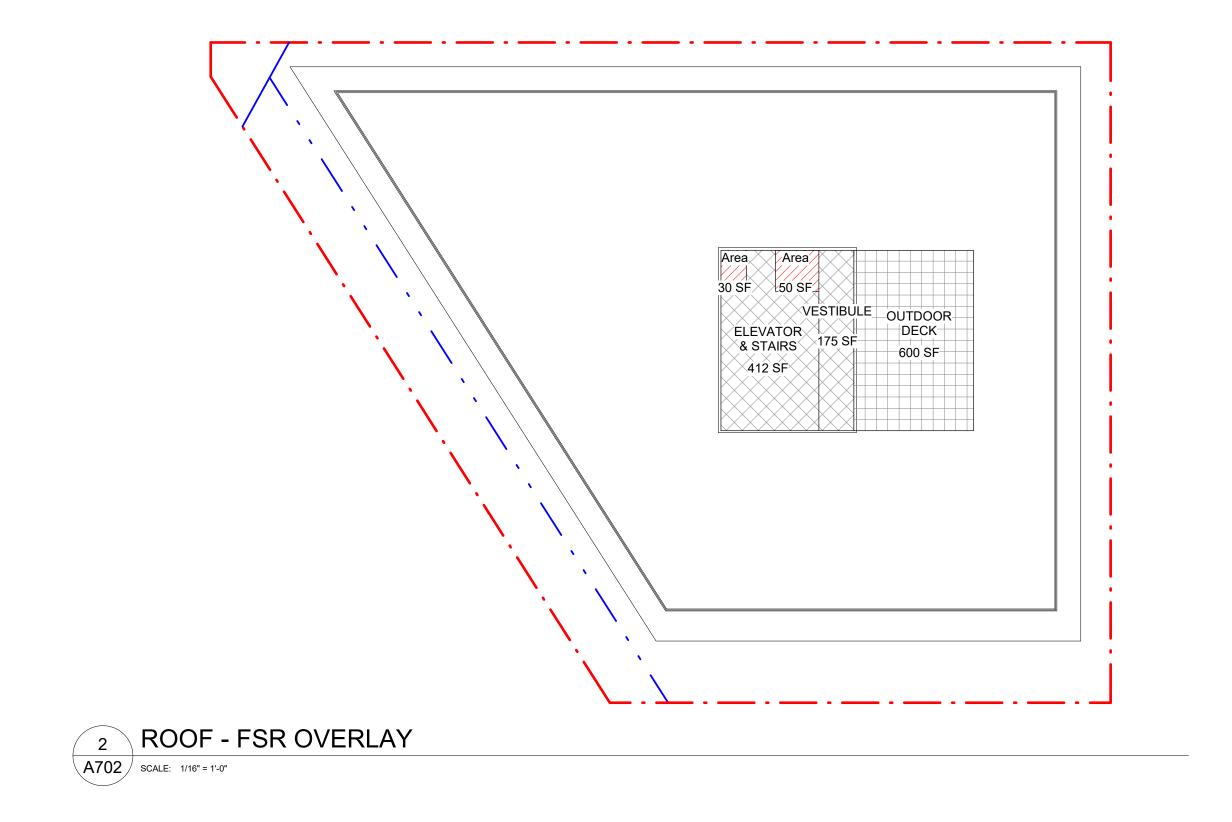


AREAS INCLUDED IN FSR CALCULATION

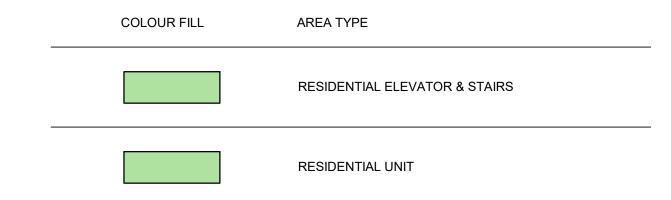

AREAS EXCLUDED IN FSR CALCULATION

COLOUR FILL	AREA TYPE
	AMENITY
	ADAPTABLE UNIT
	COMMON STORAGE/ BICYCLE PARKING
	SERVICE ROOM
	UNIT BALCONY & OPEN DECK

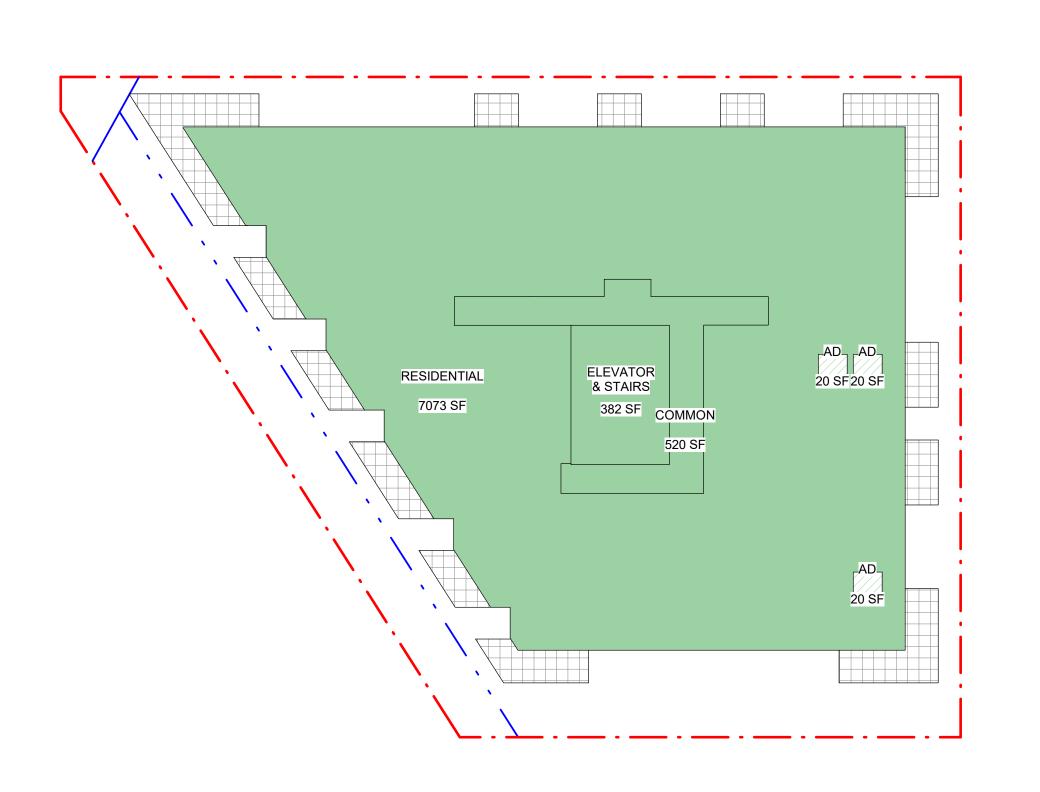

LEVEL 2-5 - FSR OVERLAY A702 SCALE: 1/16" = 1'-0"

ARCHITECTURE + INTERIOR DESIGN SUITE 300 - 7 EAST 6TH AVE VANCOUVER BRITISH COLUMBIA CANADA 604 484 8285 info@mgba.com www.mgba.com JIM PATTISON DEVELOPMENTS

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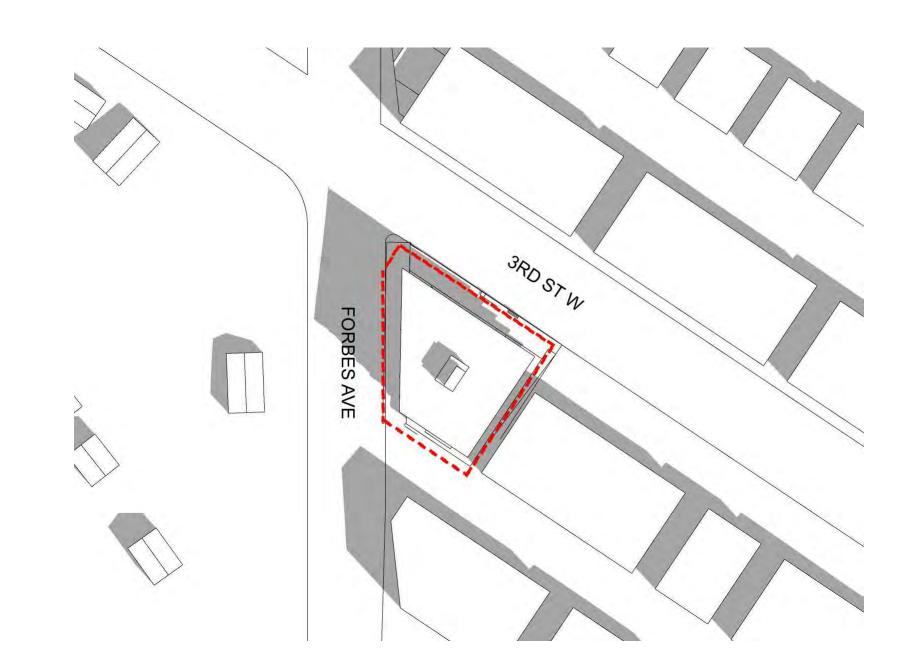
JIM PATTISON DEVELOPMENTS 351 3RD STREET WEST


> 351 WEST 3RD STREET NORTH VANCOUVER, BC V7M 1G3


FSR OVERLAY DIAGRAMS - 2, 3, 4, 5, ROOF

PLOT DATE:	PROJECT NO.	
MARCH 23, 2022	21035	
SCALE:	21033	
As indicated		
DRAWING NO.	REVISION	
A702		

SPRING EQUINOX MARCH 20



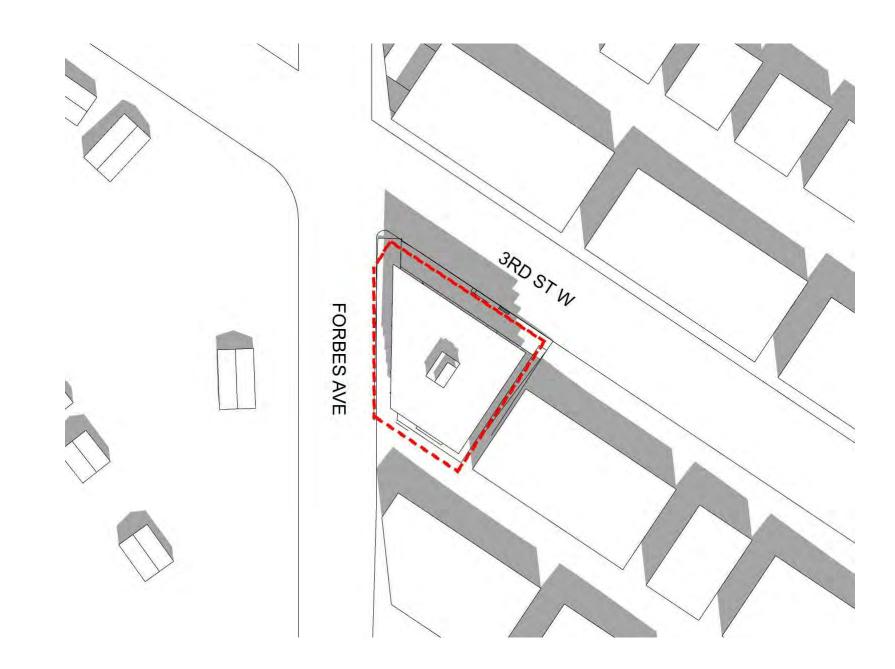

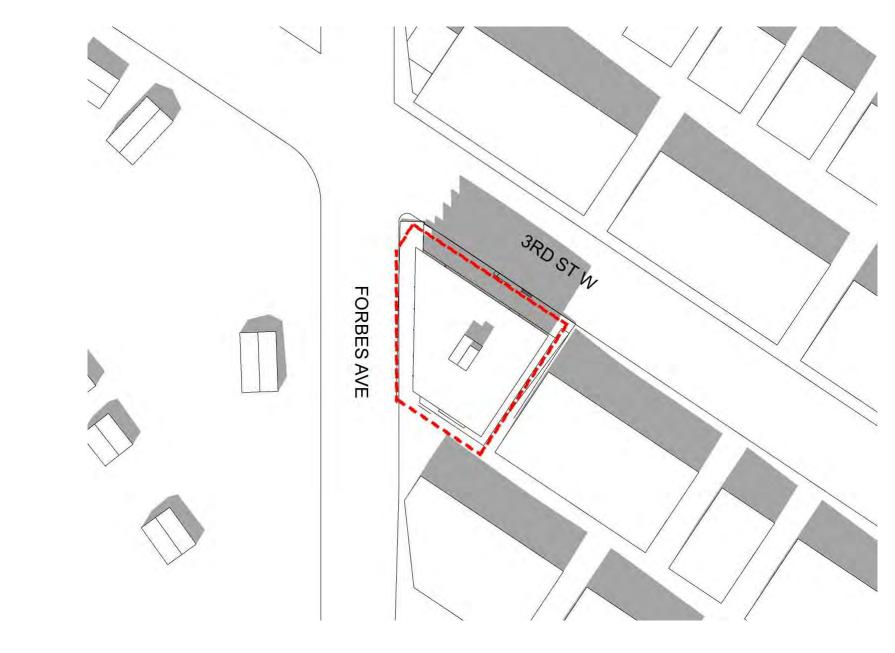

SHADOW STUDY - MARCH 12PM A801 SCALE: 3/8" = 1'-0"

SHADOW STUDY - MARCH 2PM

A801 SCALE: 3/8" = 1'-0"

SUMMER SOLSTICE JUNE 21

4 SHADOW STUDY - JUNE 10AM


A801 SCALE: 3/8" = 1'-0"

A801 SCALE: 3/8" = 1'-0"

SHADOW STUDY - MARCH 10AM





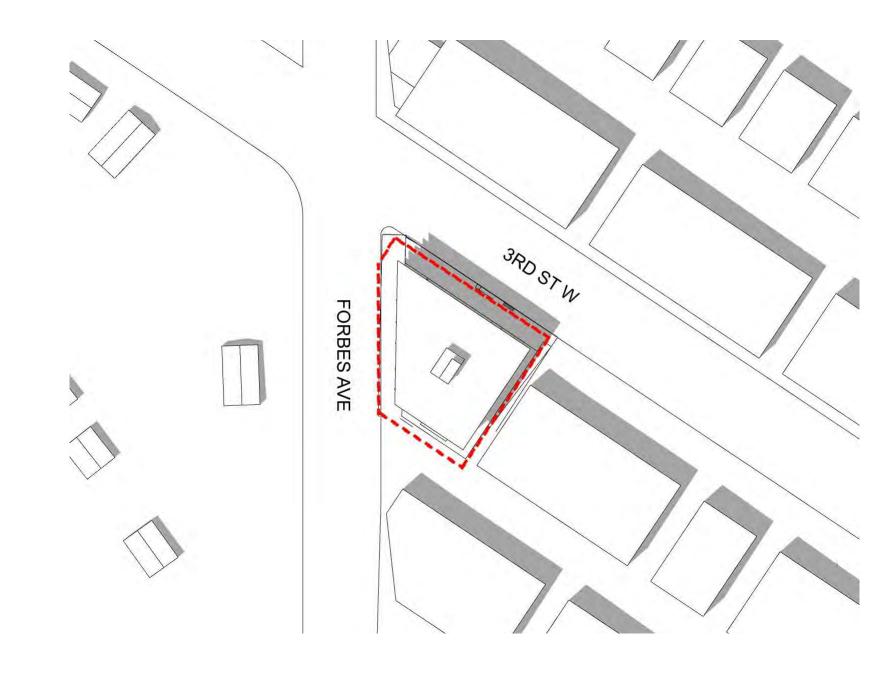

6 SHADOW STUDY - JUNE 2PM A801 SCALE: 3/8" = 1'-0"

A801 SCALE: 3/8" = 1'-0"

SHADOW STUDY -MARCH, JUNE

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JIM PATTISON DEVELOPMENTS 351 3RD STREET WEST


351 WEST 3RD STREET NORTH VANCOUVER, BC V7M 1G3


SUITE 300 - 7 EAST 6TH AVE VANCOUVER BRITISH COLUMBIA CANADA 604 484 8285 info@mgba.com www.mgba.com


JIM PATTISON DEVELOPMENTS

PLOT DATE: MARCH 23, 2022 21035 3/8" = 1'-0" REVISION A801


FALL EQUINOX SEPTEMBER 22

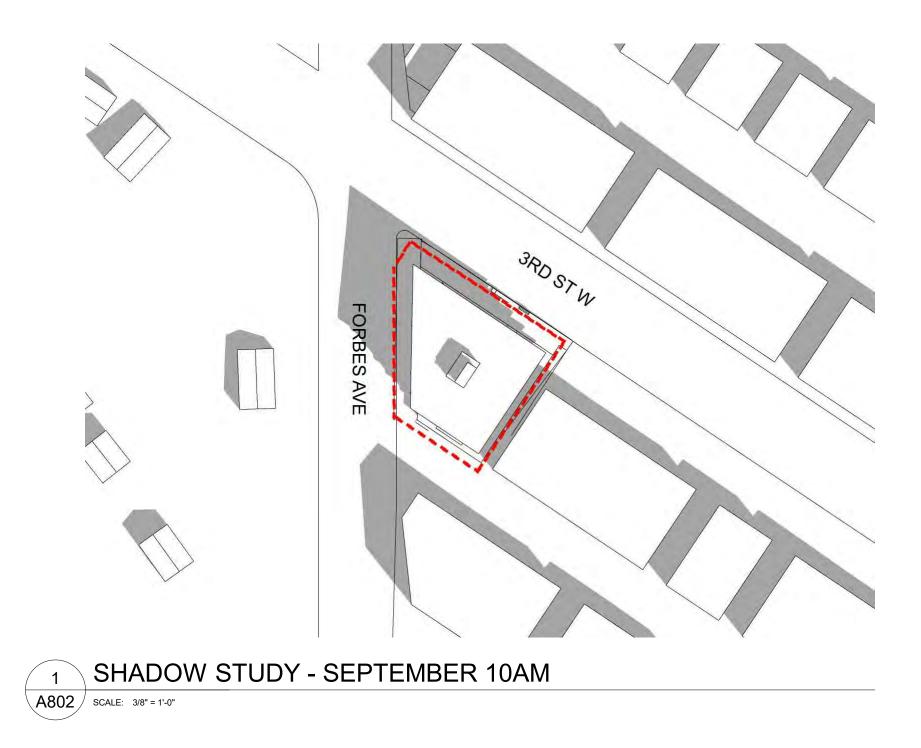

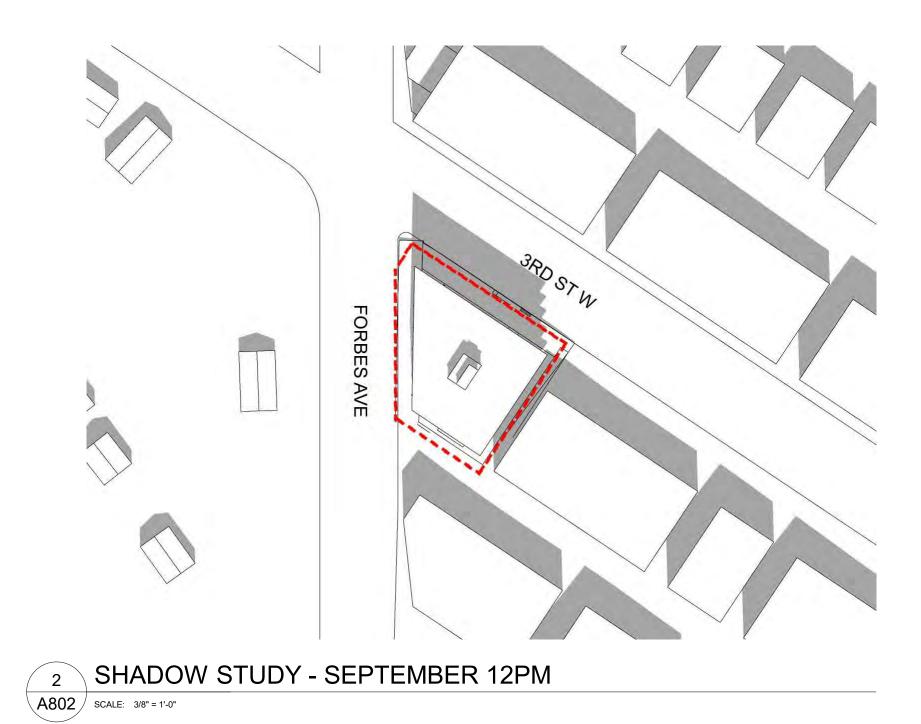


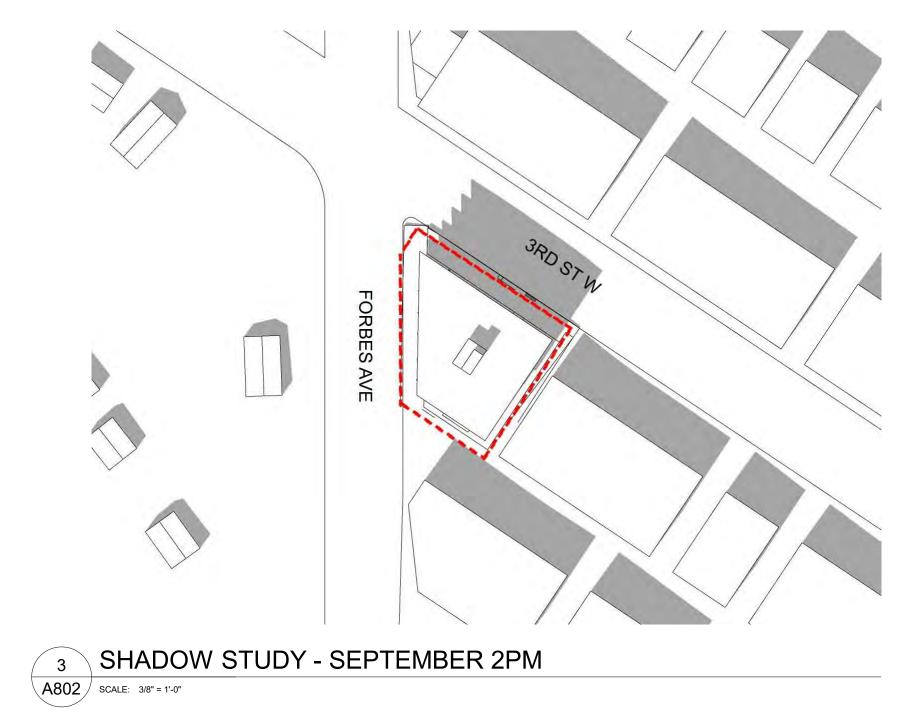

WINTER SOLSTICE DECEMBER 21

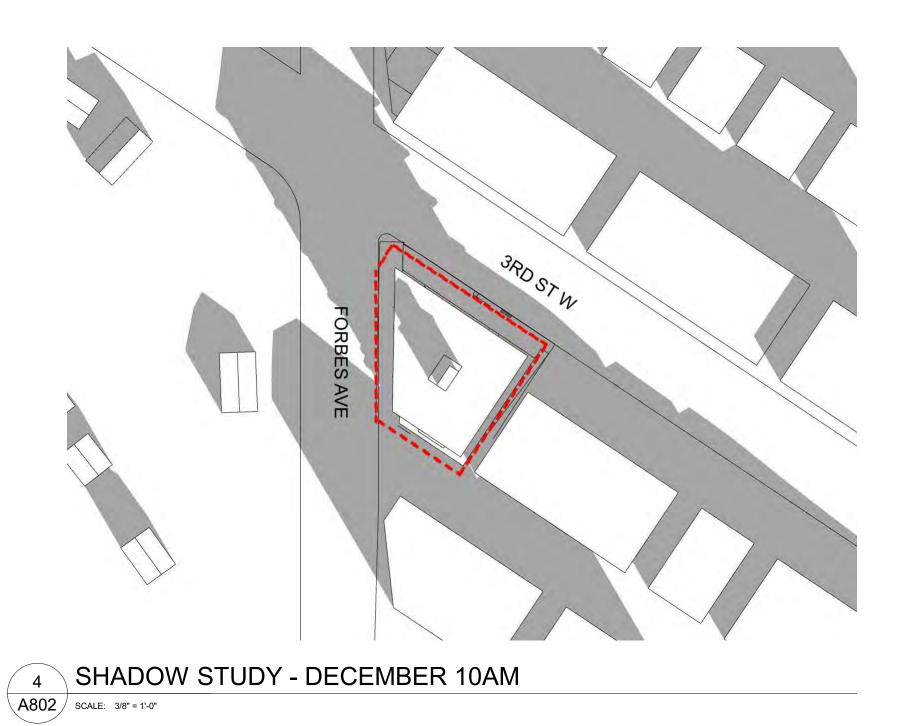



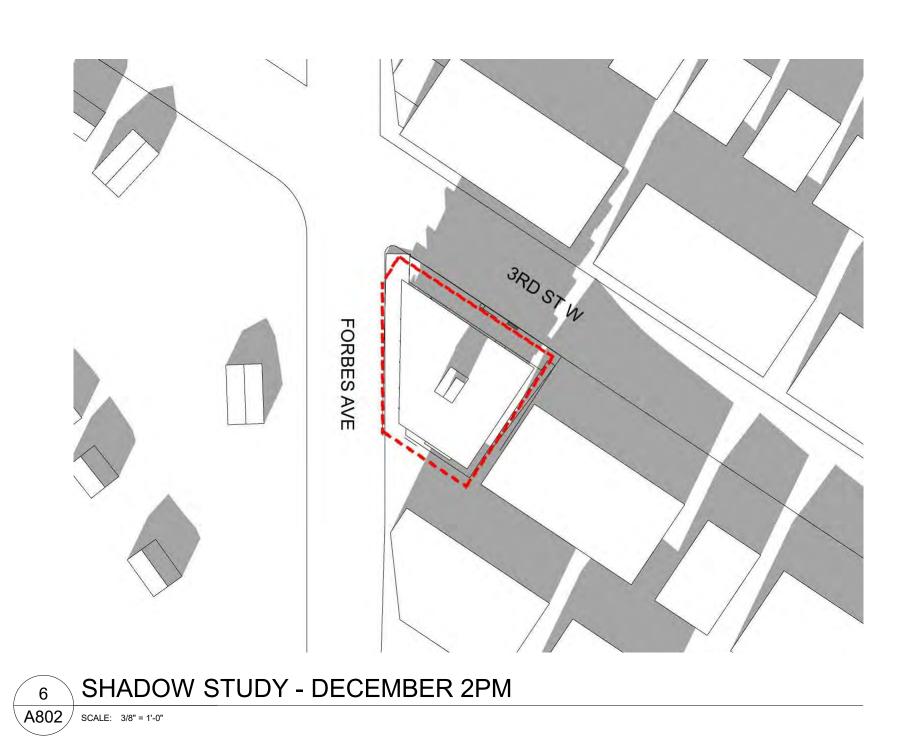

JIM PATTISON DEVELOPMENTS 351 WEST 3RD STREET NORTH VANCOUVER, BC V7M 1G3 DECEMBER

SUITE 300 - 7 EAST 6TH AVE VANCOUVER BRITISH COLUMBIA CANADA 604 484 8285 info@mgba.com www.mgba.com

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SHADOW STUDY -SEPTEMBER,

PLOT DATE:	PROJECT NO.
MARCH 23, 2022	21035
SCALE:	21033
3/8" = 1'-0"	
DRAWING NO.	REVISION
A802	