

			Consultants		<div>ARCHITECT:</div> <div><div>dlp</div><div>architecture</div><div>DLP ARCHITECTURE INC 202-460 NANAIMO ST VANCOUVER BC V5L 4W3 778-889-6849</div></div> <div>PRIMARY CONTACT:</div> <div>D. LUCIO PICCIANO 202-460 NANAIMO ST VANCOUVER BC V5L 4W3 778-889-6849</div> <div>PROJECT:</div> <div>HERITAGE REVITALIZATION and NEW LOW ENERGY DUPLEX</div> <div>PROJECT ADDRESS:</div> <div>311 West 14th Street. City of North Vancouver, BC</div> <div>OWNER:</div> <div>1352644 BC LTD</div> <div></div>																																																																																
			Architect																																																																																		
			<div>dlp Architecture inc. Lucio Picciano, Architect AIBC 202-460 Nanaimo Street Vancouver, BC V5L 4W3 (p) 778.889.68 (e) lucio@dlpdesigns.com</div>																																																																																		
			Civil Engineer																																																																																		
			<div>Creus Engineering Ltd. Fred Ciabrelli, P.Eng 610 - East Tower, 221 Esplanade West North Vancouver, BC V7M 3J3 (p) 604.987.9070 (e) fciambrelli@creus.ca</div>																																																																																		
			Landscape																																																																																		
			<div>M2 Landscape Architecture and Arboriculture Inc. Qing Li, BCSLA Intern 220 - 26 Lorne Mews New Westmister, BC V3M 3L7 (p) 604.553.0044 (e) qingli@m2la.com</div>																																																																																		
			Arborist																																																																																		
			<div>M2 Landscape Architecture and Arboriculture Inc. Xudong Bao, ISA 220 - 26 Lorne Mews New Westmister, BC V3M 3L7 (p) 604.553.0044 (ext. 107)</div>																																																																																		
			Passive House Designer		<div>dlp Architecture inc. Lucio Picciano, Architect AIBC 202-460 Nanaimo Street Vancouver, BC V5L 4W3 (p) 778.889.68 (e) lucio@dlpdesigns.com</div>		<div>ARCHITECT SEAL</div> <table><tr><td>-</td><td>-</td><td>-</td></tr><tr><td>-</td><td>-</td><td>-</td></tr><tr><td></td><td>-</td><td>-</td></tr><tr><td>No.</td><td>Date</td><td>Description</td></tr><tr><td colspan="3">REVISIONS</td></tr><tr><td></td><td>24-Sept-24</td><td>DP FOR COUNCIL</td></tr><tr><td></td><td>10-Jul-23</td><td>DP Prior-to 2</td></tr><tr><td>-</td><td>20-Mar-23</td><td>DP Prior-to</td></tr><tr><td>-</td><td>27-Feb-23</td><td>Consultants</td></tr><tr><td>B</td><td>24-Aug-22</td><td>Development Permit</td></tr><tr><td>-</td><td>19-May-22</td><td>Review</td></tr><tr><td>-</td><td>13-May-22</td><td>Consultants</td></tr><tr><td>-</td><td>05-May-22</td><td>Consultants</td></tr><tr><td>A</td><td>17-Dec-21</td><td>Rezoning Pre-App</td></tr><tr><td>No.</td><td>Date</td><td>Description</td></tr><tr><td colspan="3">ISSUE INFORMATION</td></tr><tr><td colspan="2">PLOT DATE:</td><td>24 SEPT 2024</td></tr><tr><td colspan="2">PROJECT NO.:</td><td>21-06</td></tr><tr><td colspan="2">DRAWN BY:</td><td>CDS</td></tr><tr><td colspan="2">CHECKED BY:</td><td>dlp</td></tr><tr><td colspan="2">PRINCIPAL IN CHARGE:</td><td>Lucio Picciano AIBC</td></tr><tr><td colspan="3">OWNER APPROVAL:</td></tr><tr><td colspan="2">SCALE:</td><td>1/8"=1'-0"</td></tr><tr><td colspan="3">SHEET TITLE</td></tr><tr><td colspan="3">COVER SHEET DRAWING LIST</td></tr><tr><td colspan="3">SHEET NO.</td></tr><tr><td colspan="3">DP1.0</td></tr></table>	-	-	-	-	-	-		-	-	No.	Date	Description	REVISIONS				24-Sept-24	DP FOR COUNCIL		10-Jul-23	DP Prior-to 2	-	20-Mar-23	DP Prior-to	-	27-Feb-23	Consultants	B	24-Aug-22	Development Permit	-	19-May-22	Review	-	13-May-22	Consultants	-	05-May-22	Consultants	A	17-Dec-21	Rezoning Pre-App	No.	Date	Description	ISSUE INFORMATION			PLOT DATE:		24 SEPT 2024	PROJECT NO.:		21-06	DRAWN BY:		CDS	CHECKED BY:		dlp	PRINCIPAL IN CHARGE:		Lucio Picciano AIBC	OWNER APPROVAL:			SCALE:		1/8"=1'-0"	SHEET TITLE			COVER SHEET DRAWING LIST			SHEET NO.		
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<div>Zero Energy and Passivhaus Institute for Research (ZEPHIR) Francesco Nesi 39 - 38057 Pergine Valsugana TM, Italy (p) +39 331.8146937 (e) f.nesi@zephir.ph</div>																																																																																					
Drawing List																																																																																					
<div>DP1.0 COVER SHEET DP1.1 SITE PLAN PROJECT DATA CODE ANALYSIS DP1.2 3D VIEWS DP2.0 BASEMENT PLANS DP2.1 MAIN FLOOR PLANS DP2.2 2ND FLOOR PLANS DP2.3 ROOF PLANS DP2.4 ROOF PLANS DP3.0 ELEVATIONS DP3.1 ELEVATIONS DP3.2 ELEVATIONS DP3.3 ELEVATIONS DP3.4 ELEVATIONS DP3.5 ELEVATIONS DP4.0 SECTIONS</div>																																																																																					

Project Data

REAR $(222.73 + 228.15)/2$	225.44 ft
$231.65 + ((225.44 - 231.65)0.4)$	229.17 ft



Architecture

LP ARCHITECTURE INC
202-460 NANAIMO ST
VANCOUVER BC V5L 4W3
778-889-6849

PRIMARY CONTACT:

L. LUCIO PICCIANO
202-460 NANAIMO ST
VANCOUVER BC V5L 4W3
778-889-6849

PROJECT:

HERITAGE REVITALIZATION and NEW LOW ENERGY DUPLEX

PROJECT ADDRESS:
11 West 14th Street.
City of North Vancouver, BC

OWNER:
352644 BC LTD



ARCHITECT SEAL

	-	-
	-	-
	-	-
o. Date	Description	

REVISIONS

24-Sept-24	DP FOR COUNCIL
10-Jul-23	DP Prior-to 2
20-Mar-23	DP Prior-to
27-Feb-23	Consultants
24-Aug-22	Development Permit
19-May-22	Review
13-May-22	Consultants
05-May-22	Consultants

No.	Date	Description
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ISSUE INFORMATION

LOT DATE: 24 SEPT 2024

PROJECT NO.: 21-06

RAWN BY: CDS

HECKED BY: dlp

PRINCIPAL IN CHARGE:
Lucio Picciano, AIBC

OWNER APPROVAL:

SCALE: $1/8"=1'-0"$

SHEET TITLE

SITE PLAN

PROJECT DATA

SHEET NO.

DP1.1

ORIGINAL SHEET SIZE 34" x 22"



AERIAL VIEW OF FRONT YARD HERITAGE HOUSE



PERSPECTIVE SOUTH FROM WEST SIDEYARD



FRONT VIEW SE OF HERITAGE HOUSE



PERSPECTIVE EAST FROM WEST SIDEYARD



REAR OF HERITAGE HOUSE



REAR OF LANEWAY DUPLEX



Shown with optional ramp



2 2 bike storage locker
DP1.2 Scale - NTS

1 311 w 14th st LANE VIEW
DP1.2 Scale - NTS

ARCHITECT:

dlp

architecture

DLP ARCHITECTURE INC
202-460 NANAIMO ST
VANCOUVER BC V6L 4W3
778-889-6849

PRIMARY CONTACT:

D. LUCIO PICCIANO
202-460 NANAIMO ST
VANCOUVER BC V6L 4W3
778-889-6849

PROJECT:


HERITAGE
REVITALIZATION and
NEW LOW ENERGY
DUPLEX

PROJECT ADDRESS:

311 West 14th Street.
City of North Vancouver, BC

OWNER:

1352644 BC LTD

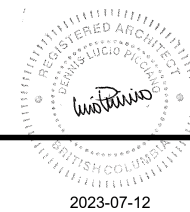

ARCHITECT SEAL

-	-	-
-	-	-
-	-	-
-	-	-
No.	Date	Description

REVISIONS

	10-Jul-23	DP Prior-to 2
-	20-Mar-23	DP Prior-to
-	27-Feb-23	Consultants
B	24-Aug-22	Development Permit
-	19-May-22	Review
-	13-May-22	Consultants
-	05-May-22	Consultants
A	17-Dec-21	Rezoning Pre-App

No.	Date	Description
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ISSUE INFORMATION

PLOT DATE: 10 July 2023

PROJECT NO.: 21-06

DRAWN BY: CDS

CHECKED BY: dlp

PRINCIPAL IN CHARGE: Lucio Picciano AIBC

OWNER APPROVAL:

SCALE:

SHEET TITLE

3D VIEWS

SHEET NO.

DP1.2

ORIGINAL SHEET SIZE 34" x 22"

1

Roof Assemblies

RSI CALCULATION

RSI CALCULATION

TYPICAL FLAT ROOF

ASSEMBLY THICKNESS	R4	21.00
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4

Notes: Refer to Elevations for Operation All windows to conform to CBC 9.7. Windows, Doors and Skylights	Notes: Refer to Elevations for Operation All windows to conform to CBC 9.7. Windows, Doors and Skylights	Notes: Refer to Elevations for Operation All windows to conform to CBC 9.7. Windows, Doors and Skylights	Notes: Refer to Elevations for Operation All windows to conform to CBC 9.7. Windows, Doors and Skylights
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Supplier	TBD	Supplier	TBD	Supplier	TBD	Supplier	TBD
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Notes: Refer to Elevations for Operation All windows to conform to CBC9.7. Windows, Doors and Skylights	Notes: Refer to Elevations for Operation All windows to conform to CBC9.7. Windows, Doors and Skylights	Notes: Refer to Elevations for Operation All windows to conform to CBC9.7. Windows, Doors and Skylights	Notes: Refer to Elevations for Operation All windows to conform to CBC9.7. Windows, Doors and Skylights
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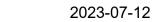
Supplier	TBD	Supplier	TBD	Supplier	TBD
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PRIMARY CONTACT:

PROJECT:

PROJECT ADDRESS:
311 West 14th Street.
City of North Vancouver, BC



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REVISIONS

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PROJECT NO.:	21-000
DRAWN BY:	CD


CHECKED BY:	dl
PRINCIPAL IN CHARGE:	

OWNER APPROVAL:

SCALE: NTC

SHEET TITLE

DD 14

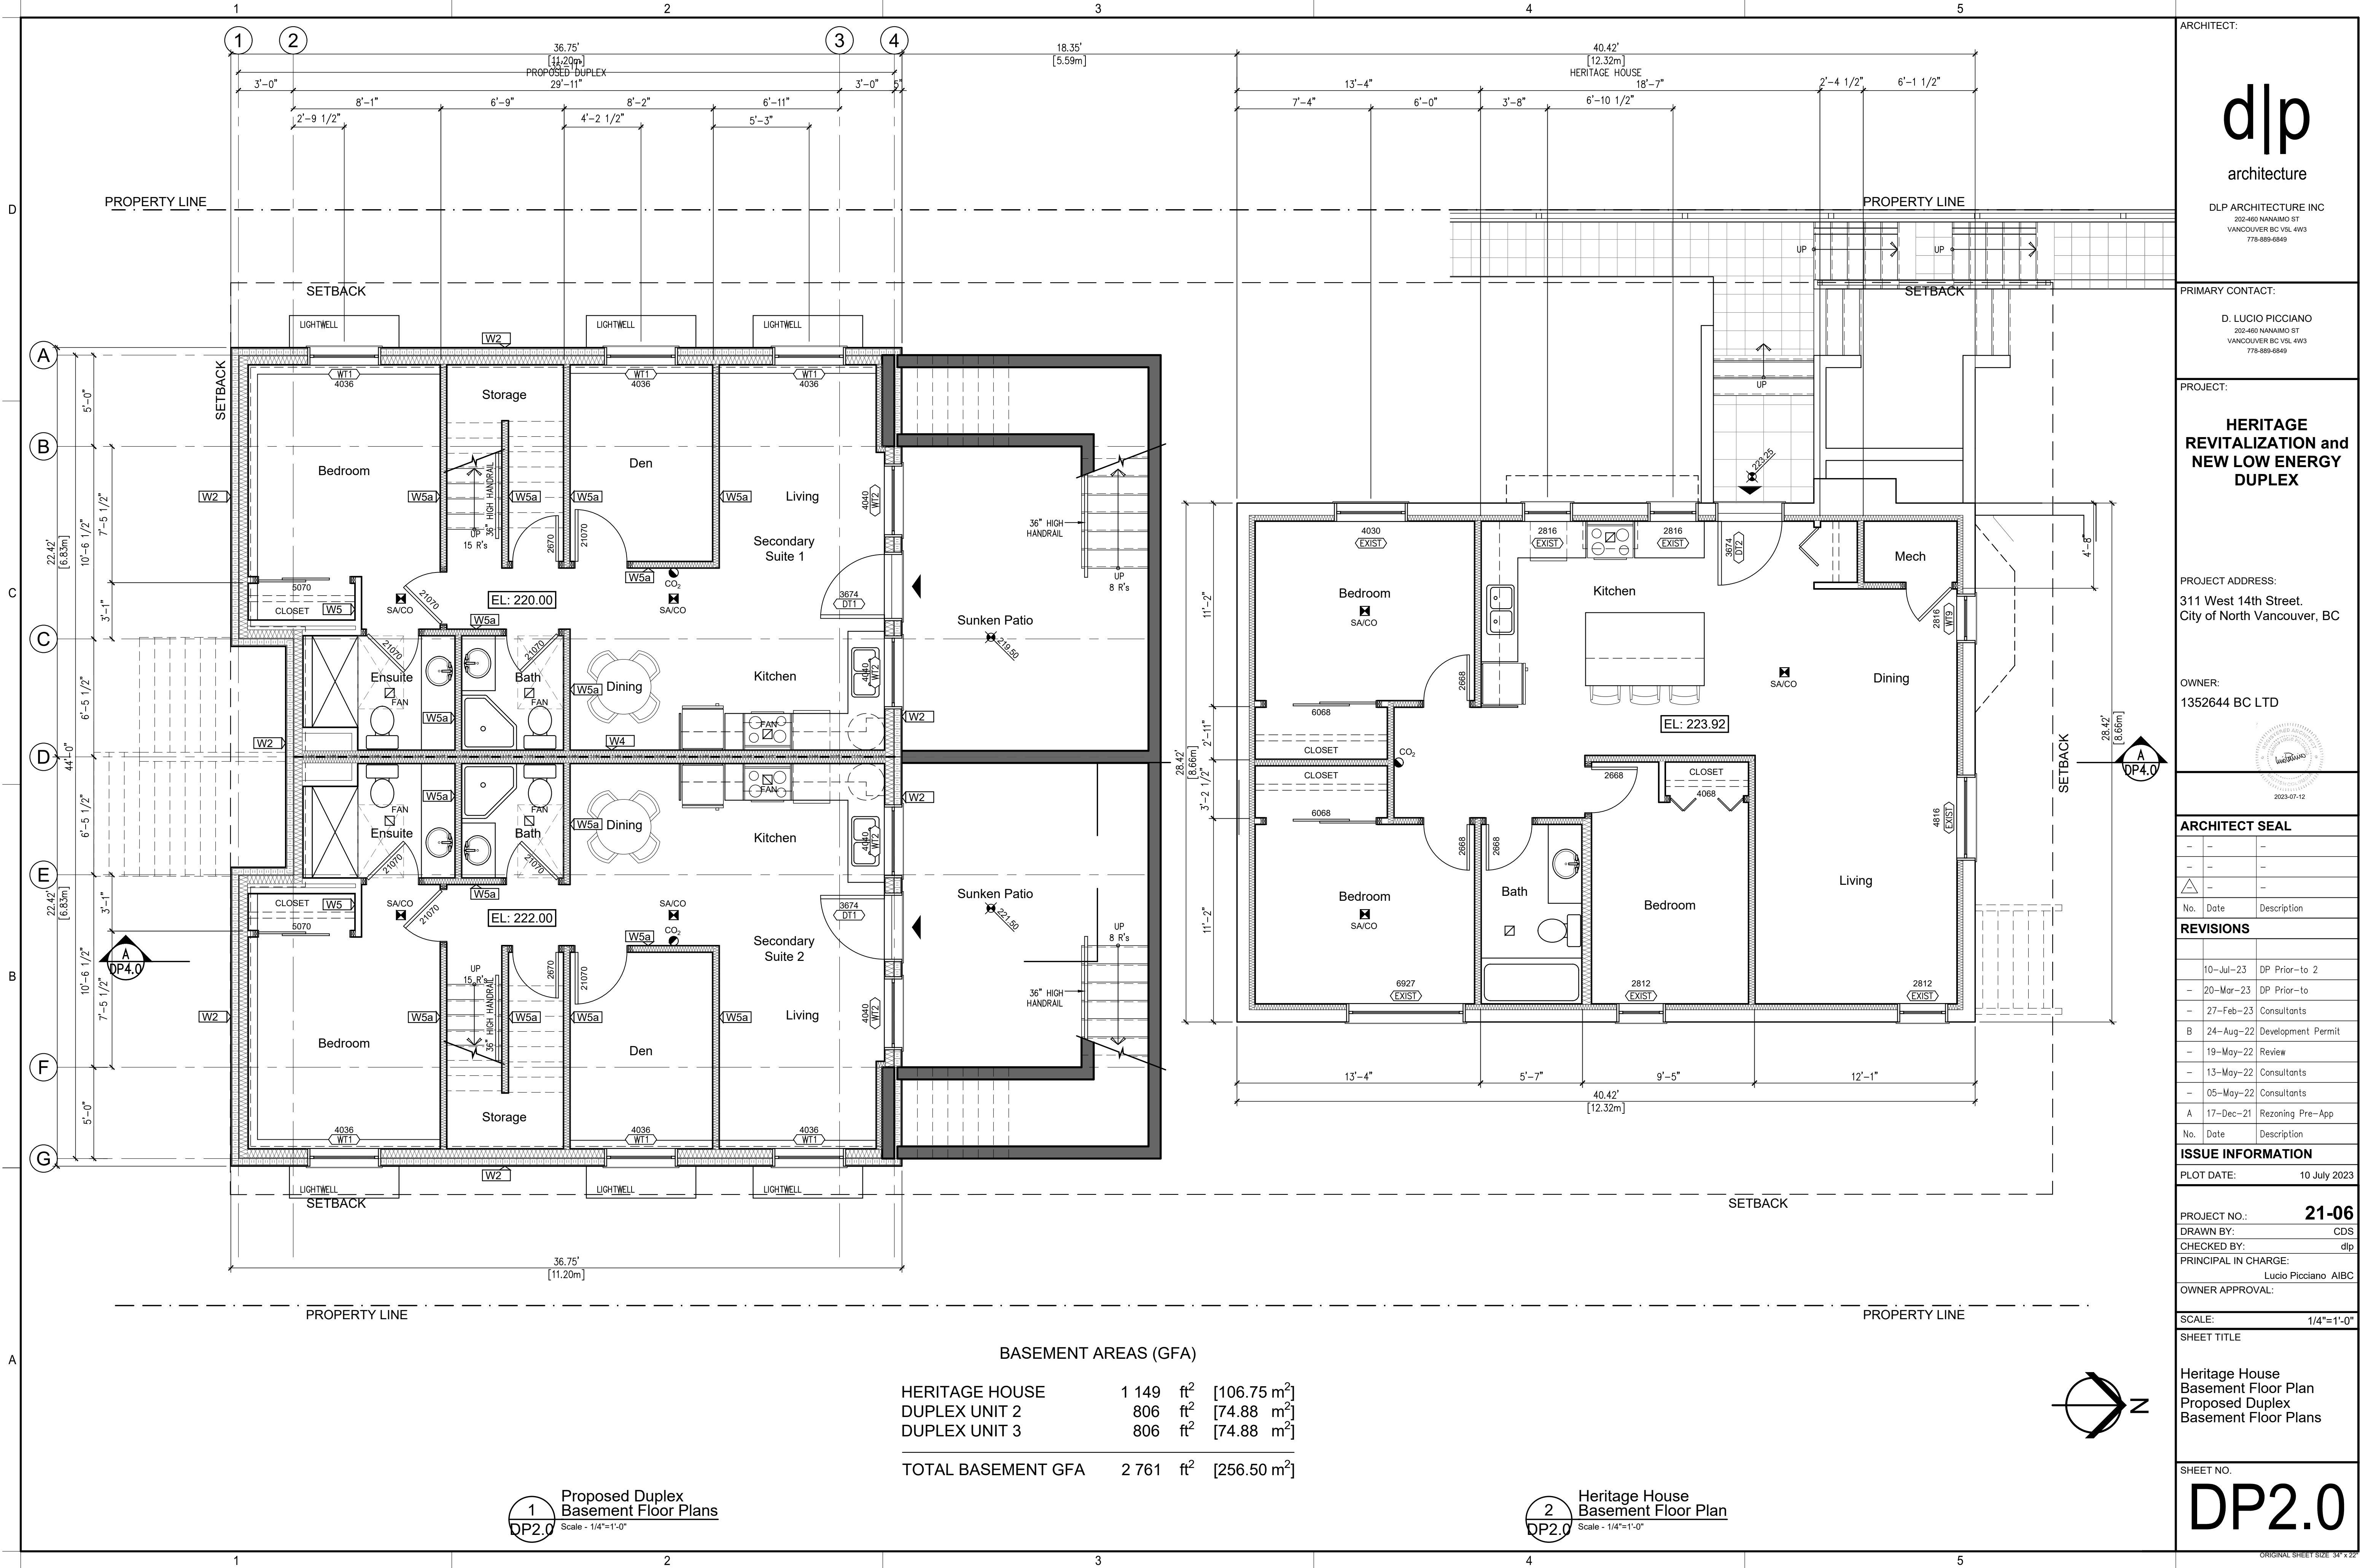

BASEMENT AREAS (GFA)

HERITAGE HOUSE	1 149	ft ²	[106.75 m ²]
DUPLEX UNIT 2	806	ft ²	[74.88 m ²]
DUPLEX UNIT 3	806	ft ²	[74.88 m ²]
TOTAL BASEMENT GFA	2 761	ft ²	[256.50 m ²]

1 Proposed Duplex
Basement Floor Plans
Scale - 1/4"=1'-0"

2 Heritage House
Basement Floor Plan
Scale - 1/4"=1'-0"

ARCHITECT:

dlp
architecture
DLP ARCHITECTURE INC
202-460 NANAIMO ST
VANCOUVER BC V6L 4W3
778-889-6849

PRIMARY CONTACT:

D. LUCIO PICCIANO
202-460 NANAIMO ST
VANCOUVER BC V6L 4W3
778-889-6849

PROJECT:

HERITAGE
REVITALIZATION and
NEW LOW ENERGY
DUPLEX

PROJECT ADDRESS:

311 West 14th Street.
City of North Vancouver, BC

OWNER:

1352644 BC LTD

ARCHITECT SEAL

No. Date Description

REVISIONS

	10-Jul-23	DP Prior-to 2
-	20-Mar-23	DP Prior-to
-	27-Feb-23	Consultants
B	24-Aug-22	Development Permit
-	19-May-22	Review
-	13-May-22	Consultants
-	05-May-22	Consultants
A	17-Dec-21	Rezoning Pre-App

ISSUE INFORMATION

No. Date Description

PLOT DATE: 10 July 2023

PROJECT NO.: 21-06
DRAWN BY: CDS
CHECKED BY: dlp
PRINCIPAL IN CHARGE: Lucio Picciano AIBC
OWNER APPROVAL:

SCALE: 1/4"=1'-0"


SHEET TITLE

Heritage House
Basement Floor Plan
Proposed Duplex
Basement Floor Plans

SHEET NO.

DP2.0

ORIGINAL SHEET SIZE 34" x 22"

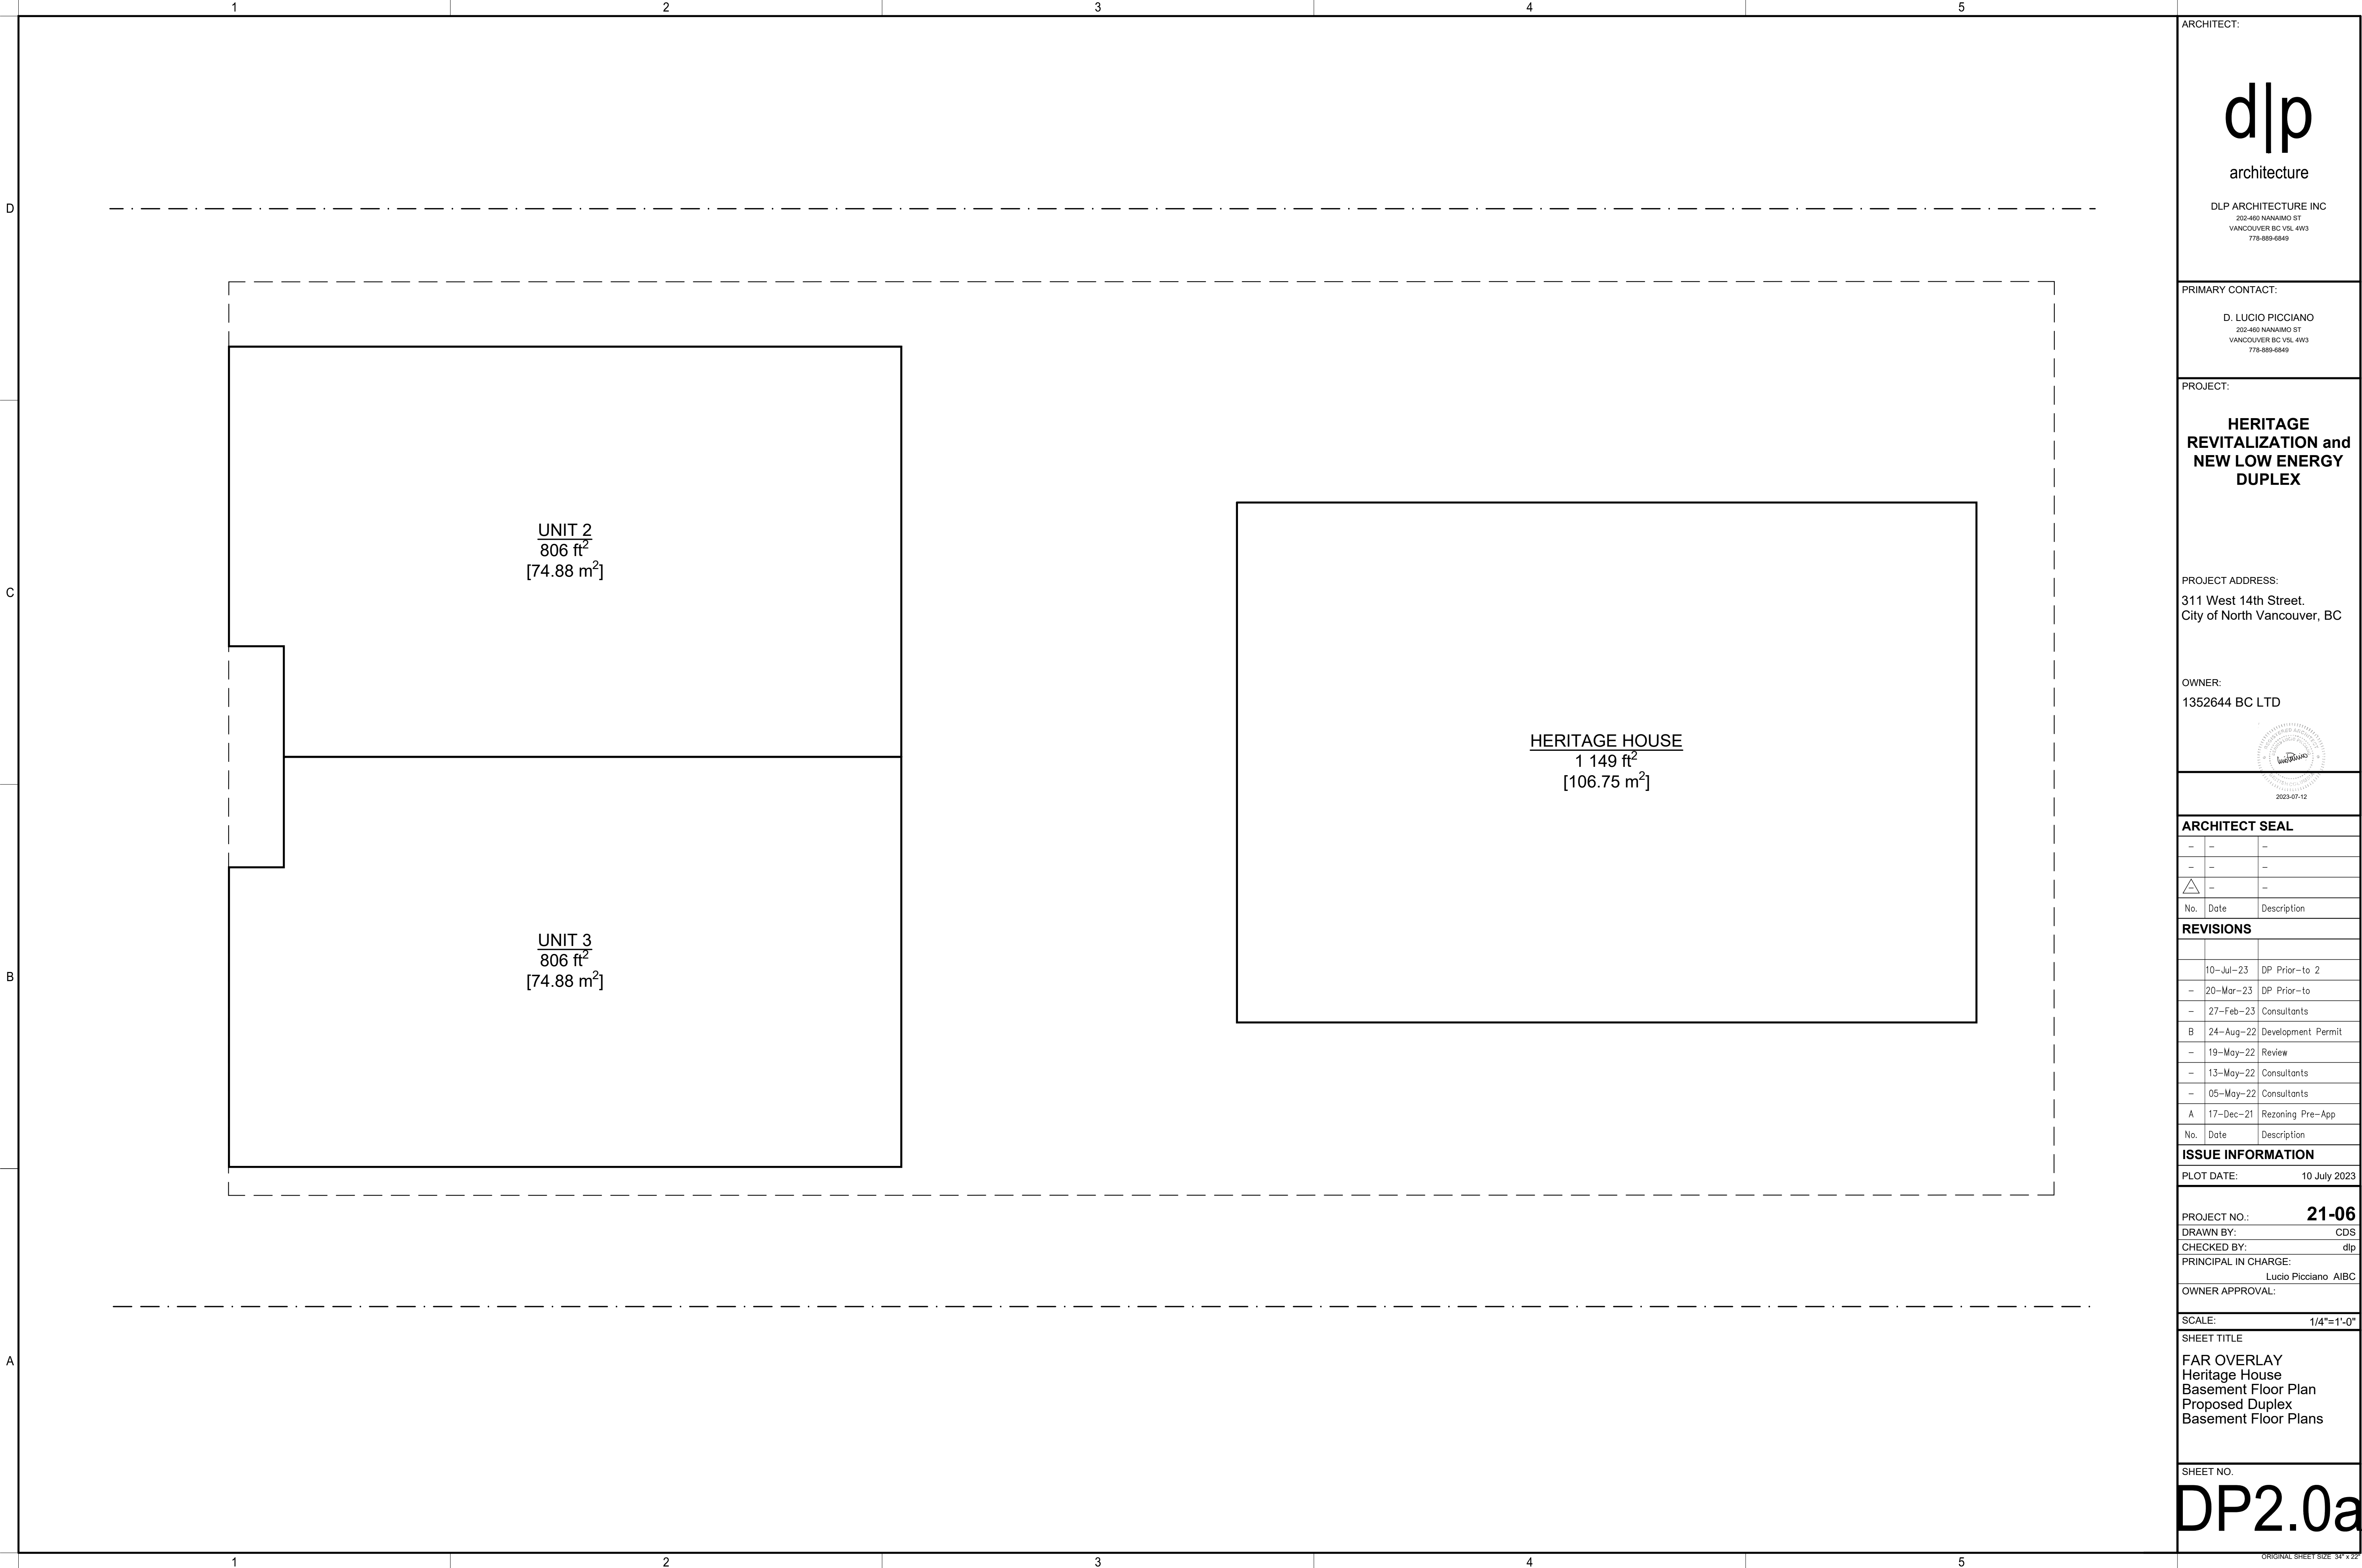

ARCHITECT:

dlp

architecture

DLP ARCHITECTURE INC
202-460 NANAIMO ST
VANCOUVER BC V6L 4W3
778-889-6849

PRIMARY CONTACT:

D. LUCIO PICCIANO
202-460 NANAIMO ST
VANCOUVER BC V6L 4W3
778-889-6849

PROJECT:


HERITAGE
REVITALIZATION and
NEW LOW ENERGY
DUPLEX

PROJECT ADDRESS:

311 West 14th Street.
City of North Vancouver, BC

OWNER:

1352644 BC LTD

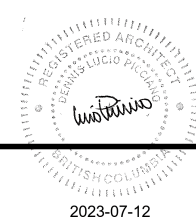

ARCHITECT SEAL

- - -

- - -

- - -

No. Date Description

REVISIONS

10-Jul-23 DP Prior-to 2

20-Mar-23 DP Prior-to

27-Feb-23 Consultants

B 24-Aug-22 Development Permit

19-May-22 Review

13-May-22 Consultants

05-May-22 Consultants

A 17-Dec-21 Rezoning Pre-App

No. Date Description

ISSUE INFORMATION

PLOT DATE:

10 July 2023

PROJECT NO.:

21-06

DRAWN BY:

CDS

CHECKED BY:

dlp

PRINCIPAL IN CHARGE:

Lucio Picciano AIBC

OWNER APPROVAL:

SCALE:

1/4"=1'-0"

SHEET TITLE

FAR OVERLAY

Heritage House

Basement Floor Plan


Proposed Duplex

Basement Floor Plans

SHEET NO.

DP2.0a

ORIGINAL SHEET SIZE 34" x 22"

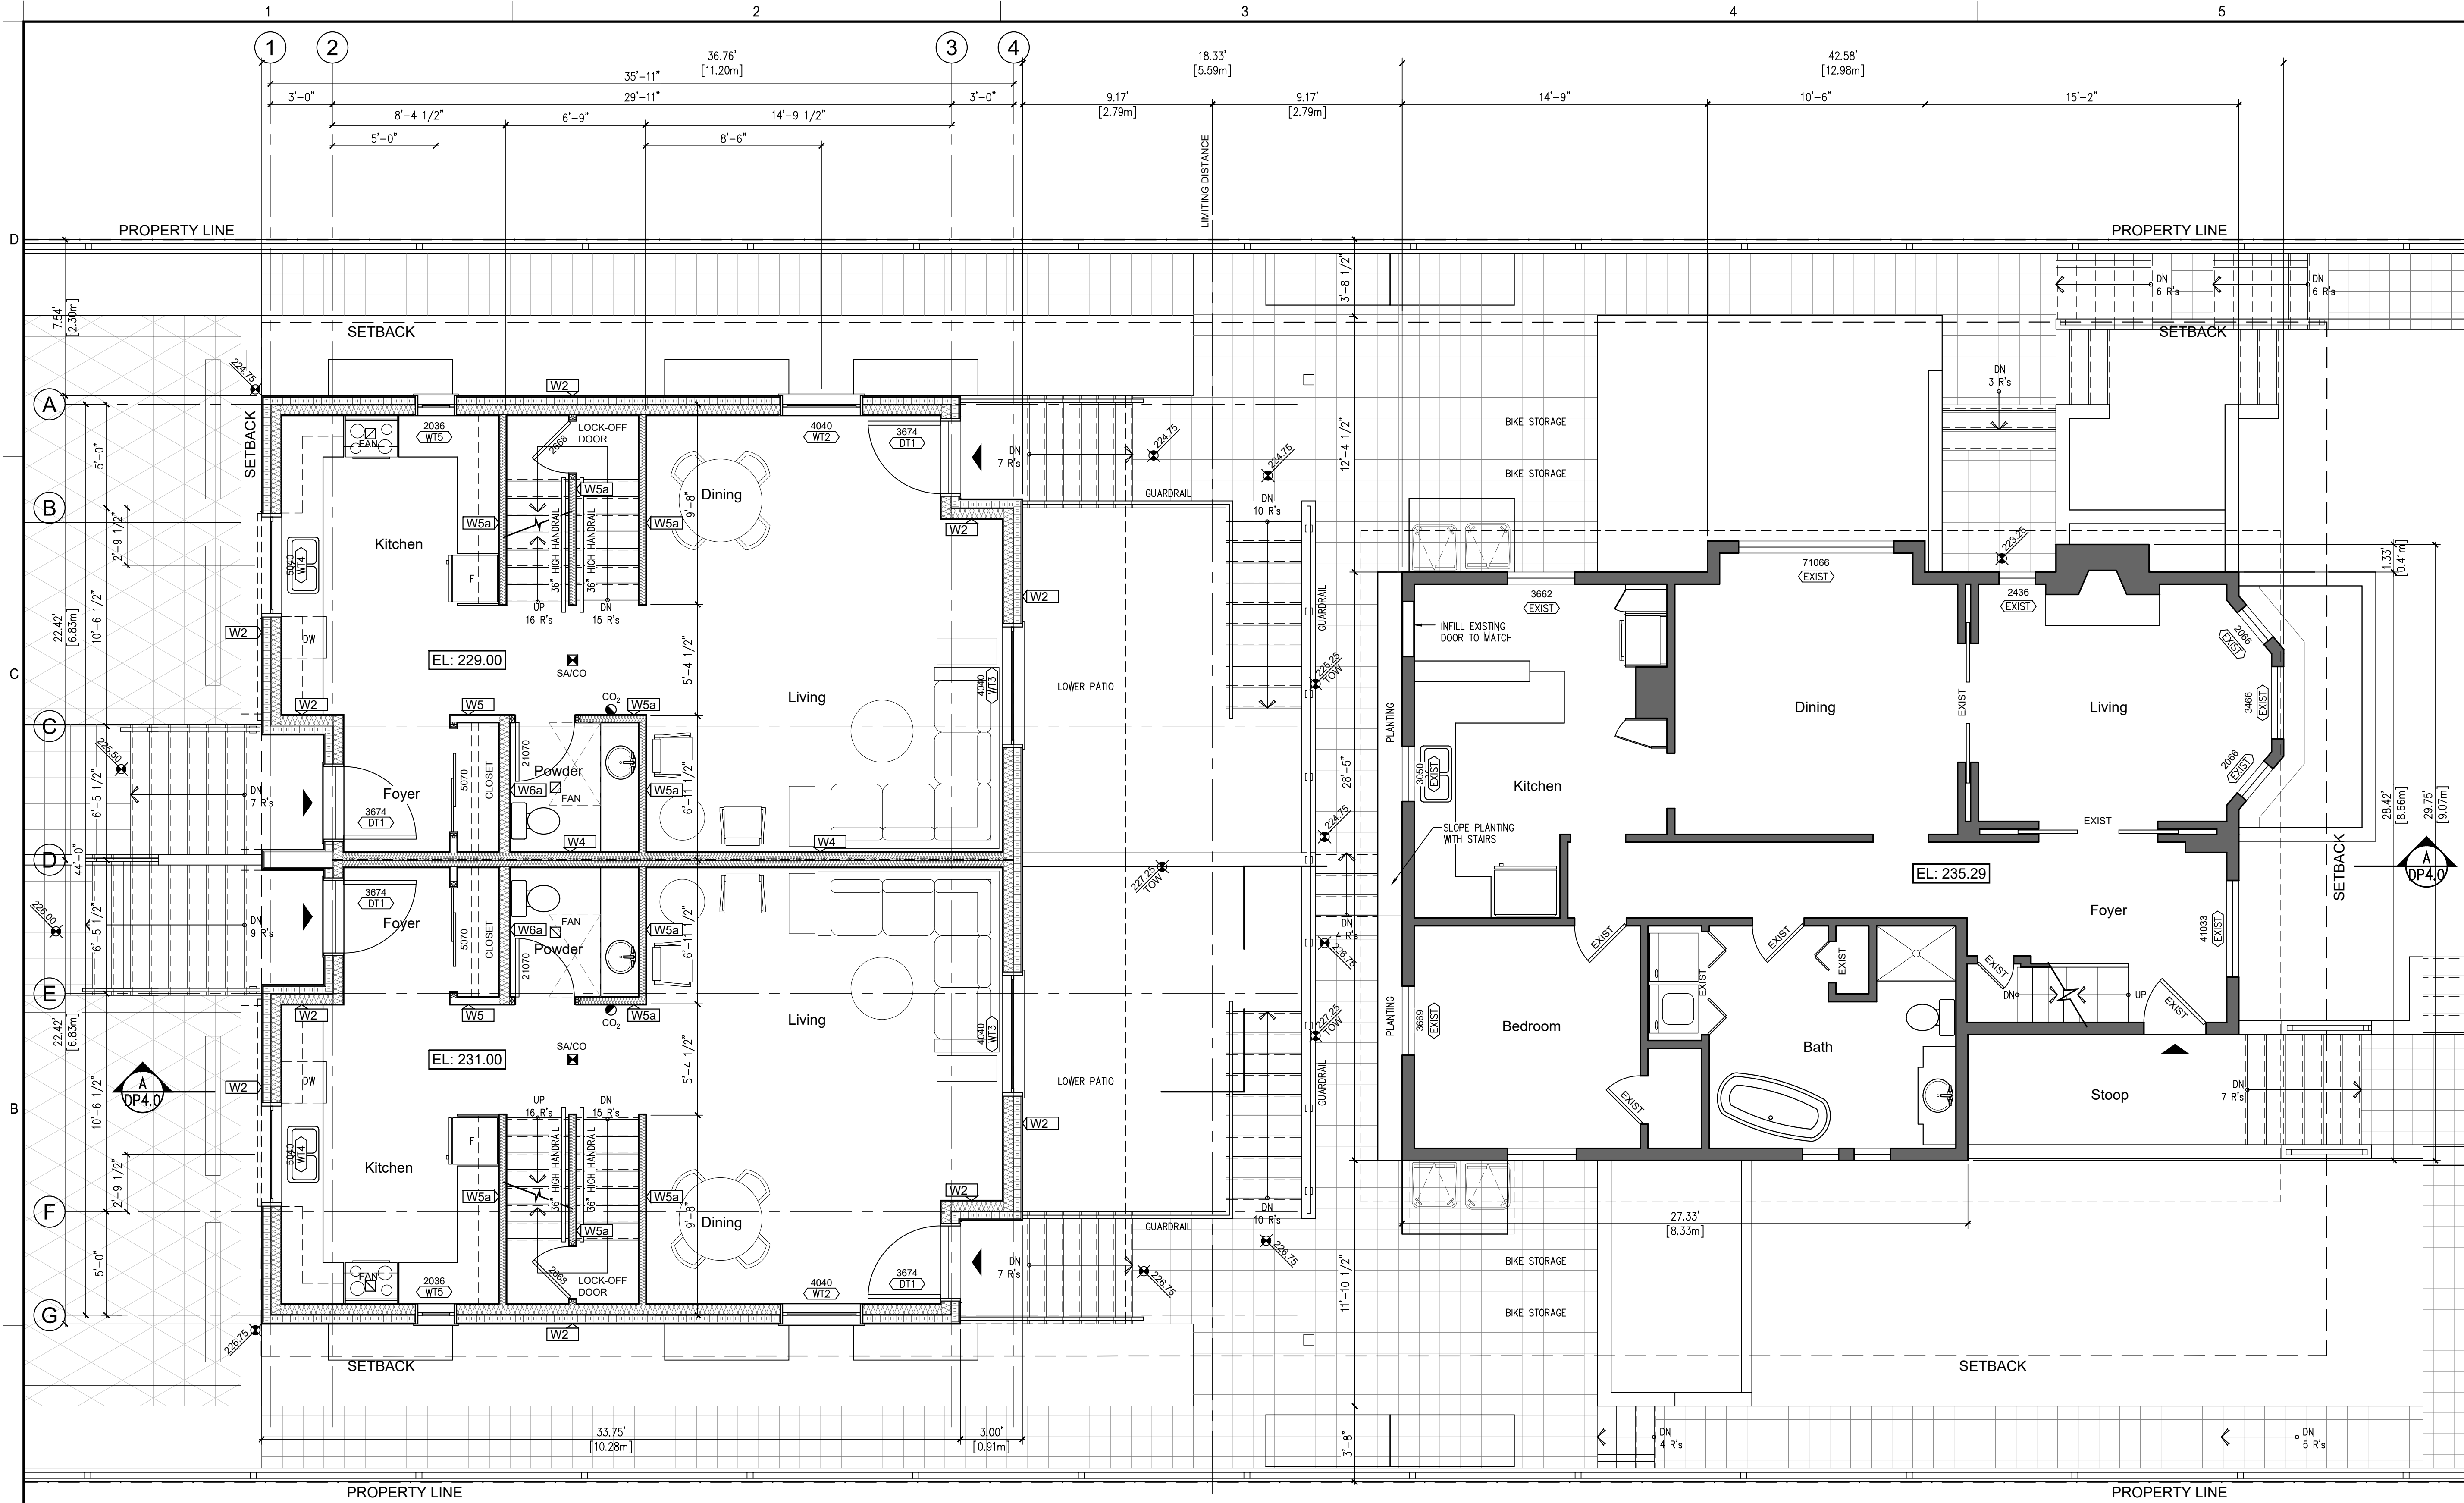


MAIN FLOOR AREAS (GFA)

HERITAGE HOUSE	1 102	ft ²	[102.38m ²]
DUPLEX UNIT 2	791	ft ²	[73.49 m ²]
DUPLEX UNIT 3	791	ft ²	[73.49 m ²]
TOTAL MAIN FLOOR GFA	2 684	ft ²	[249.35 m ²]

1
DP2.1
Proposed Duplex
Main Floor Plans
Scale - 1/4"=1'-0"

2
DP2.1
Heritage House
Main Floor Plan
Scale - 1/4"=1'-0"

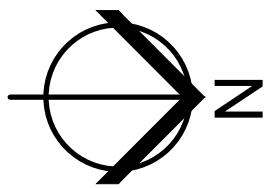

ARCHITECT:

dlp
architecture
DLP ARCHITECTURE INC
202-460 NANAIMO ST
VANCOUVER BC V6L 4W3
778-889-6849

PRIMARY CONTACT:

D. LUCIO PICCIANO
202-460 NANAIMO ST
VANCOUVER BC V6L 4W3
778-889-6849

PROJECT:

HERITAGE
REVITALIZATION and
NEW LOW ENERGY
DUPLEX

PROJECT ADDRESS:

311 West 14th Street.
City of North Vancouver, BC

OWNER:

1352644 BC LTD

ARCHITECT SEAL

REVISIONS

No.	Date	Description
10-Jul-23	DP Prior-to 2	
20-Mar-23	DP Prior-to	
27-Feb-23	Consultants	
24-Aug-22	Development Permit	
19-May-22	Review	
13-May-22	Consultants	
05-May-22	Consultants	
17-Dec-21	Rezoning Pre-App	

ISSUE INFORMATION

No.	Date	Description
PLOT DATE: 10 July 2023		

PROJECT NO.: 21-06
DRAWN BY: CDS
CHECKED BY: dlp
PRINCIPAL IN CHARGE: Lucio Picciano AIBC
OWNER APPROVAL:

SCALE: 1/4"=1'-0"


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Heritage House
Main Floor Plan
Proposed Duplex
Main Floor Plans


SHEET NO.

DP2.1

ORIGINAL SHEET SIZE 34" x 22"

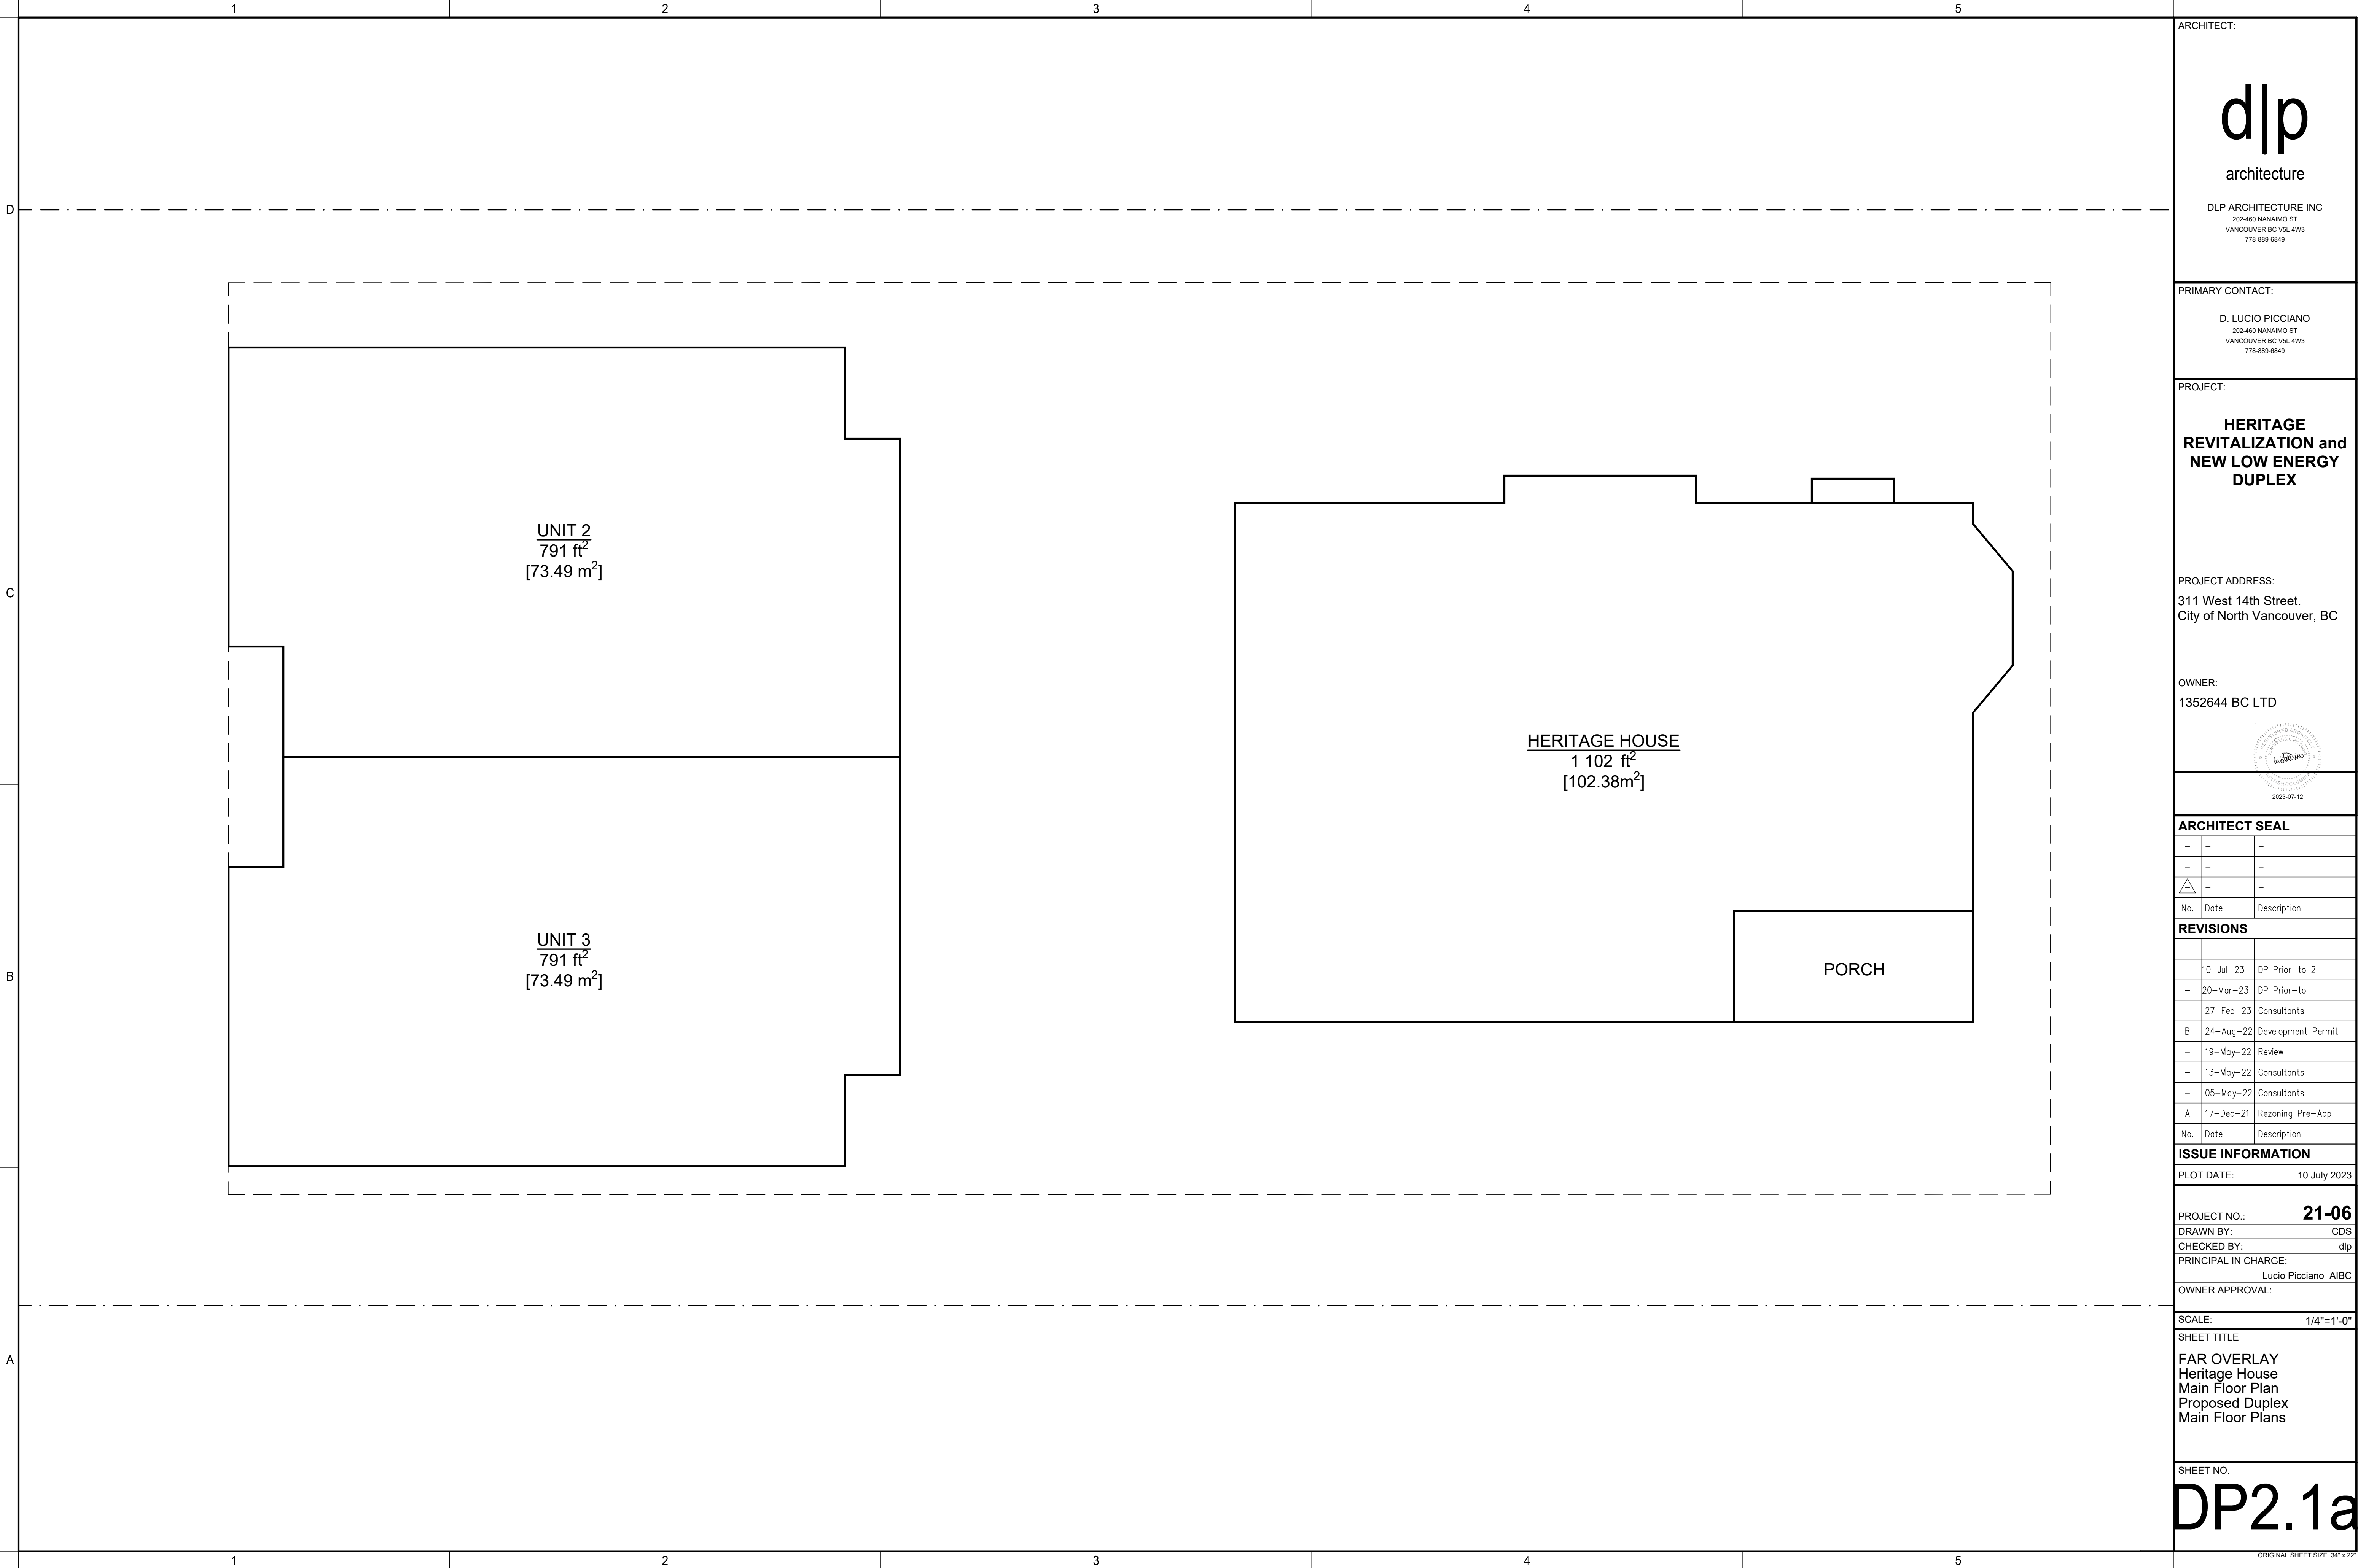

ARCHITECT:



architecture

DLP ARCHITECTURE INC
202-460 NANAIMO ST
VANCOUVER BC V6L 4W3
778-889-6849

PRIMARY CONTACT:


D. LUCIO PICCIANO
202-460 NANAIMO ST
VANCOUVER BC V6L 4W3
778-889-6849


PROJECT:

**HERITAGE
REVITALIZATION and
NEW LOW ENERGY
DUPLEX**

PROJECT ADDRESS:
311 West 14th Street.
City of North Vancouver, BC

OWNER:
1352644 BC LTD

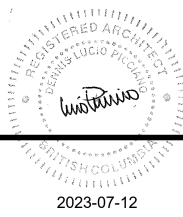

ARCHITECT SEAL		
-	-	-
-	-	-
	-	-
No.	Date	Description

REVISIONS		
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-	13-May-22	Consultants
-	05-May-22	Consultants
A	17-Dec-21	Rezoning Pre-App

No.	Date	Description
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ISSUE INFORMATION		
PLOT DATE:		10 July 2023

PROJECT NO.:	21-06
DRAWN BY:	CDS
CHECKED BY:	dlp
PRINCIPAL IN CHARGE:	Lucio Picciano AIBC
OWNER APPROVAL:	


SCALE:	1/4"=1'-0"
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SHEET TITLE

FAR OVERLAY
Heritage House
Main Floor Plan
Proposed Duplex
Main Floor Plans

SHEET NO.


DP2.1a

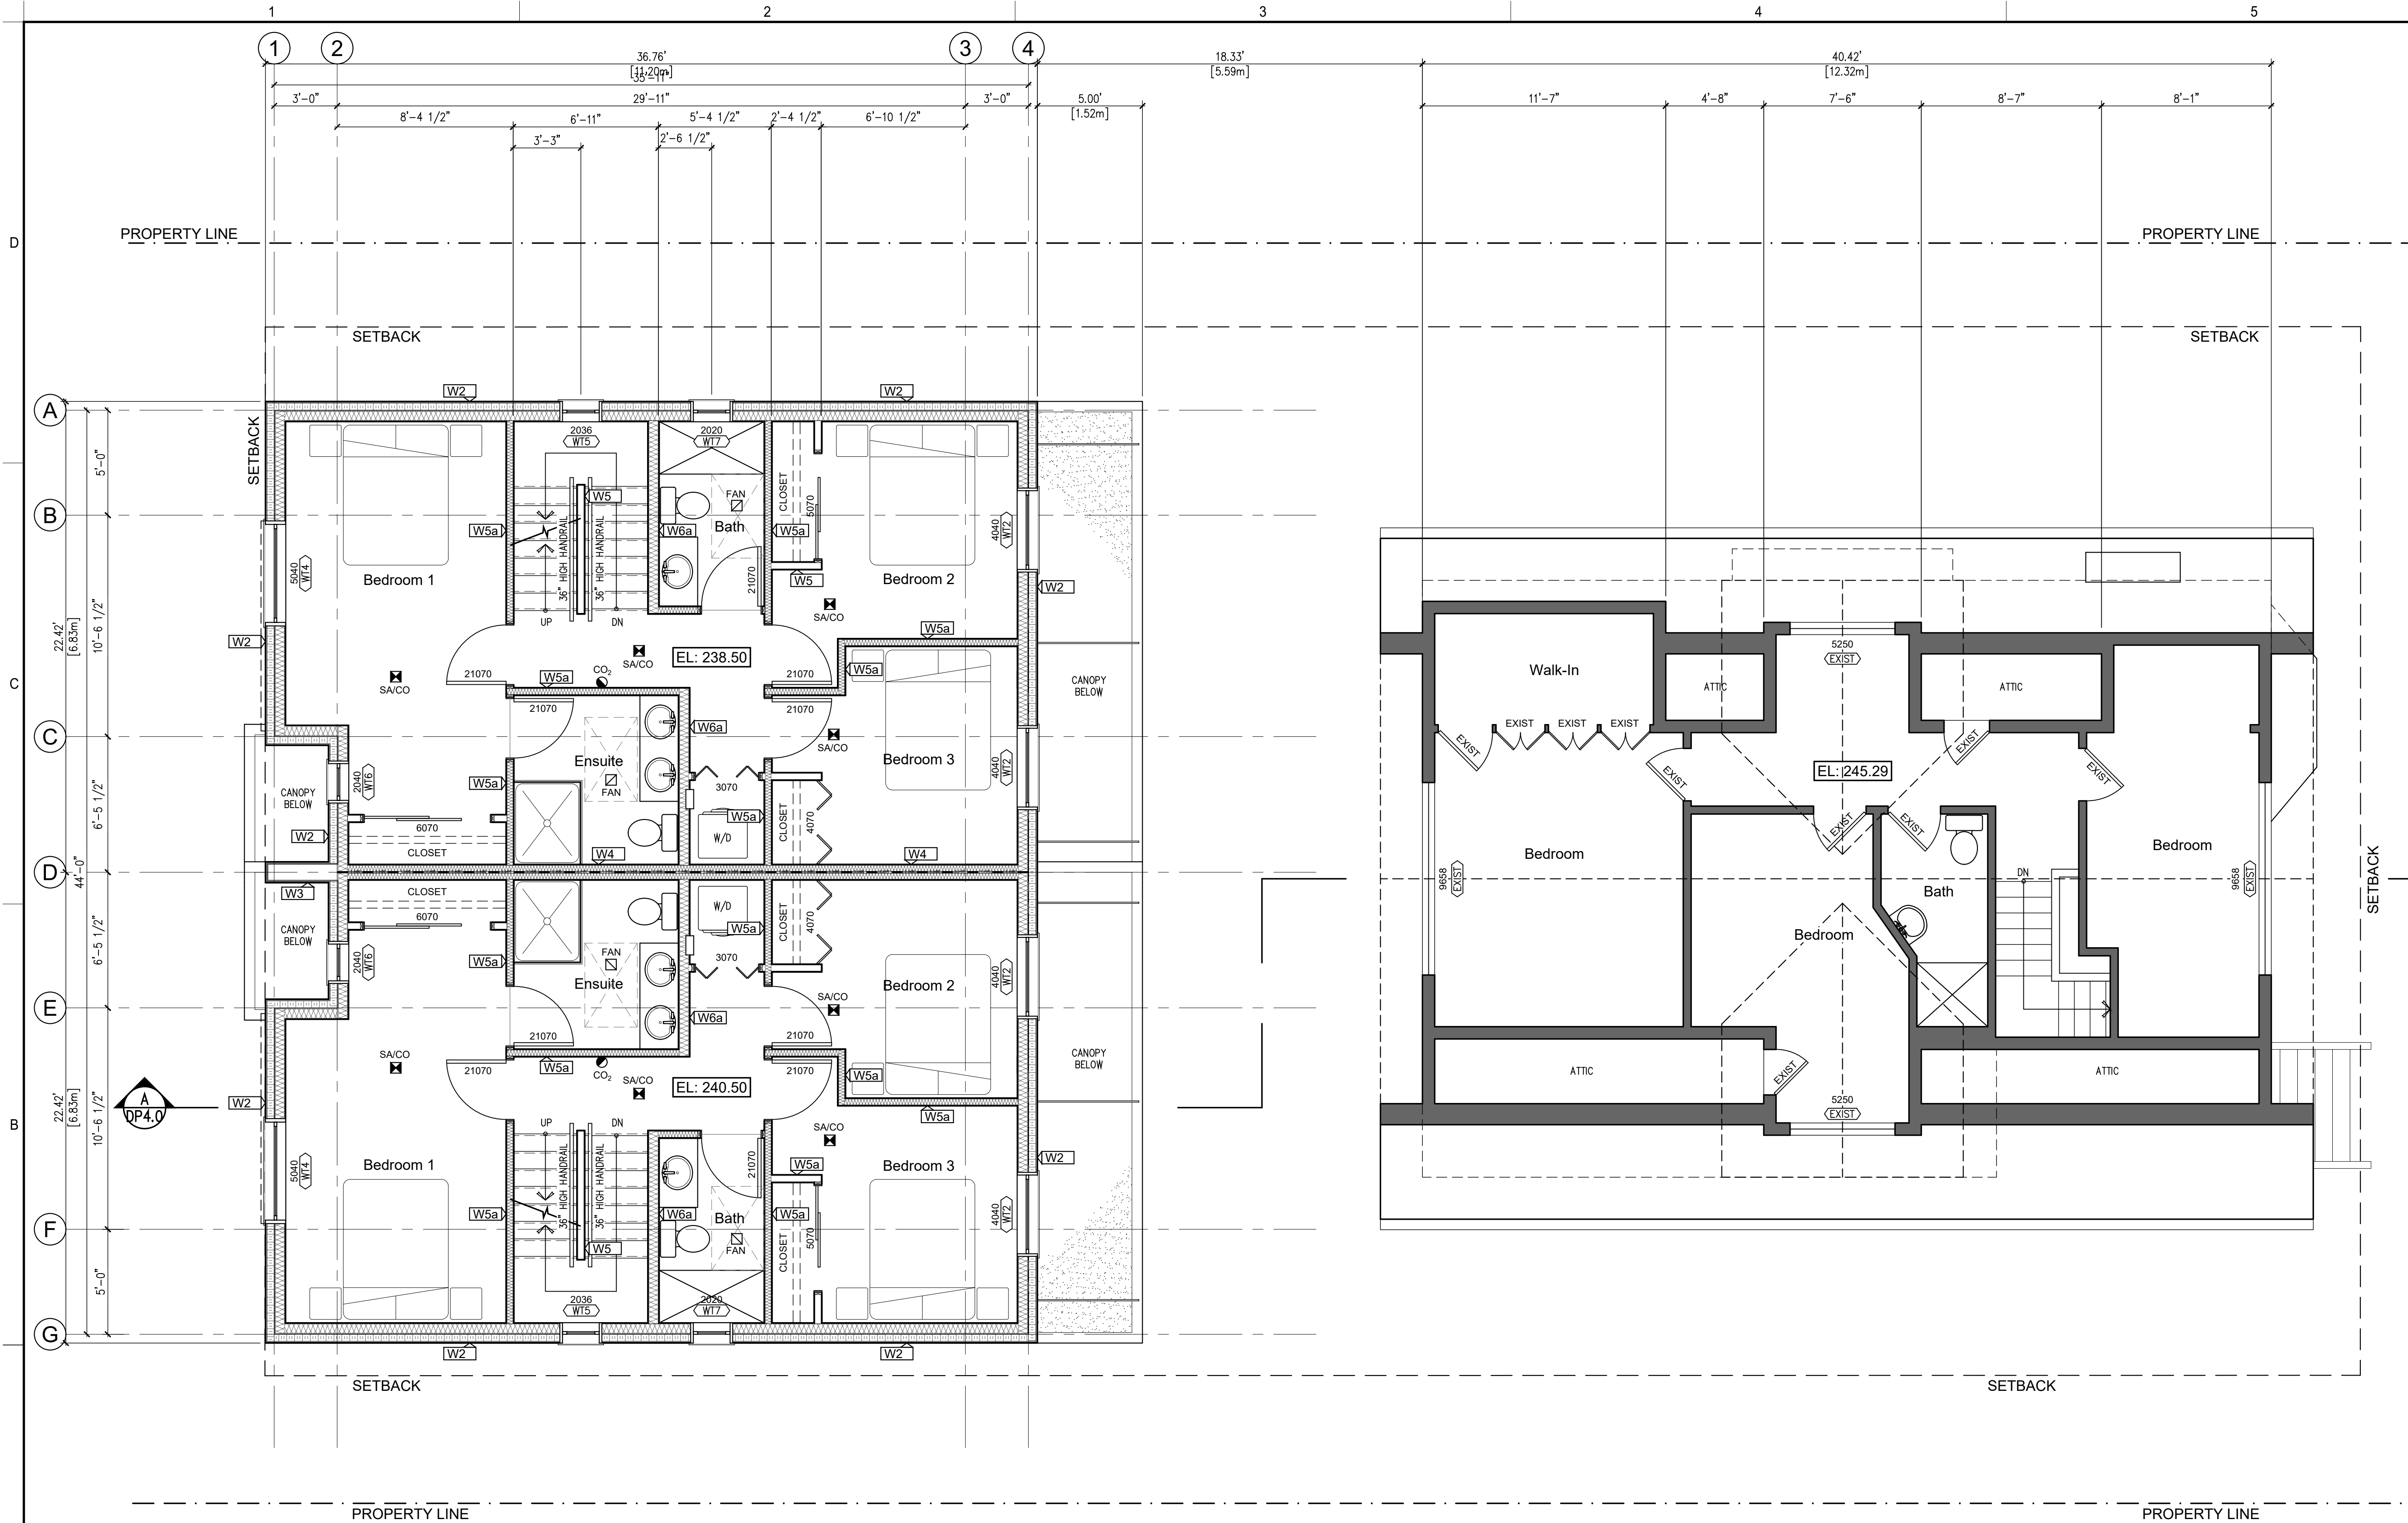

SECOND FLOOR AREAS (GFA)			
HERITAGE HOUSE	810	ft ²	[75.25 m ²]
DUPLEX UNIT 2	806	ft ²	[74.88 m ²]
DUPLEX UNIT 3	806	ft ²	[74.88 m ²]
TOTAL SECOND FLOOR GFA 2 422 ft ² [225.00 m ²]			

1
DP2.2
Proposed Duplex
Second Floor Plans
Scale - 1/4"=1'-0"

2
DP2.2
Heritage House
Second Floor Plan
Scale - 1/4"=1'-0"

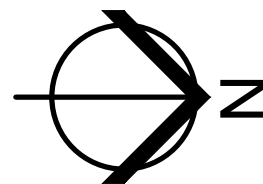

ARCHITECT:

dlp
architecture
DLP ARCHITECTURE INC
202-460 NANAIMO ST
VANCOUVER BC V6L 4W3
778-889-6849

PRIMARY CONTACT:

D. LUCIO PICCIANO
202-460 NANAIMO ST
VANCOUVER BC V6L 4W3
778-889-6849

PROJECT:

HERITAGE
REVITALIZATION and
NEW LOW ENERGY
DUPLEX

PROJECT ADDRESS:

311 West 14th Street.
City of North Vancouver, BC

OWNER:

1352644 BC LTD

ARCHITECT SEAL

No. Date Description

REVISIONS

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-	13-May-22	Consultants
-	05-May-22	Consultants
A	17-Dec-21	Rezoning Pre-App

No. Date Description

ISSUE INFORMATION

PLOT DATE: 10 July 2023

PROJECT NO.: 21-06
DRAWN BY: CDS
CHECKED BY: dlp
PRINCIPAL IN CHARGE: Lucio Picciano AIBC
OWNER APPROVAL:

SCALE: 1/4"=1'-0"


SHEET TITLE

Heritage House
Second Floor Plan
Proposed Duplex
Second Floor Plans

SHEET NO.

DP2.2

ORIGINAL SHEET SIZE 34" x 22"

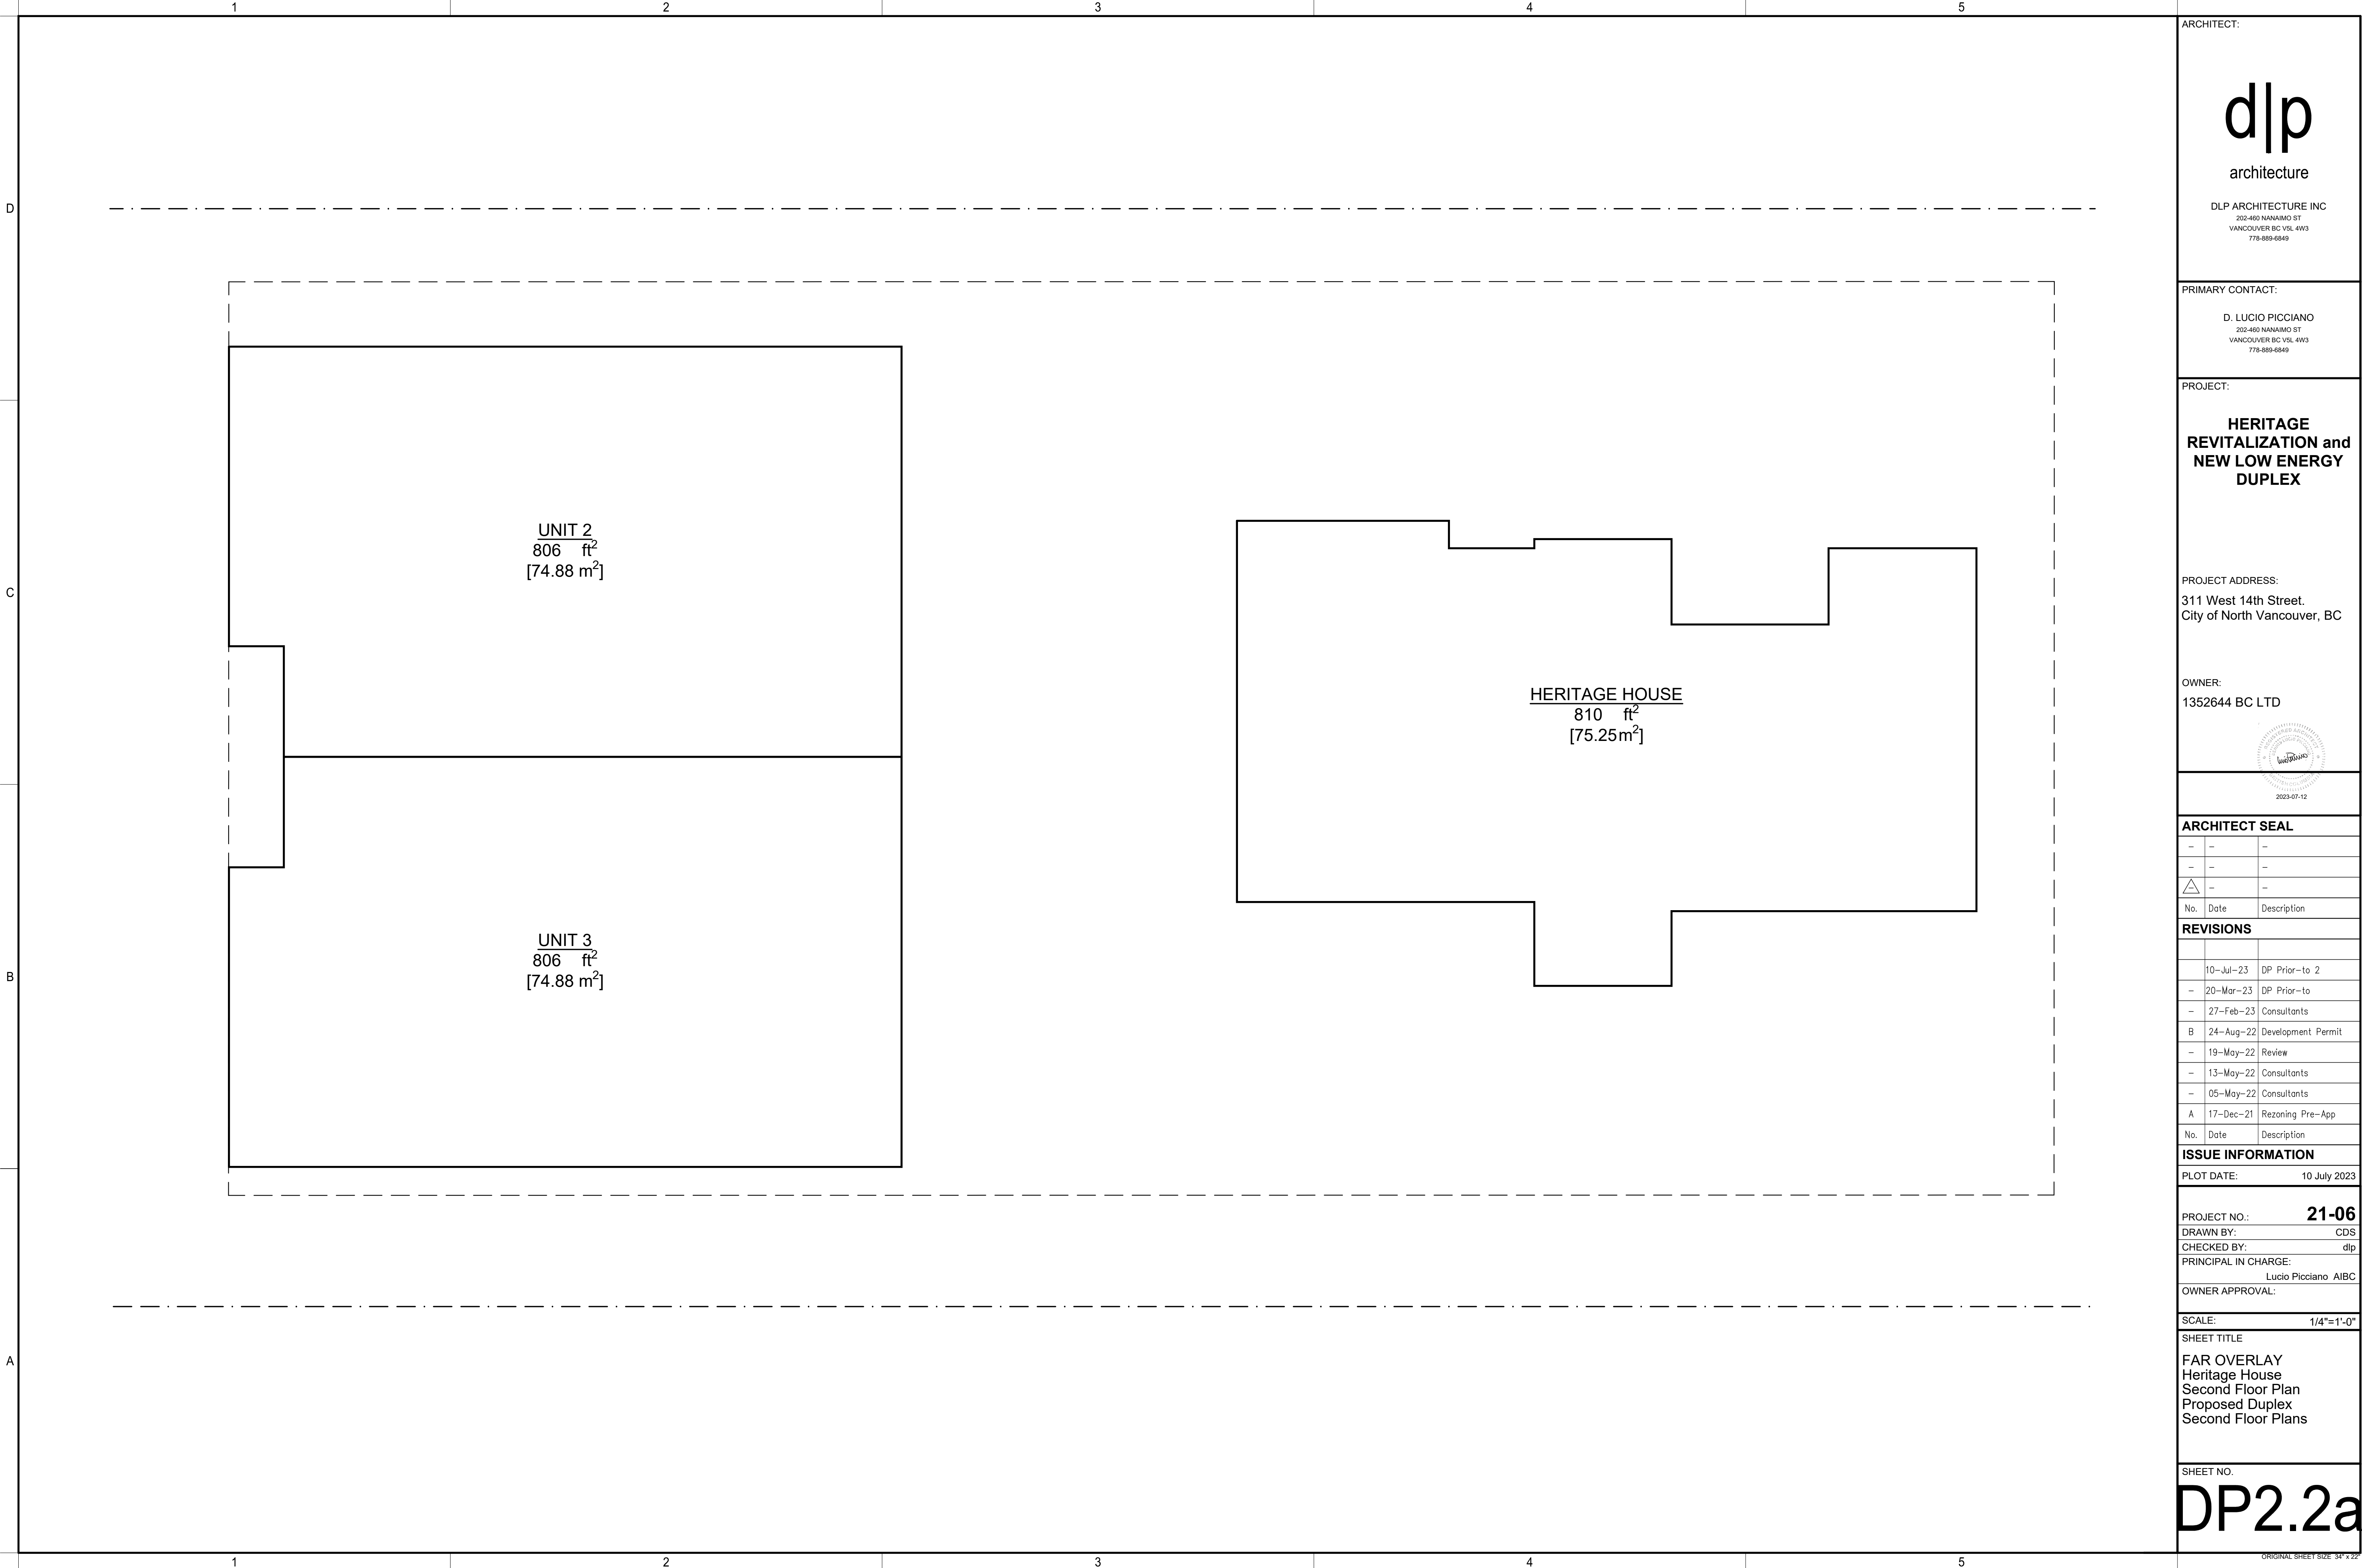

ARCHITECT:

dlp

architecture

DLP ARCHITECTURE INC
202-460 NANAIMO ST
VANCOUVER BC V6L 4W3
778-889-6849

PRIMARY CONTACT:

D. LUCIO PICCIANO
202-460 NANAIMO ST
VANCOUVER BC V6L 4W3
778-889-6849

PROJECT:

HERITAGE
REVITALIZATION and
NEW LOW ENERGY
DUPLEX

PROJECT ADDRESS:
311 West 14th Street.
City of North Vancouver, BC

OWNER:
1352644 BC LTD



ARCHITECT SEAL

-	-	-
-	-	-
△	-	-
No.	Date	Description

REVISIONS

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-	20-Mar-23	DP Prior-to
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-	13-May-22	Consultants
-	05-May-22	Consultants
A	17-Dec-21	Rezoning Pre-App

No.	Date	Description
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ISSUE INFORMATION

PLOT DATE: 10 July 2023



PROJECT NO.: 21-06
DRAWN BY: CDS
CHECKED BY: dlp
PRINCIPAL IN CHARGE:
Lucio Picciano AIBC
OWNER APPROVAL:

SCALE: 1/4"=1'-0"


SHEET TITLE
FAR OVERLAY
Heritage House
Second Floor Plan
Proposed Duplex
Second Floor Plans

SHEET NO.

DP2.2a

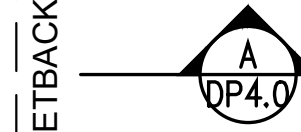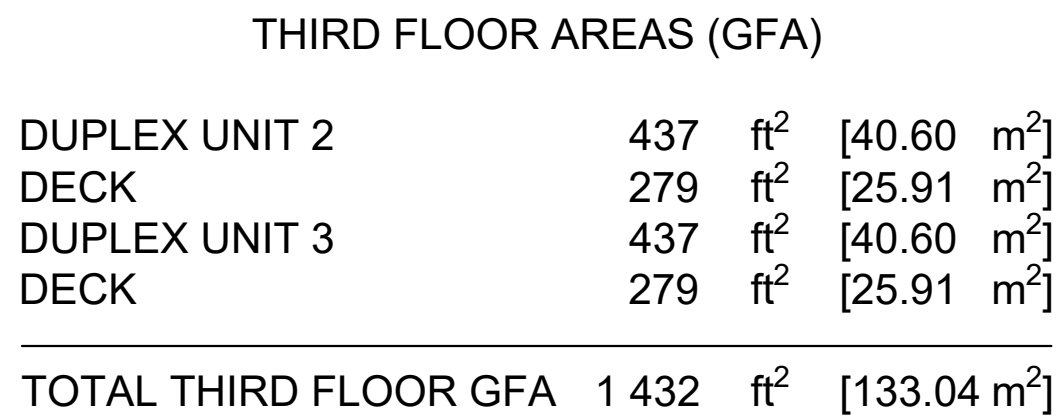

ORIGINAL SHEET SIZE 34" x 46"

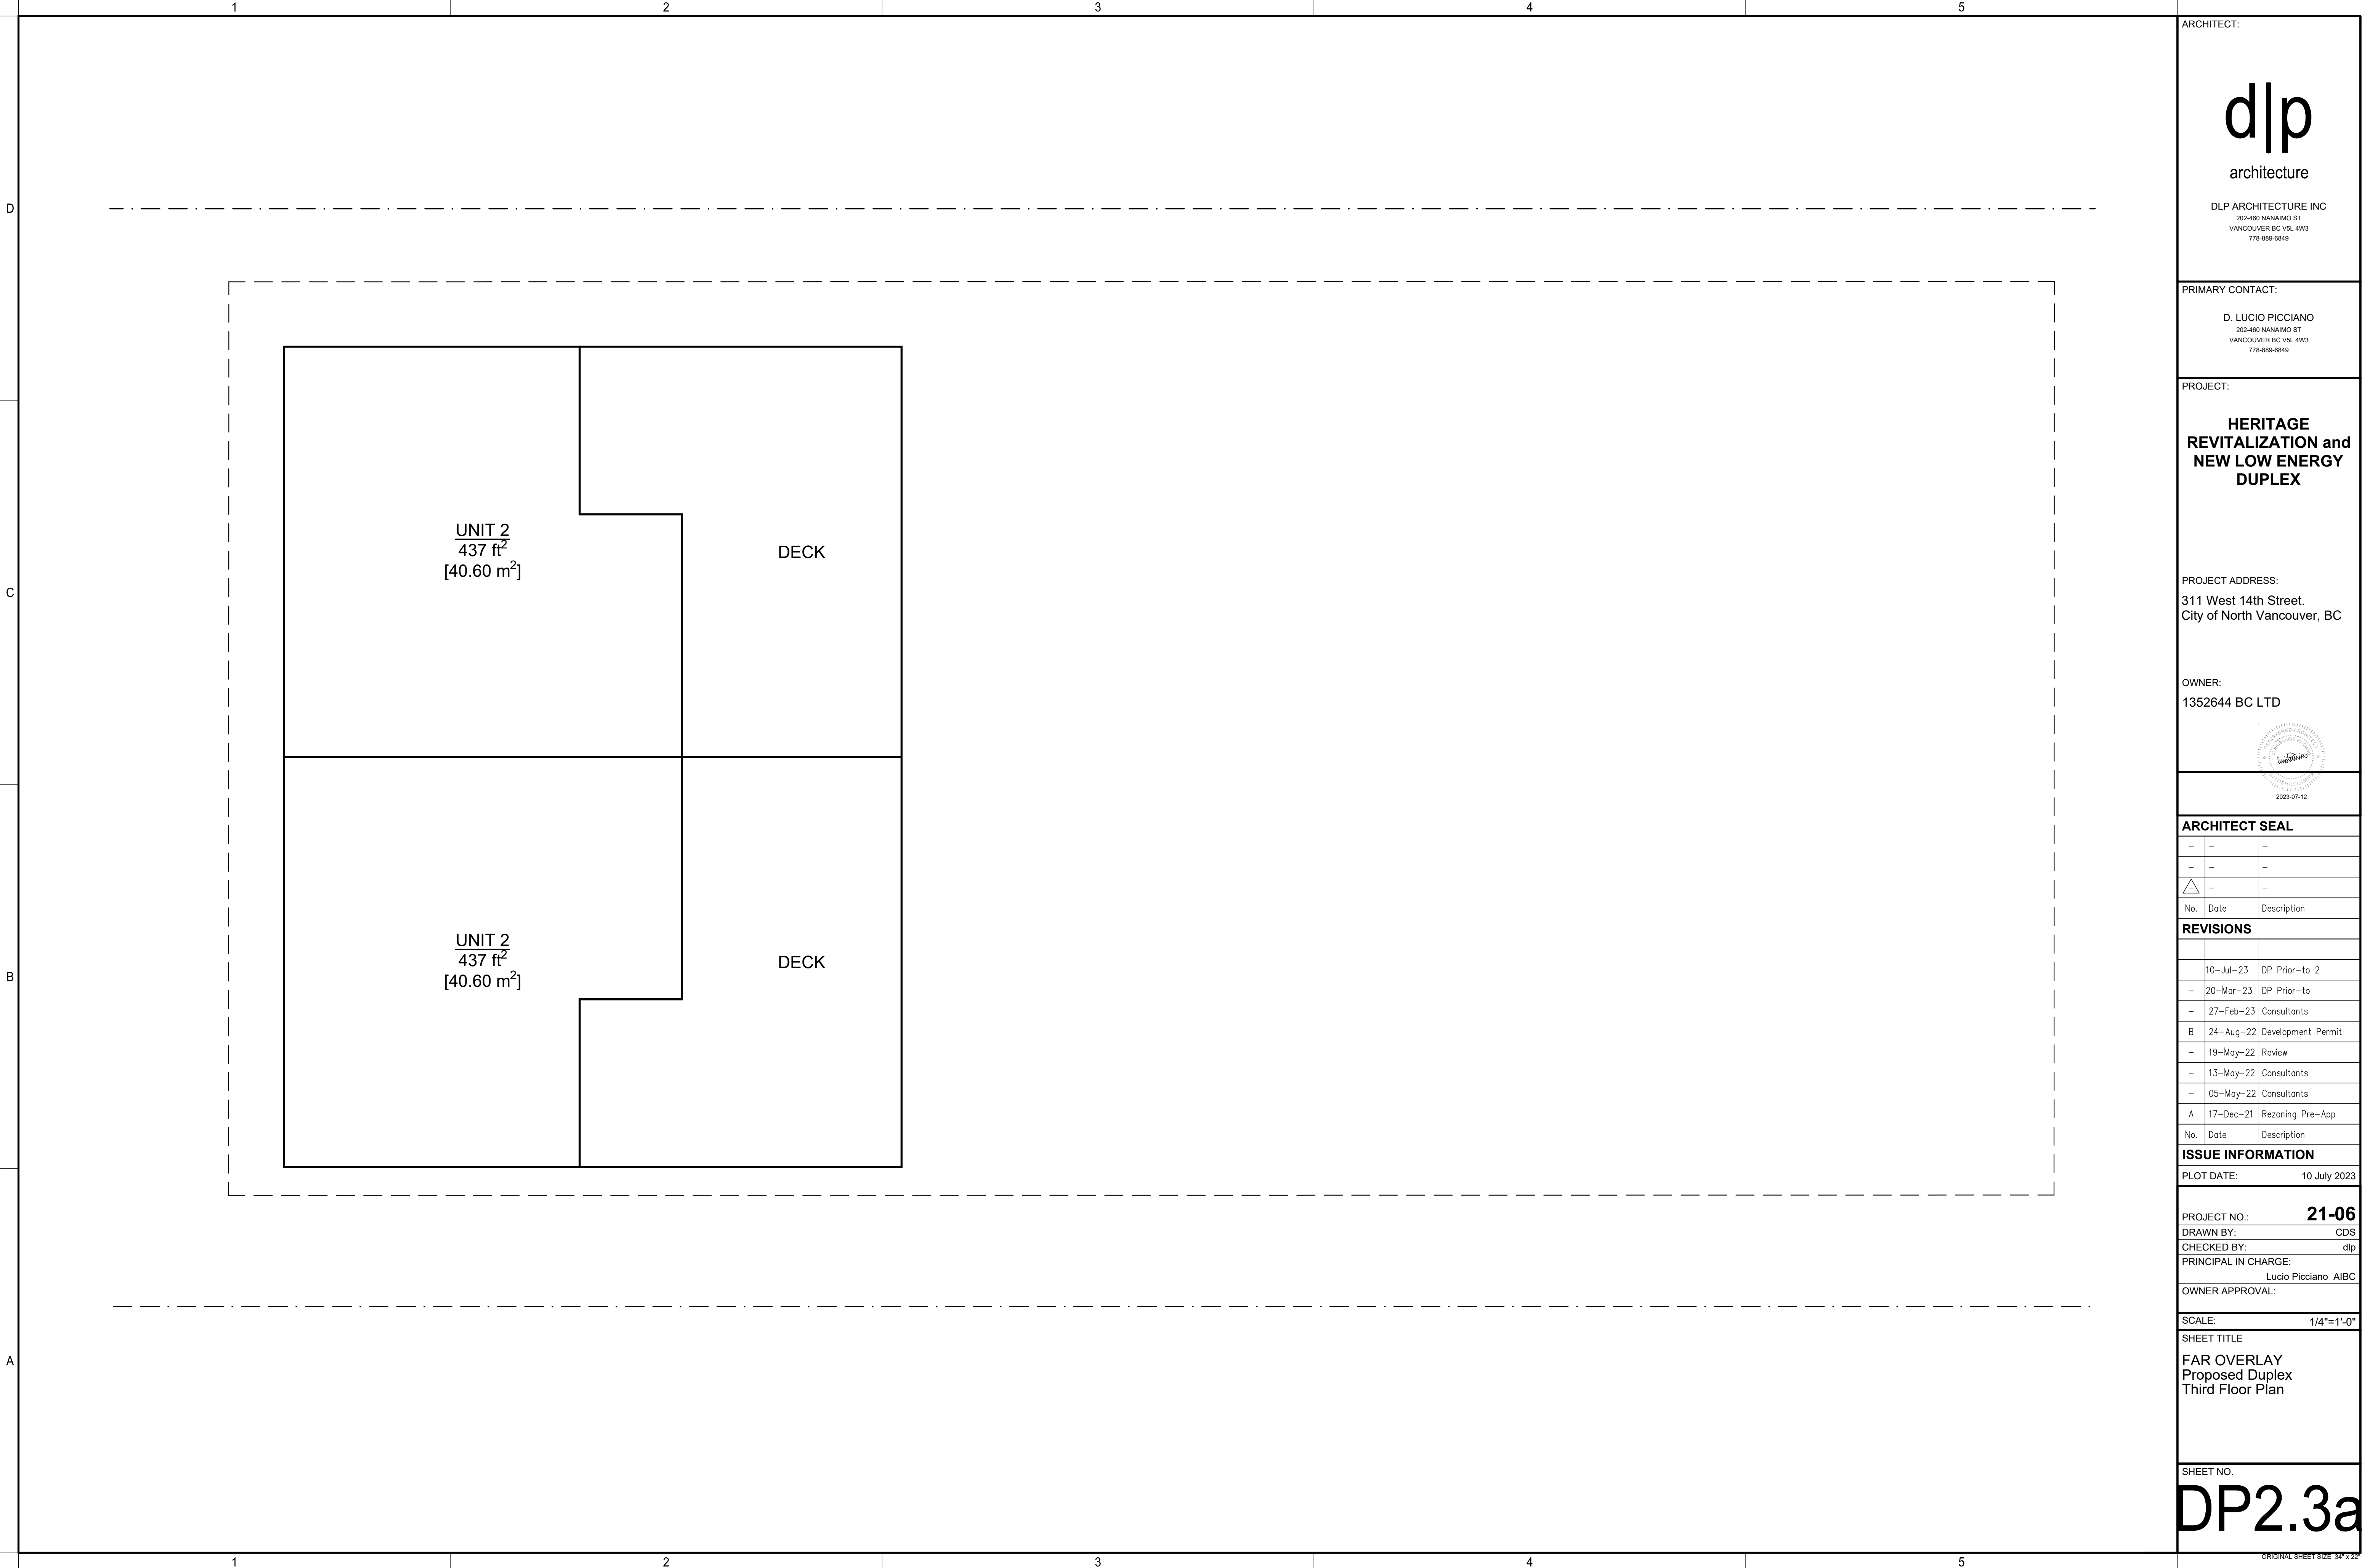

ARCHITECT:

dlp

architecture

DLP ARCHITECTURE INC
202-460 NANAIMO ST
VANCOUVER BC V6L 4W3
778-889-6849

PRIMARY CONTACT:


D. LUCIO PICCIANO
202-460 NANAIMO ST
VANCOUVER BC V6L 4W3
778-889-6849

PROJECT:


HERITAGE
REVITALIZATION and
NEW LOW ENERGY
DUPLEX

PROJECT ADDRESS:
311 West 14th Street.
City of North Vancouver, BC

OWNER:
1352644 BC LTD



ARCHITECT SEAL

-	-	-
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	-	-
No.	Date	Description

REVISIONS

	10-Jul-23	DP Prior-to 2
-	20-Mar-23	DP Prior-to
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-	19-May-22	Review
-	13-May-22	Consultants
-	05-May-22	Consultants
A	17-Dec-21	Rezoning Pre-App
No.	Date	Description

ISSUE INFORMATION

PLOT DATE:	10 July 2023
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PROJECT NO.:	21-06
DRAWN BY:	CDS
CHECKED BY:	dlp
PRINCIPAL IN CHARGE:	Lucio Picciano AIBC
OWNER APPROVAL:	

SCALE:	1/4"=1'-0"
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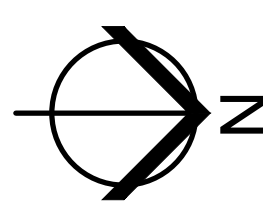
SHEET TITLE

FAR OVERLAY
Proposed Duplex
Third Floor Plan

SHEET NO.


DP2.3a

ORIGINAL SHEET SIZE 34" x 22"



DP2.4

2 Heritage House
Roof Plan
DP2.4 Scale - 1/4"=1'-0"

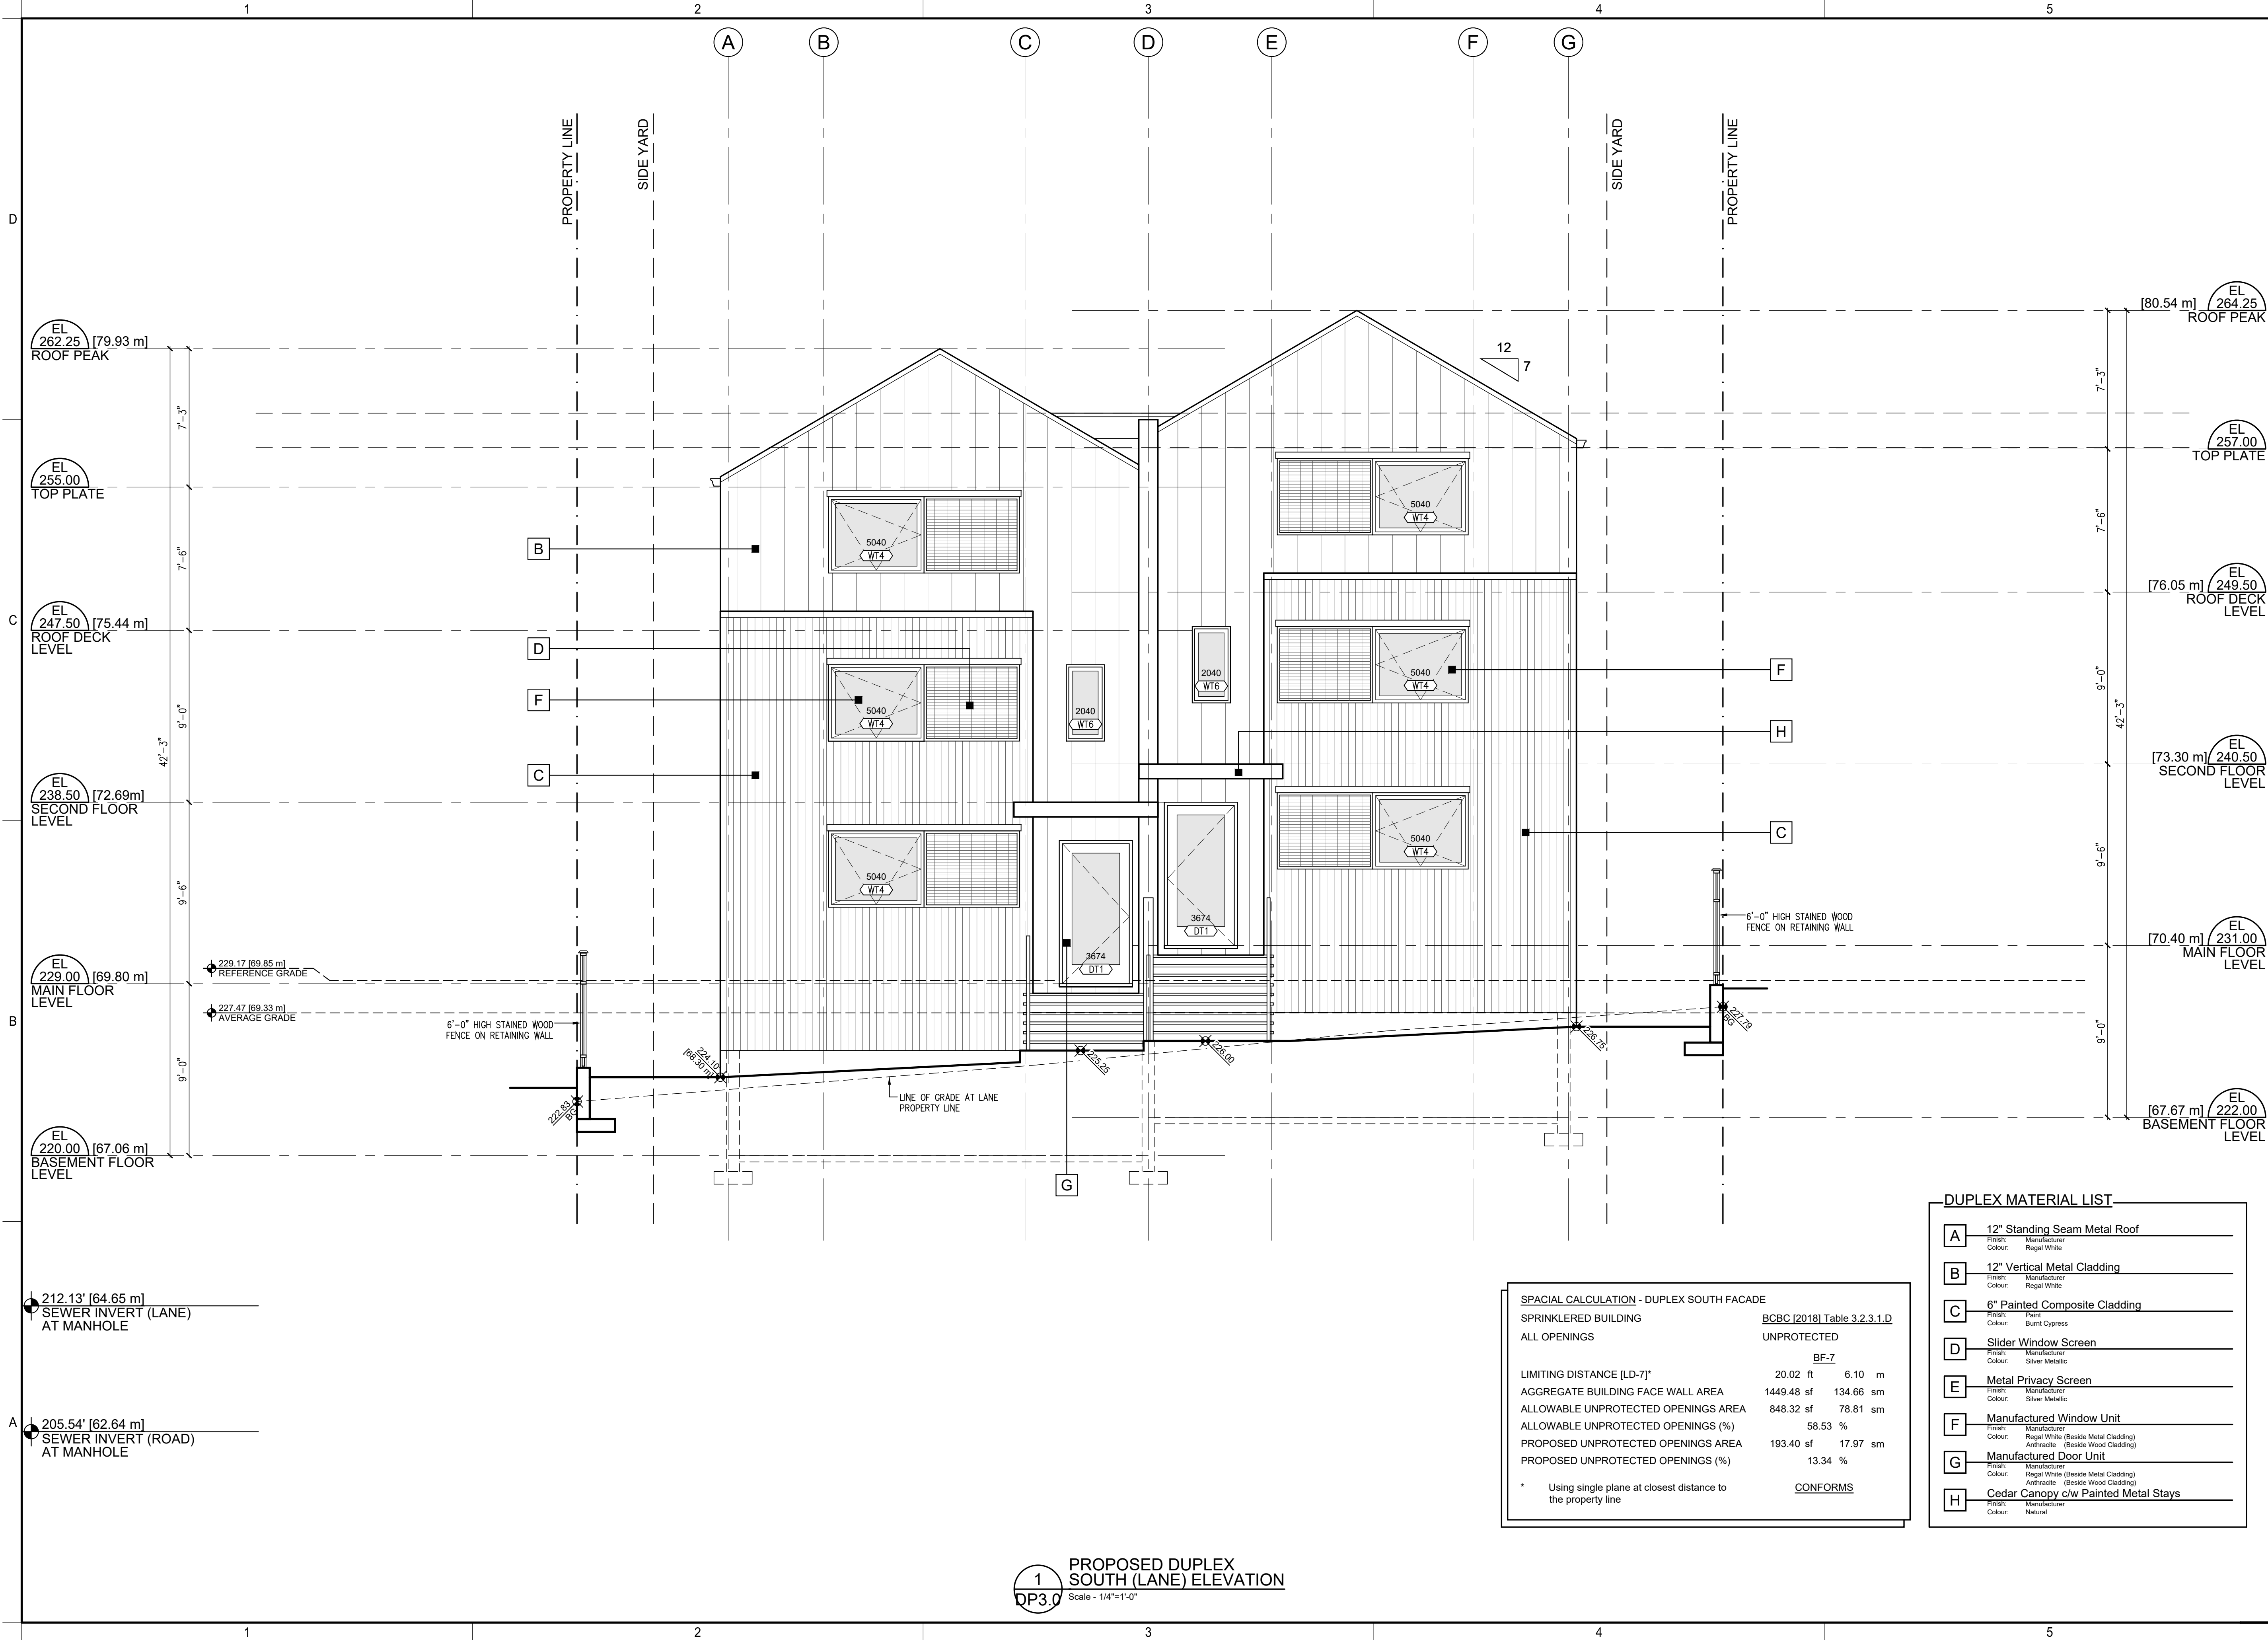

SPACIAL CALCULATION - DUPLEX SOUTH FACADE			
SPRINKLERED BUILDING	BCBC [2018] Table 3.2.3.1.D		
ALL OPENINGS	UNPROTECTED		
	BF-7		
LIMITING DISTANCE (LD-7)*	20.02 ft	6.10 m	
AGGREGATE BUILDING FACE WALL AREA	1449.48 sf	134.66 sm	
ALLOWABLE UNPROTECTED OPENINGS AREA	848.32 sf	78.81 sm	
ALLOWABLE UNPROTECTED OPENINGS (%)	58.53 %		
PROPOSED UNPROTECTED OPENINGS AREA	193.40 sf	17.97 sm	
PROPOSED UNPROTECTED OPENINGS (%)	13.34 %		
* Using single plane at closest distance to the property line			
CONFORMS			

DUPLEX MATERIAL LIST	
A	12" Standing Seam Metal Roof Finish: Manufacturer Colour: Regal White
B	12" Vertical Metal Cladding Finish: Manufacturer Colour: Regal White
C	6" Painted Composite Cladding Colour: Burnt Cypress
D	Slider Window Screen Finish: Manufacturer Colour: Silver Metallic
E	Metal Privacy Screen Finish: Manufacturer Colour: Silver Metallic
F	Manufactured Window Unit Finish: Manufacturer Colour: Regal White (Beside Metal Cladding) Antirattle (Beside Wood Cladding)
G	Manufactured Door Unit Finish: Manufacturer Colour: Regal White (Beside Metal Cladding) Antirattle (Beside Wood Cladding)
H	Cedar Canopy c/w Painted Metal Stays Finish: Manufacturer Colour: Natural

1
DP3.0
PROPOSED DUPLEX
SOUTH (LANE) ELEVATION
Scale - 1/4"=1'-0"

ARCHITECT:

dlp
architecture
DLP ARCHITECTURE INC
202-460 NANAIMO ST
VANCOUVER BC V6L 4W3
778-889-6849

PRIMARY CONTACT:

D. LUCIO PICCIANO
202-460 NANAIMO ST
VANCOUVER BC V6L 4W3
778-889-6849

PROJECT:

HERITAGE
REVITALIZATION and
NEW LOW ENERGY
DUPLEX

PROJECT ADDRESS:

311 West 14th Street.
City of North Vancouver, BC

OWNER:

1352644 BC LTD

ARCHITECT SEAL

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-	-	-
-	-	-

No. Date Description

REVISIONS

10-Jul-23	DP Prior-to 2	
20-Mar-23	DP Prior-to	
27-Feb-23	Consultants	
24-Aug-22	Development Permit	
19-May-22	Review	
13-May-22	Consultants	
05-May-22	Consultants	
17-Dec-21	Rezoning Pre-App	

No. Date Description

ISSUE INFORMATION

PLOT DATE: 10 July 2023

PROJECT NO.: 21-06

DRAWN BY: CDS

CHECKED BY: dlp

PRINCIPAL IN CHARGE: Lucio Picciano AIBC


OWNER APPROVAL:

SCALE: 1/4"=1'-0"

SHEET TITLE
Proposed Duplex
South Elevation

SHEET NO.
DP3.0

ORIGINAL SHEET SIZE 34" x 22"

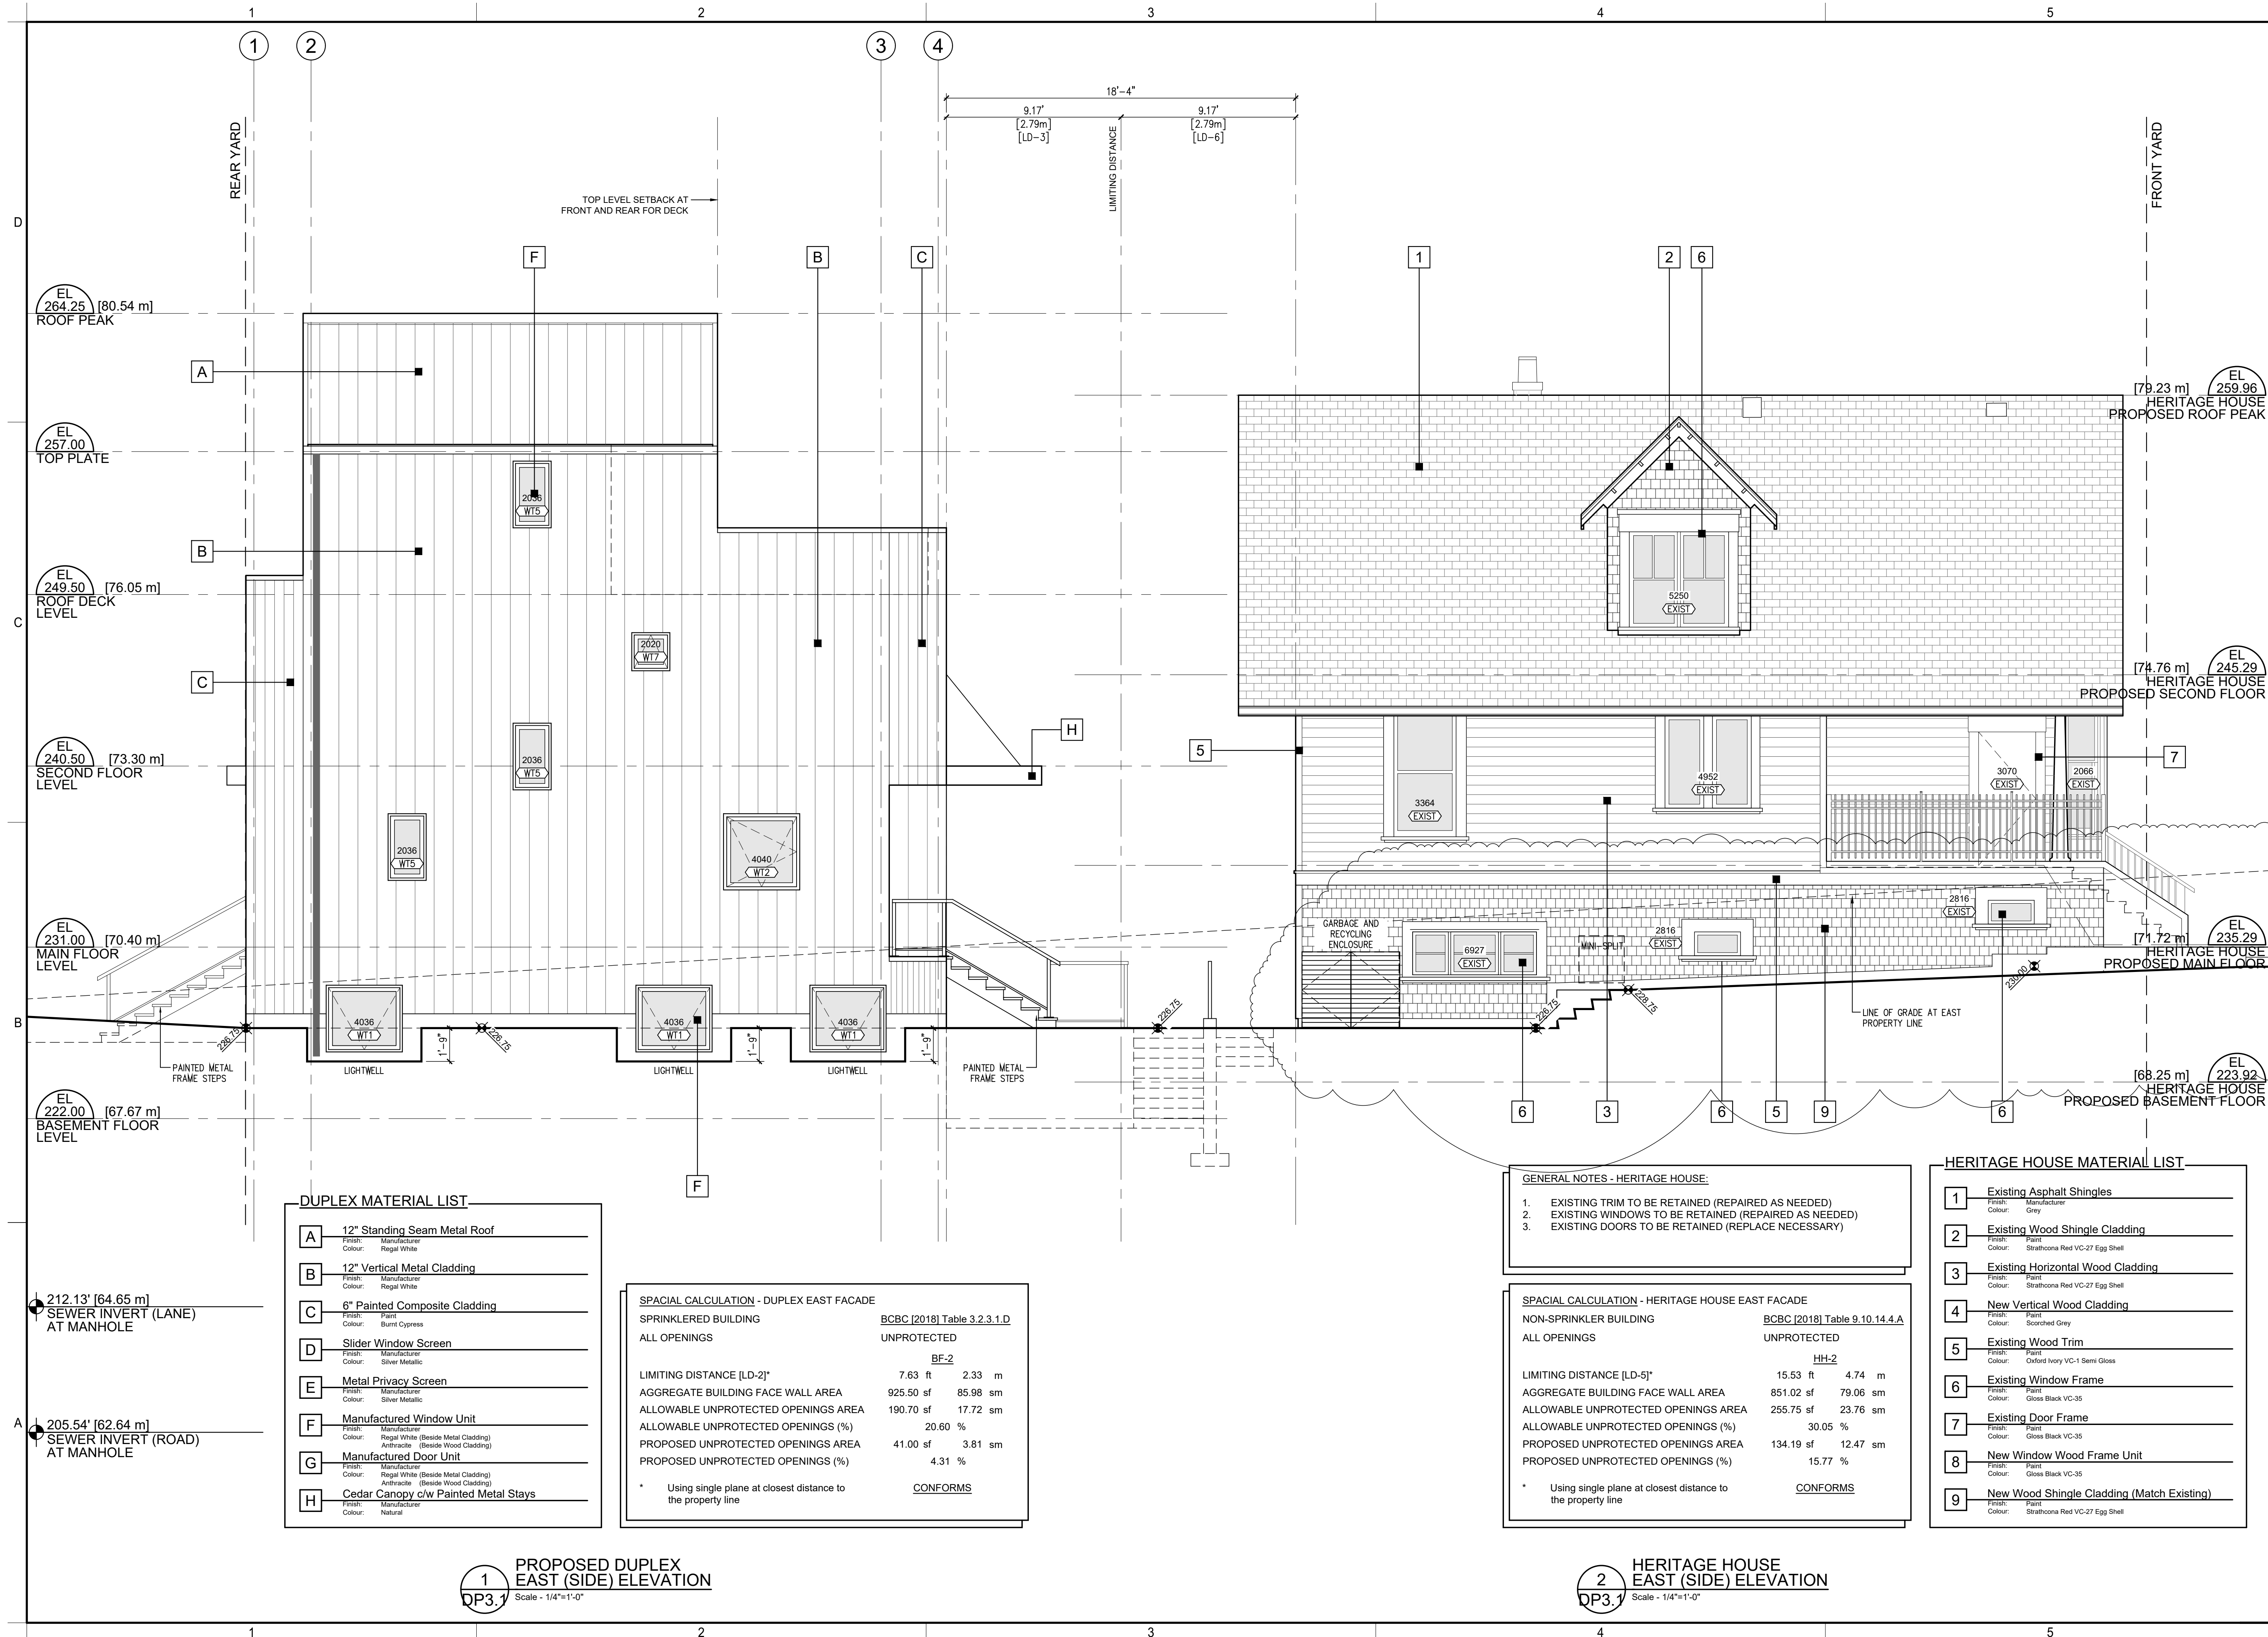

ARCHITECT:

d | p

architecture

DLP ARCHITECTURE INC
202-460 NANAIMO ST
VANCOUVER BC V5L 4W3
778-889-6849

PRIMARY CONTACT

D. LUCIO PICCIANO
202-460 NANAIMO ST
VANCOUVER BC V5L 4W3
778-889-6849

PROJECT:

HERITAGE REVITALIZATION and NEW LOW ENERGY DUPLEX

PROJECT ADDRESS:

311 West 14th Street.
City of North Vancouver, BC


OWNER

1352644 BC LTD



ARCHITECT SEAL

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No.	Date	Description

REVISIONS

	10-Jul-23	DP Prior-t
-	20-Mar-23	DP Prior-t
-	27-Feb-23	Consultants
B	24-Aug-22	Developmen
-	19-May-22	Review
-	13-May-22	Consultants
-	05-May-22	Consultants

No.	Date	Description
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ISSUE INFORMATION

PLOT DATE: 10 July 2023

PROJECT NO.: **21-06**

DRAWN BY: CDS

CHECKED BY: dlp

OWNER APPROVAL

SCALE: $1/4"=1'-0"$


SHEET TITLE

Proposed Duplex
East Elevation
Heritage House
East Elevation

SHEET NC

DP3.1


ORIGINAL SHEET SIZE 34" x 22"

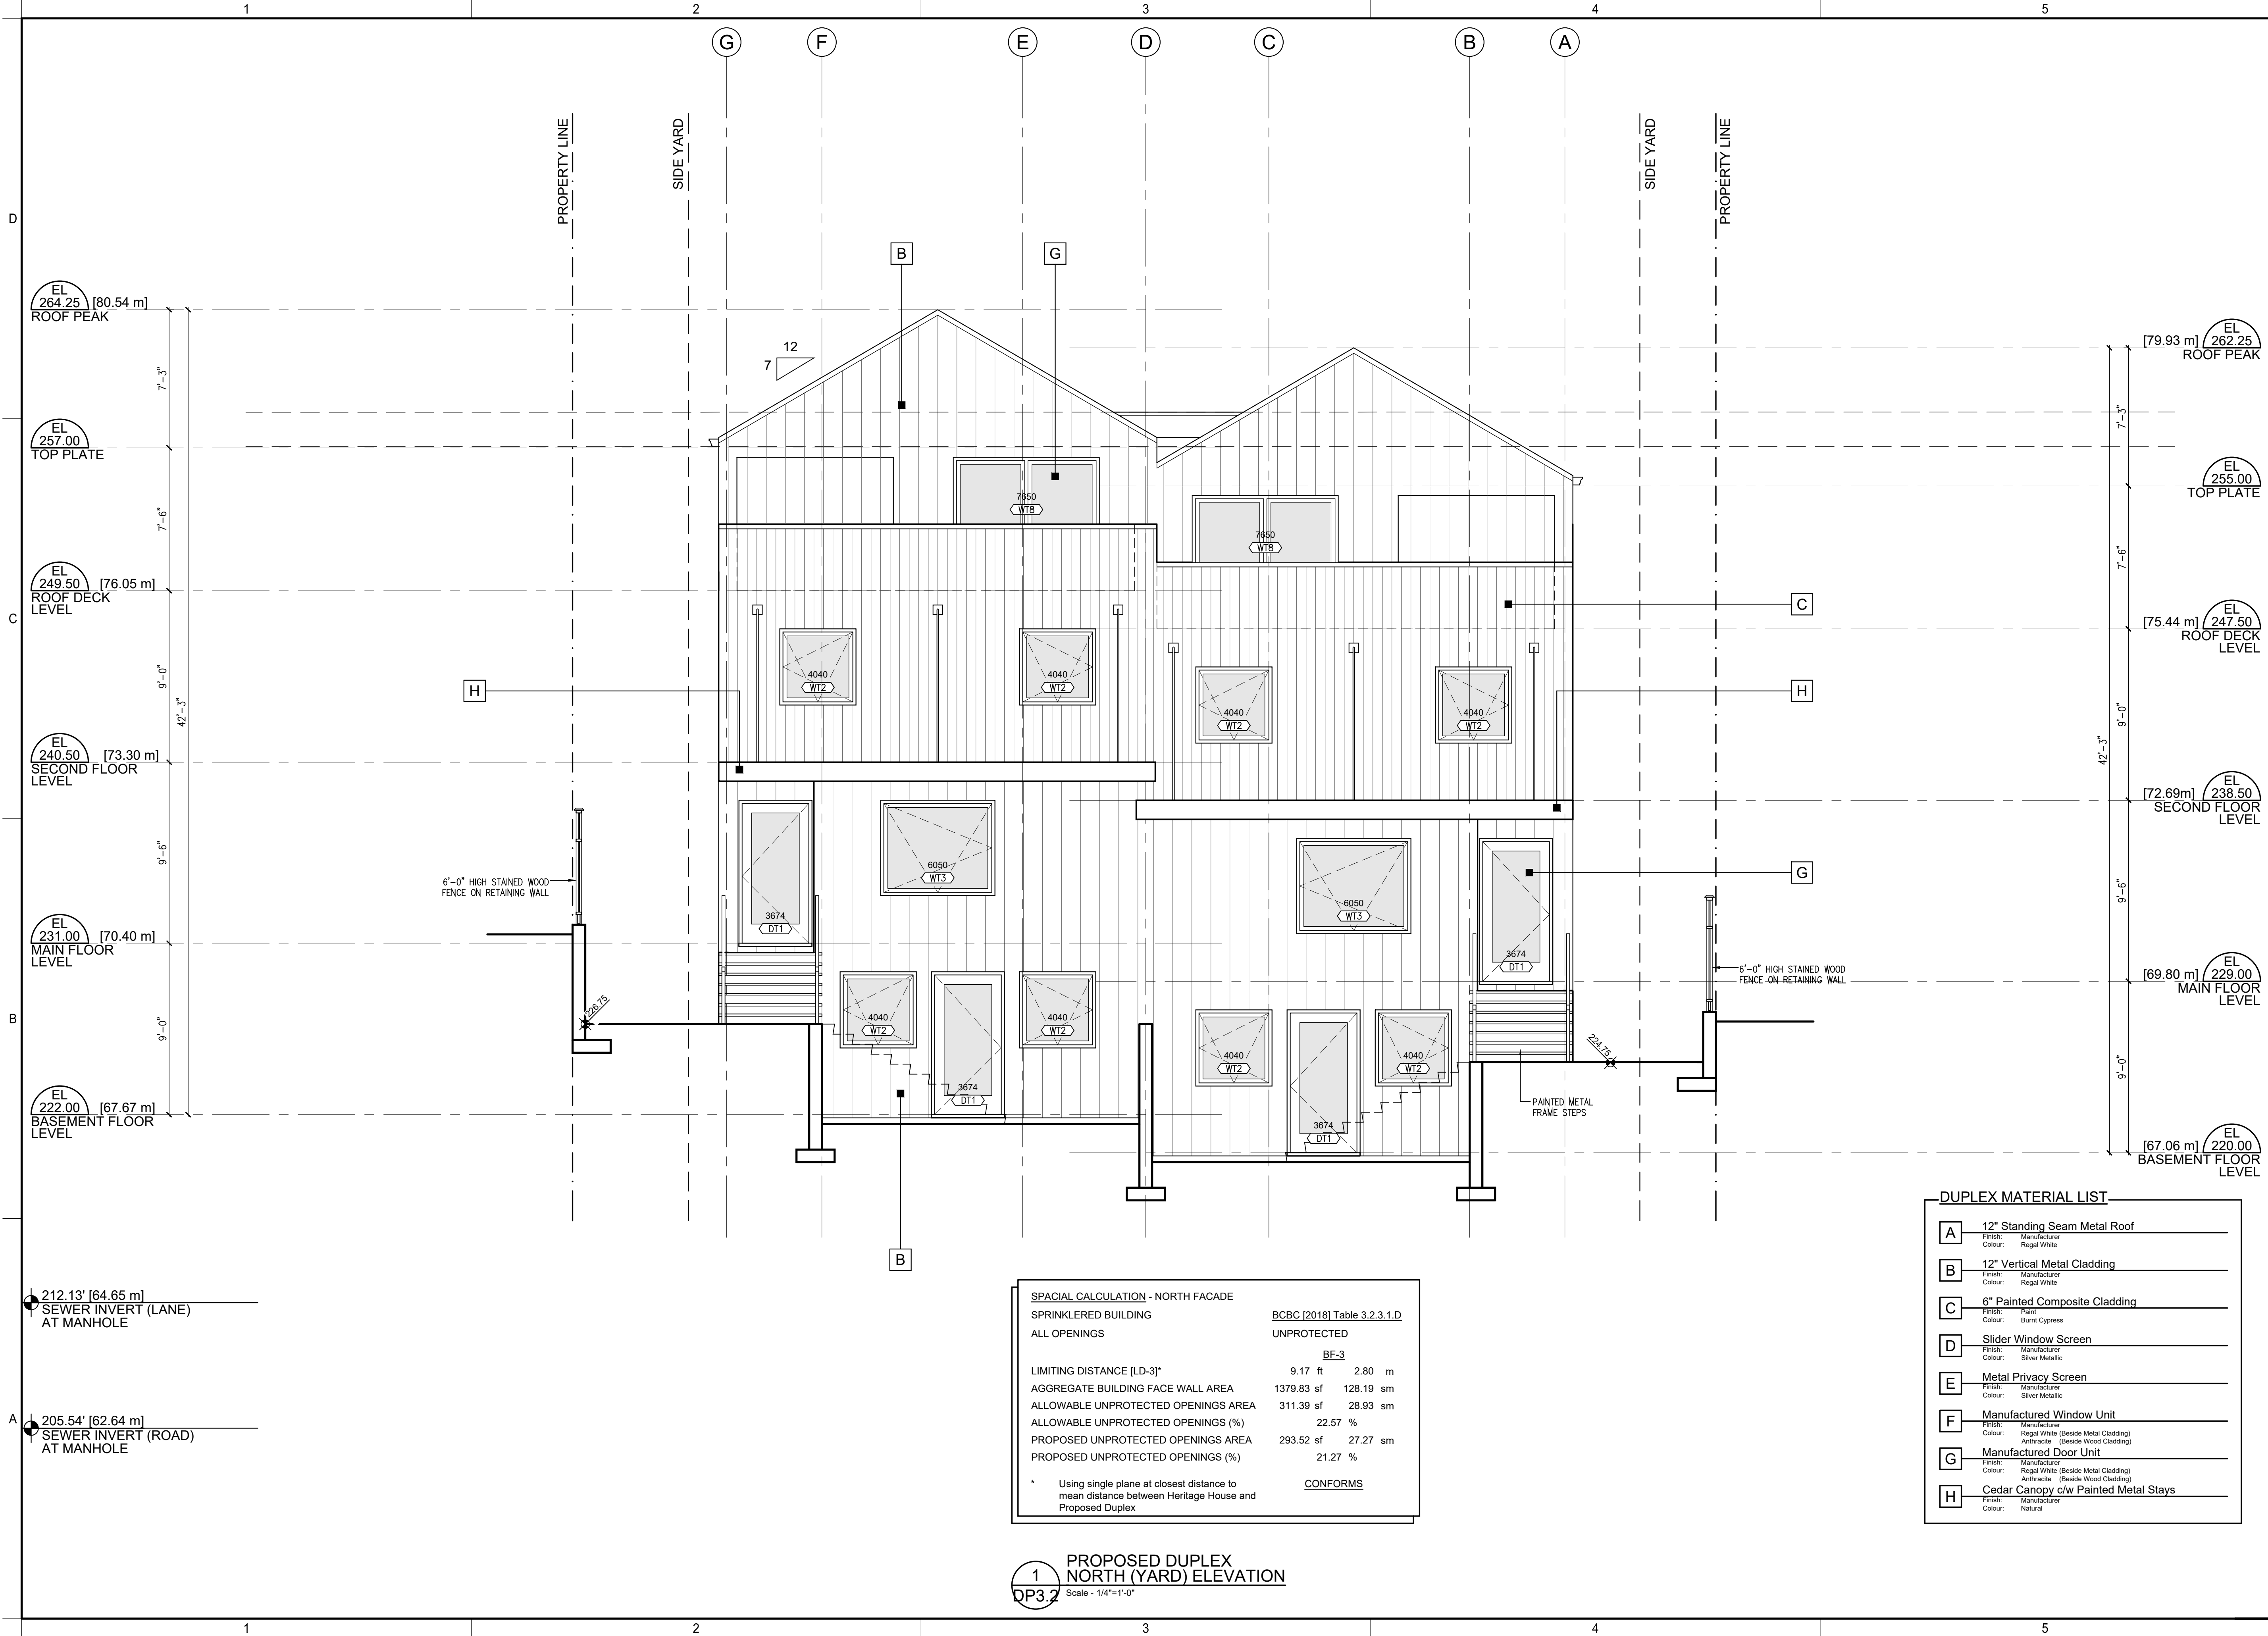

SPACIAL CALCULATION - NORTH FACADE			
SPRINKLERED BUILDING		BCBC [2018] Table 3.2.3.1.D	
ALL OPENINGS		UNPROTECTED	
		BF-3	
LIMITING DISTANCE [LD-3]*	9.17 ft	2.80 m	
AGGREGATE BUILDING FACE WALL AREA	1379.83 sf	128.19 sm	
ALLOWABLE UNPROTECTED OPENINGS AREA	311.39 sf	28.93 sm	
ALLOWABLE UNPROTECTED OPENINGS (%)	22.57 %		
PROPOSED UNPROTECTED OPENINGS AREA	293.52 sf	27.27 sm	
PROPOSED UNPROTECTED OPENINGS (%)	21.27 %		
* Using single plane at closest distance to mean distance between Heritage House and Proposed Duplex		CONFORMS	

DUPLEX MATERIAL LIST	
A	12" Standing Seam Metal Roof Finish: Manufacturer Colour: Regal White
B	12" Vertical Metal Cladding Finish: Manufacturer Colour: Regal White
C	6" Painted Composite Cladding Finish: Paint Colour: Burnt Cypress
D	Slider Window Screen Finish: Manufacturer Colour: Silver Metallic
E	Metal Privacy Screen Finish: Manufacturer Colour: Silver Metallic
F	Manufactured Window Unit Finish: Manufacturer Colour: Regal White (Beside Metal Cladding) Antracite (Beside Wood Cladding)
G	Manufactured Door Unit Finish: Manufacturer Colour: Regal White (Beside Metal Cladding) Antracite (Beside Wood Cladding)
H	Cedar Canopy c/w Painted Metal Stays Finish: Manufacturer Colour: Natural

ARCHITECT:



architecture

DLP ARCHITECTURE INC
202-460 NANAIMO ST
VANCOUVER BC V6L 4W3
778-889-6849

PRIMARY CONTACT:

D. LUCIO PICCIANO
202-460 NANAIMO ST
VANCOUVER BC V6L 4W3
778-889-6849

PROJECT:


**HERITAGE
REVITALIZATION and
NEW LOW ENERGY
DUPLEX**

PROJECT ADDRESS:

311 West 14th Street.
City of North Vancouver, BC

OWNER:

1352644 BC LTD



2023-07-12

ARCHITECT SEAL

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-	-	-
No.	Date	Description

REVISIONS

-	10-Jul-23	DP Prior-to 2
-	20-Mar-23	DP Prior-to
-	27-Feb-23	Consultants
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-	13-May-22	Consultants
-	05-May-22	Consultants
A	17-Dec-21	Rezoning Pre-App
No.	Date	Description

ISSUE INFORMATION

PLOT DATE:	10 July 2023
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PROJECT NO.: **21-06**
DRAWN BY: CDS
CHECKED BY: dlp
PRINCIPAL IN CHARGE: Lucio Picciano AIBC

OWNER APPROVAL:

SCALE: 1/4"=1'-0"


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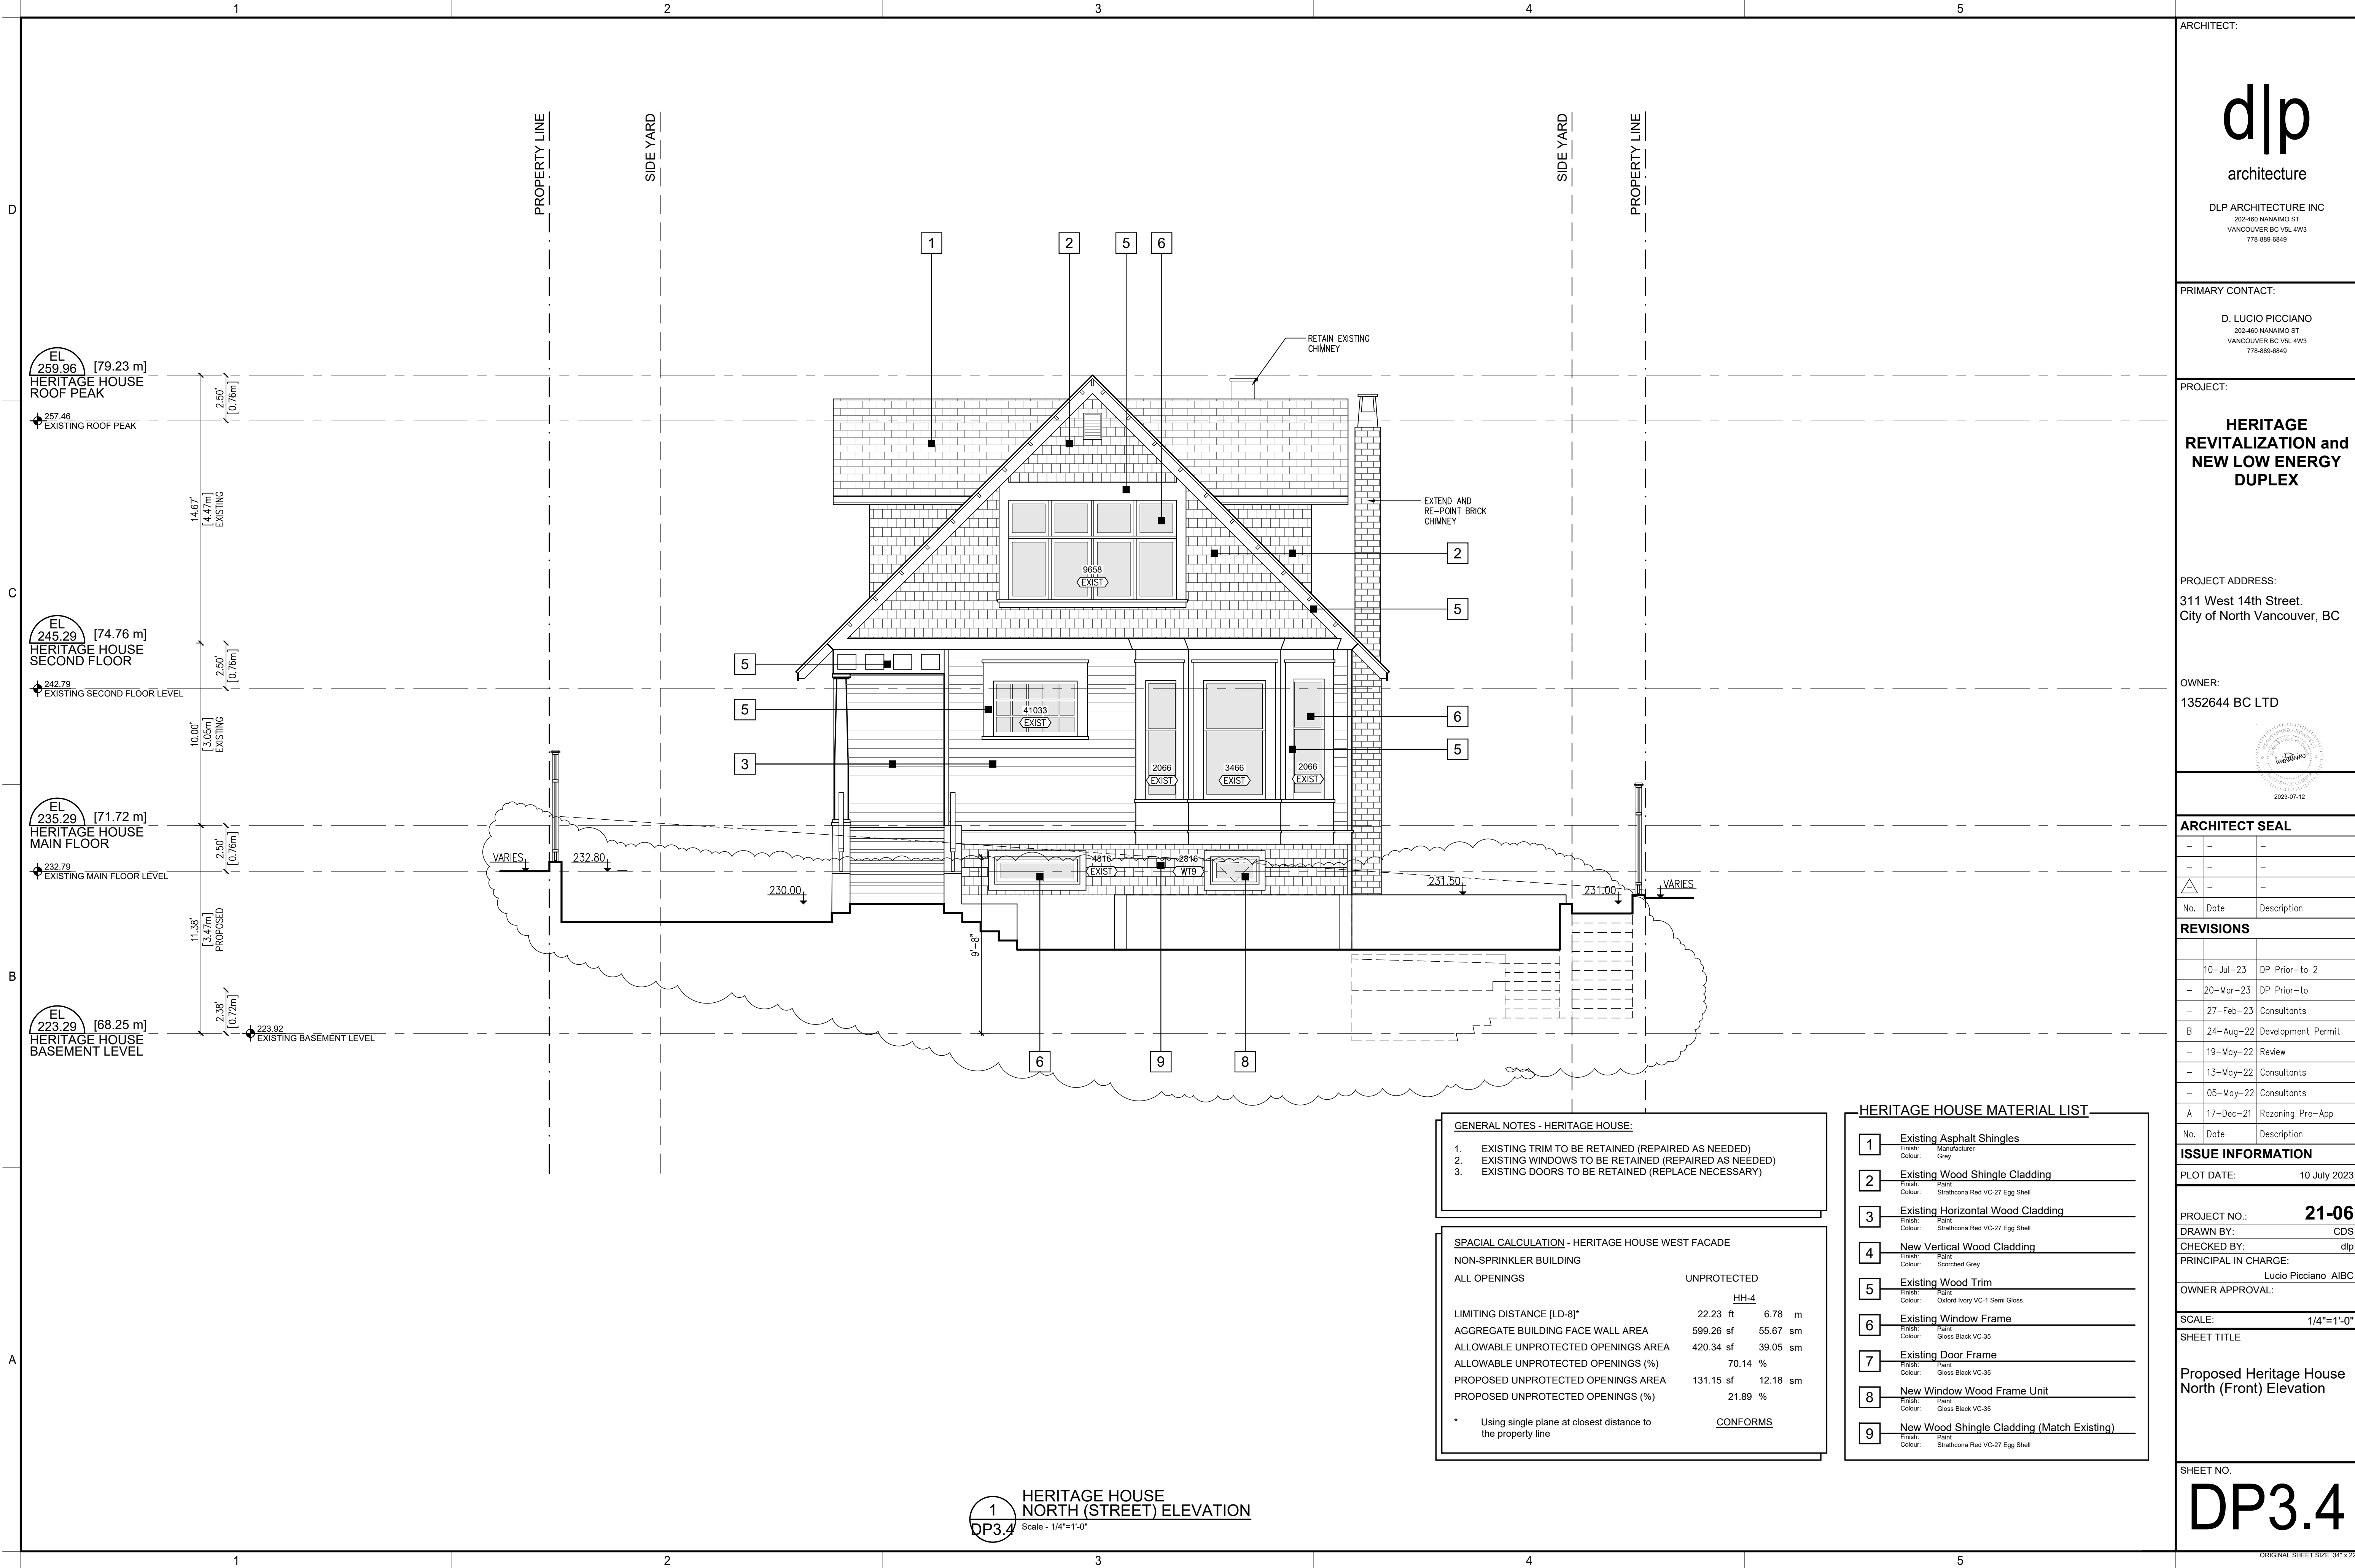
Proposed Duplex
North Elevation

SHEET NO.

DP3.2

ORIGINAL SHEET SIZE 34" x 22"



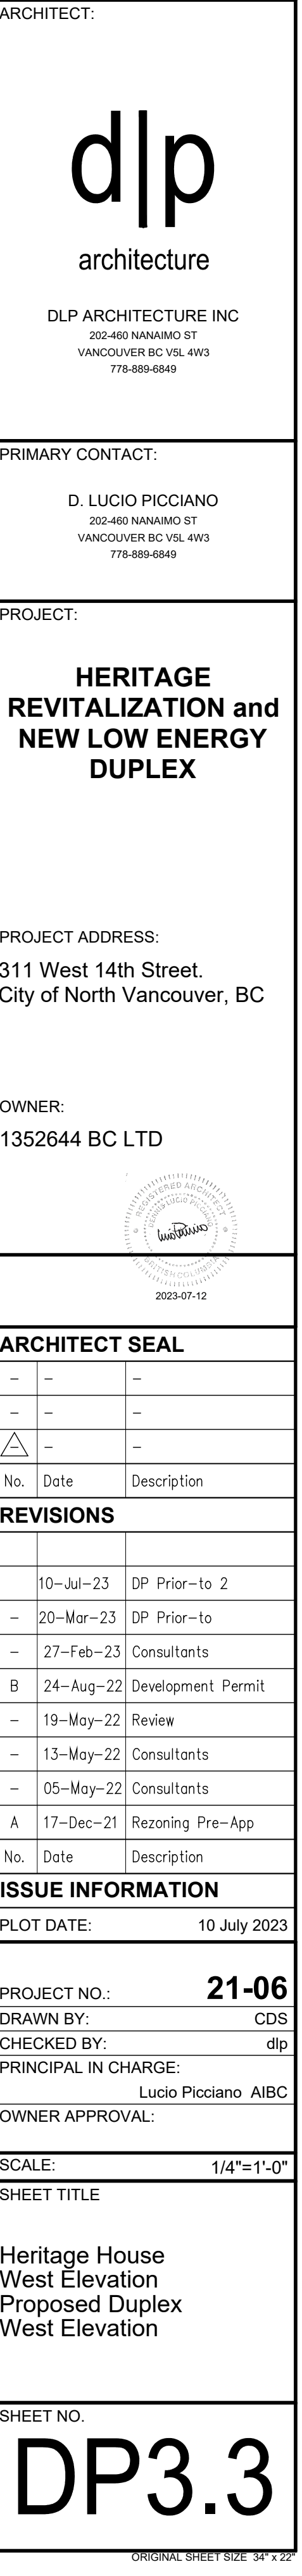

ARCHITECT:

dlp

architecture

DLP ARCHITECTURE INC
202-460 NANAIMO ST
VANCOUVER BC V6L 4W3
778-889-6849

PRIMARY CONTACT:

D. LUCIO PICCIANO
202-460 NANAIMO ST
VANCOUVER BC V6L 4W3
778-889-6849

PROJECT:


**HERITAGE
REVITALIZATION and
NEW LOW ENERGY
DUPLEX**

PROJECT ADDRESS:

311 West 14th Street.
City of North Vancouver, BC

OWNER:

1352644 BC LTD

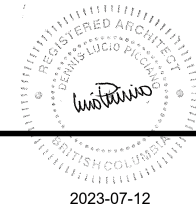

ARCHITECT SEAL

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-	-	-
-	-	-

No. Date Description

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No. Date Description

ISSUE INFORMATION

PLOT DATE: 10 July 2023

PROJECT NO.: 21-06

DRAWN BY: CDS

CHECKED BY: dlp

PRINCIPAL IN CHARGE: Lucio Picciano AIBC

OWNER APPROVAL:

SCALE: 1/4"=1'-0"


SHEET TITLE

Proposed Heritage House
North (Front) Elevation

SHEET NO.

DP3.4

ORIGINAL SHEET SIZE 34" x 22"

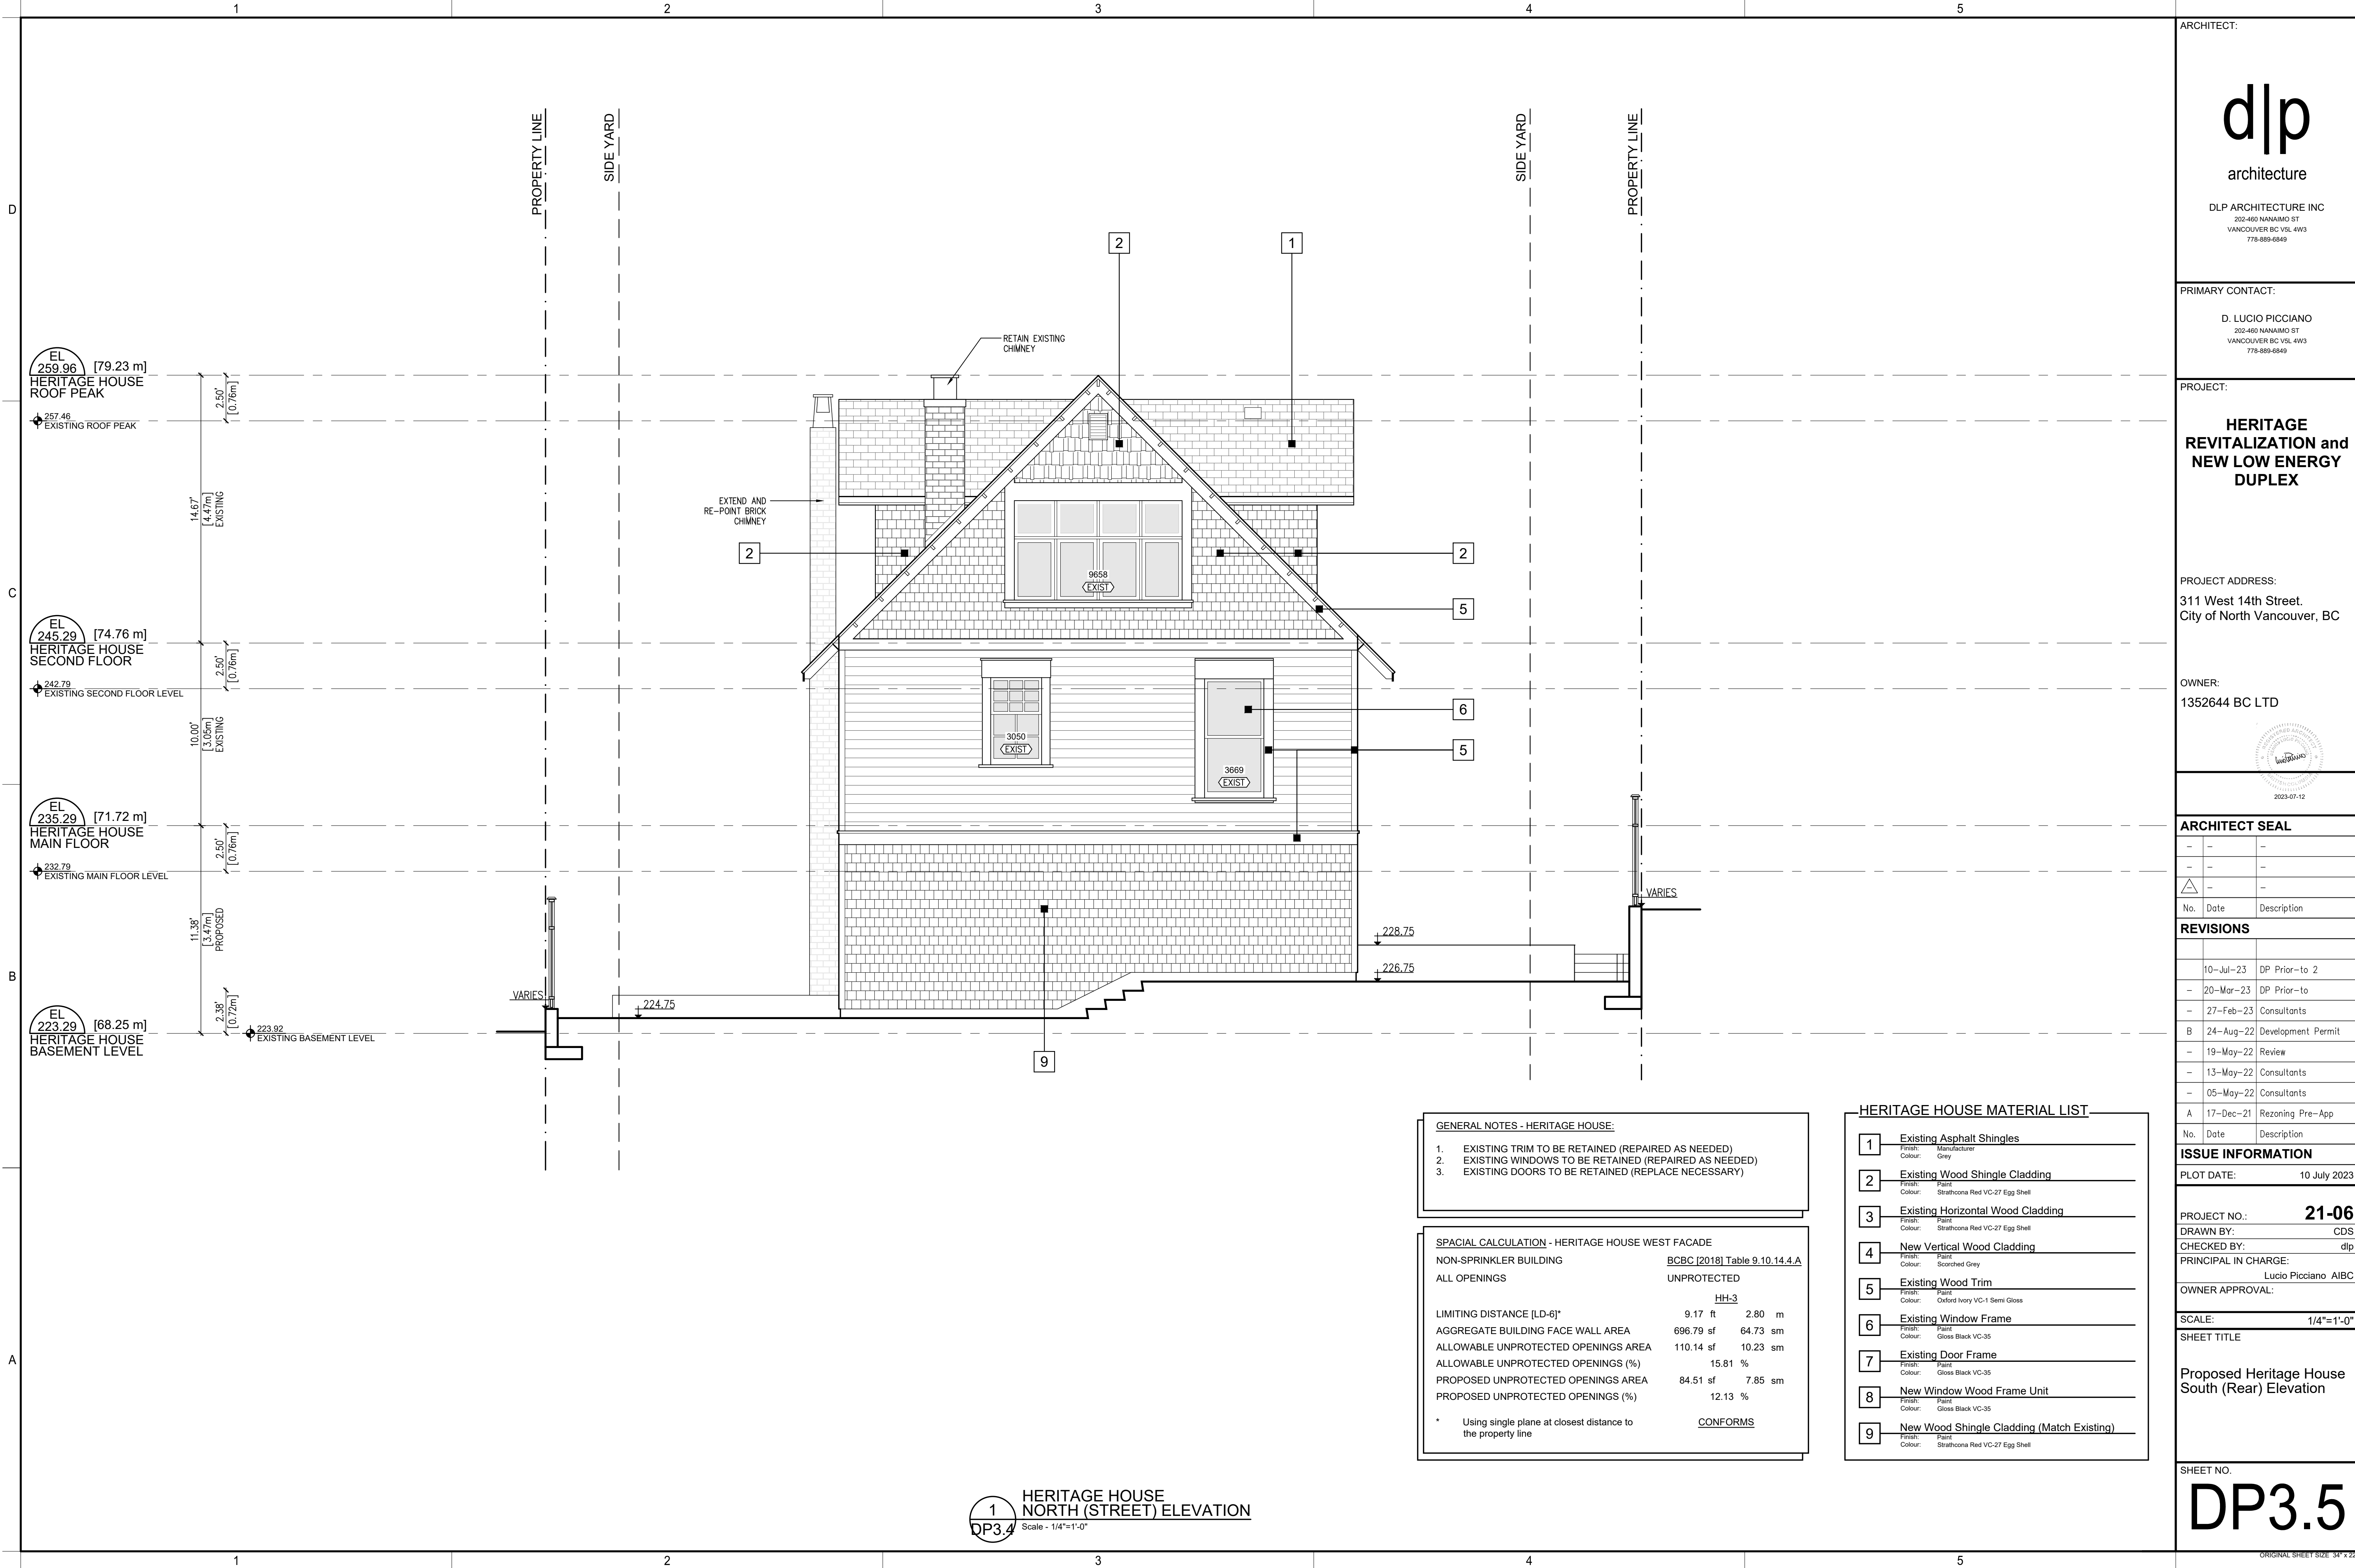

ARCHITECT:

dlp
architecture

DLP ARCHITECTURE INC
202-460 NANAIMO ST
VANCOUVER BC V6L 4W3
778-889-6849

PRIMARY CONTACT:

D. LUCIO PICCIANO
202-460 NANAIMO ST
VANCOUVER BC V6L 4W3
778-889-6849

PROJECT:


HERITAGE
REVITALIZATION and
NEW LOW ENERGY
DUPLEX

PROJECT ADDRESS:

311 West 14th Street.
City of North Vancouver, BC

OWNER:

1352644 BC LTD

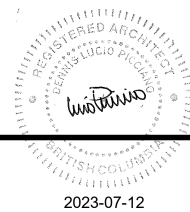

ARCHITECT SEAL

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-	-	-
-	-	-

REVISIONS

No.	Date	Description
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No. Date Description

ISSUE INFORMATION

PLOT DATE: 10 July 2023

PROJECT NO.: 21-06

DRAWN BY: CDS

CHECKED BY: dlp

PRINCIPAL IN CHARGE: Lucio Picciano AIBC

OWNER APPROVAL:

SCALE: 1/4"=1'-0"


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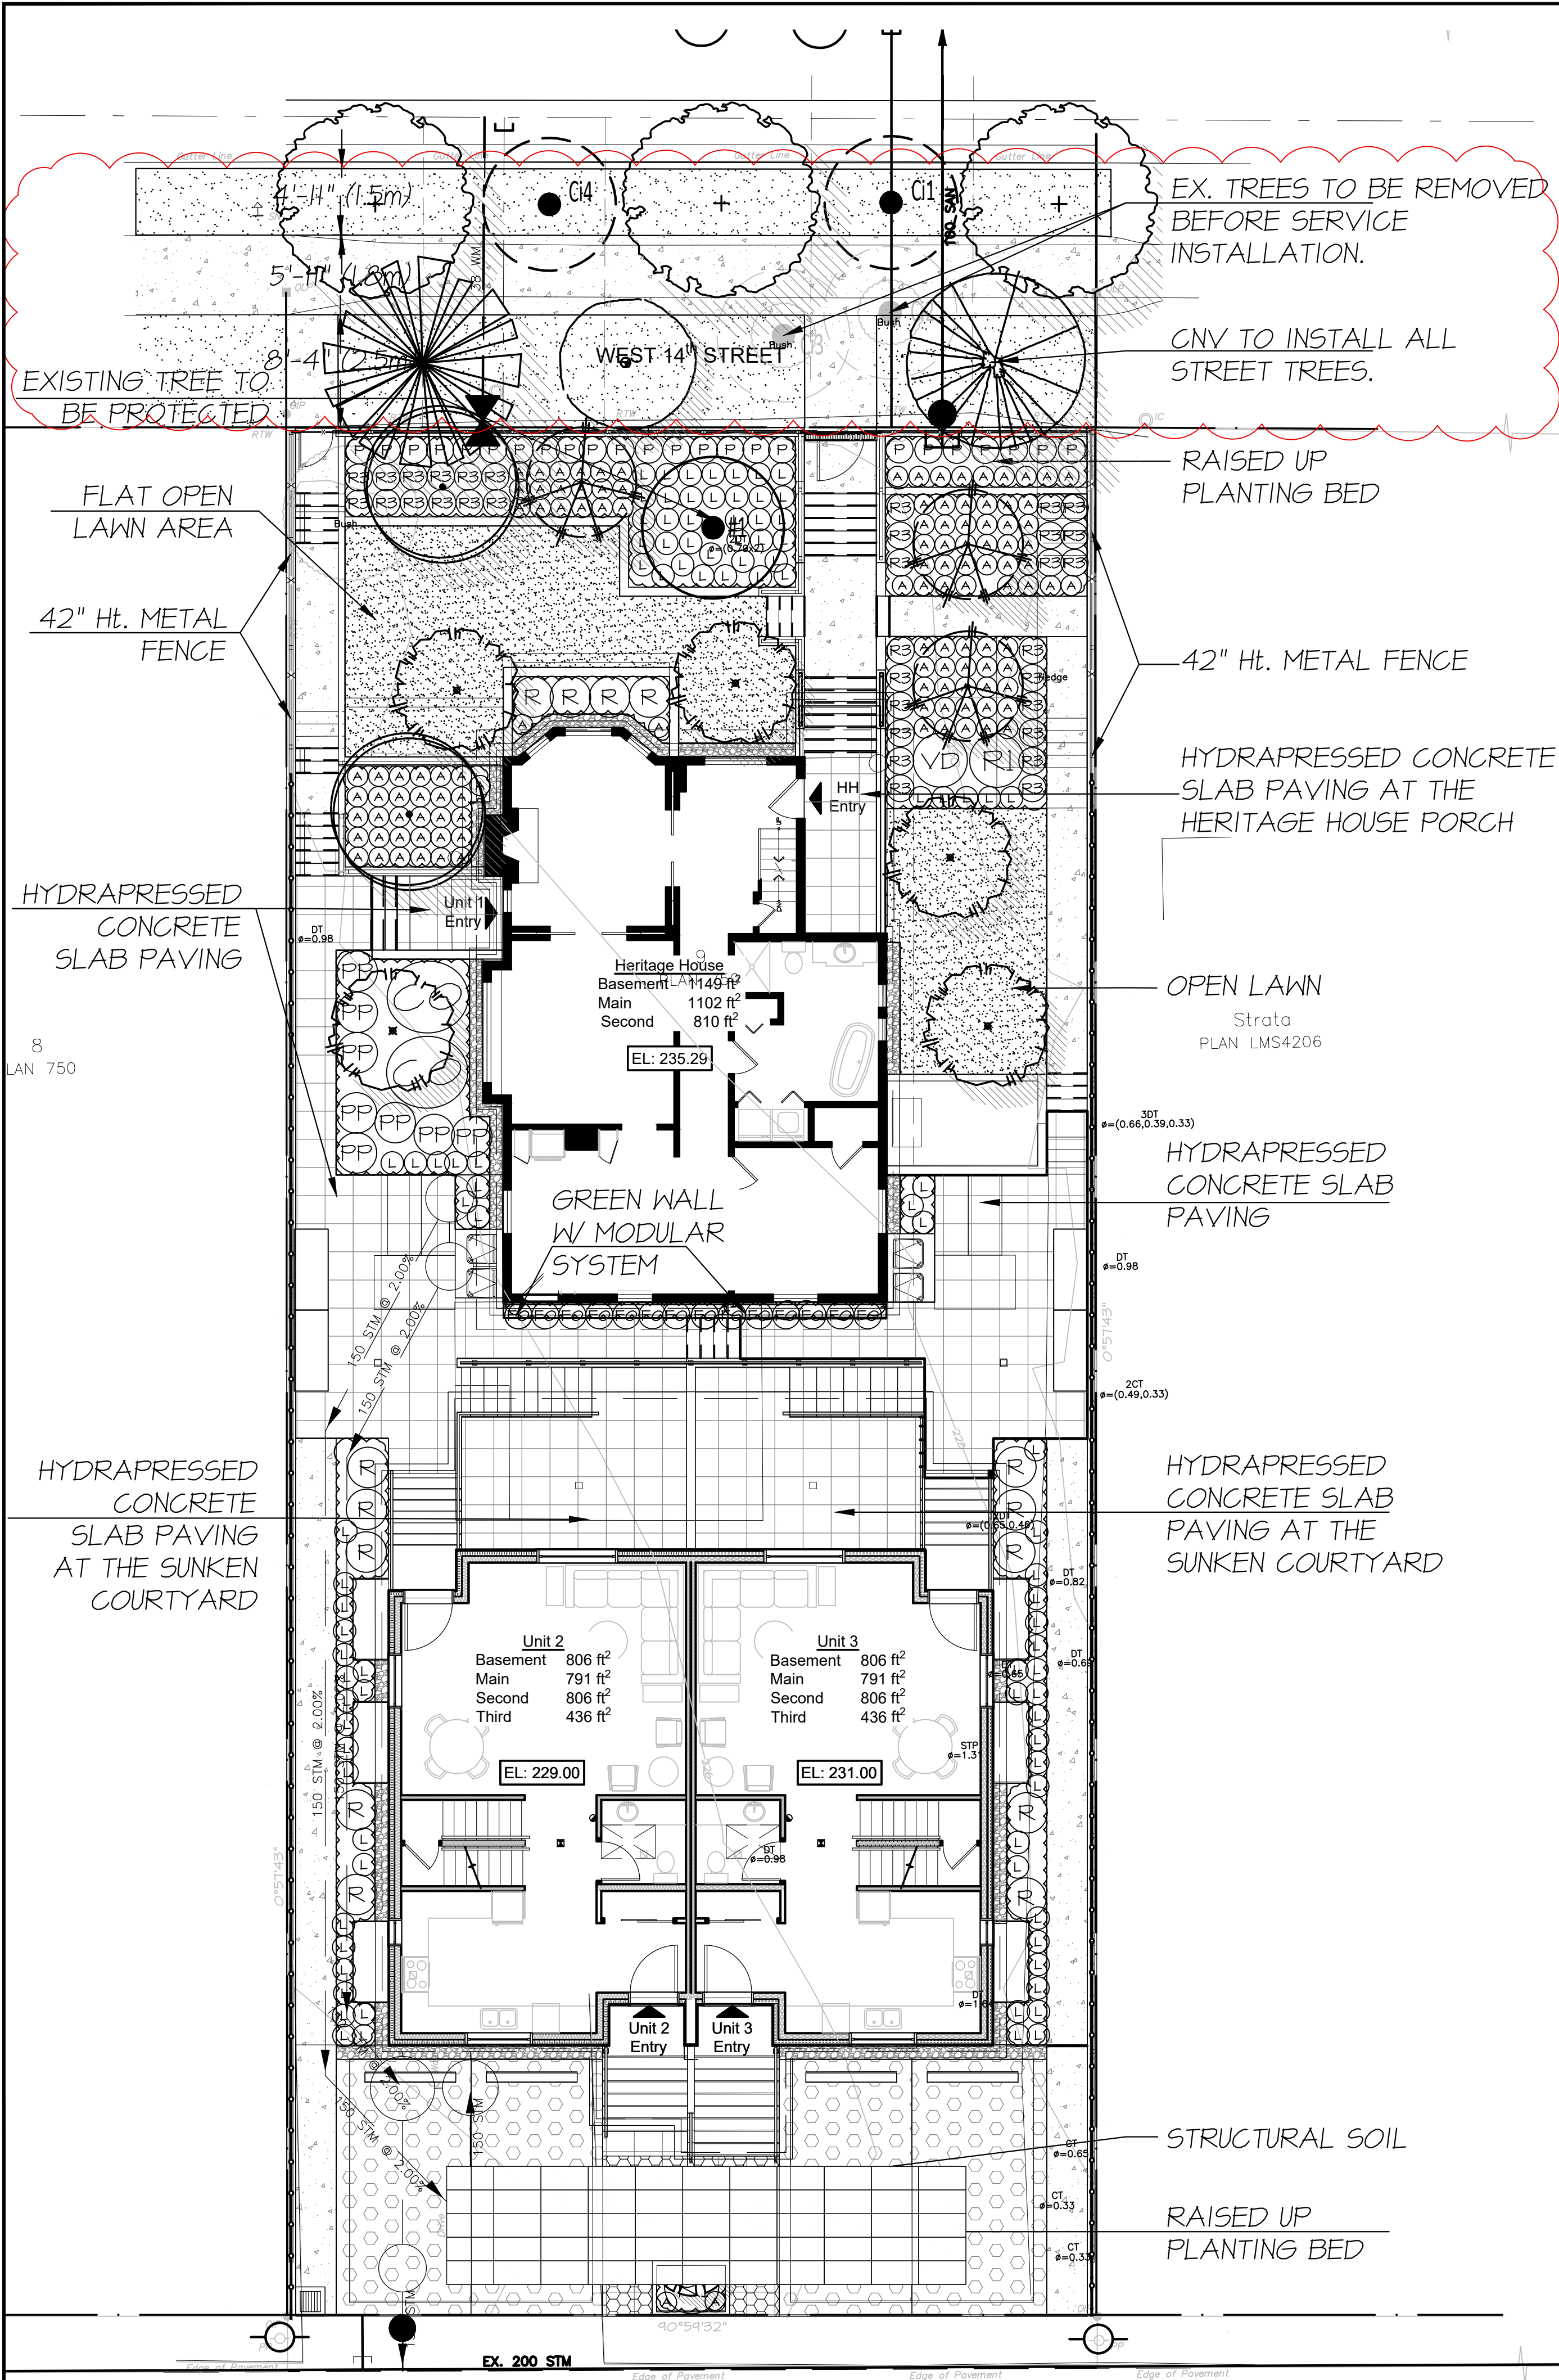
Proposed Heritage House
South (Rear) Elevation

SHEET NO.

DP3.5

ORIGINAL SHEET SIZE 34" x 22"



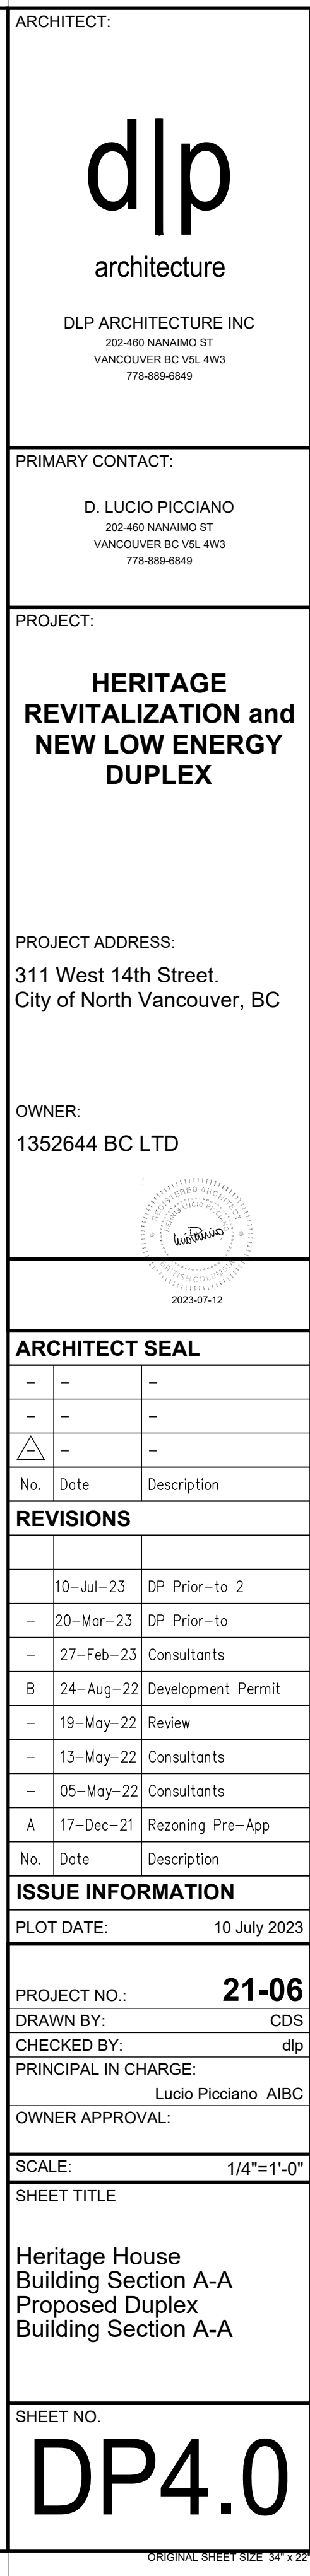

LEGEND

	GRAVEL BED		5' Ht. PERIMETER FENCE
	SCORE CUT CONCRETE		42" Ht. METAL FENCE & GATE
	2'X2' HYDRAPRESSED PAVER		TURFSTONE
	SOD/LAWN		SOFTSCAPE PLANTING AREA
			STRUCTURAL SOIL

PLANT SCHEDULE - ONSITE

M2 JOB NUMBER: 22-030

KEY	QTY	BOTANICAL NAME	COMMON NAME	PLANTED SIZE / REMARKS
TREE				
	2	ACER RUBRUM 'BOWHALL'	COLUMNAR BOWHALL MAPLE	6CM CAL; B&B
	3	CHAMAECYPARIS OBTUSA 'GRACILIS'	SLENDER HINOKI CYPRESS	3M HT; B&B
	1	CORNUS KOUSA 'SATOMI'	SATOMI DOGWOOD	2.5M HT; B&B
	5	LIQUIDAMBAR STYRACIFLUA 'SLENDER SILHOUETTE'	SLENDER SILHOUETTE SWEET GUM	6CM CAL; B&B
	1	EXISTING TREE #1 TO BE PROTECTED		
SHRUB				
	2	CORNUS SERICEA	RED OSIER DOGWOOD	#2 POT; 50CM
	16	GAULTHERIA SHALLON	SALAL	#2 POT; 30CM
	8	PHYSOCARPUS OPULIFOLIUS CAPITATUS	PACIFIC NINEBARK	#2 POT
	3	RHODODENDRON YAK 'MIST MAIDEN'	RHODODENDRON 'MIST MAIDEN'	#2 POT; 30CM
	1	VIBURNUM DAVIDII	DAVID'S VIBURNUM	#2 POT; 30CM
GRASS				
	24	PENNISETUM ALOPECUROIDES	FOUNTAIN GRASS	#1 POT
VINE				
	16	CLEMATIS ALPINA 'RUBY'	CLEMATIS 'RUBY'	#1 POT; 50CM STAKED
PERENNIAL				
	48	LAVENDULA ANGUSTIFOLIA	ENGLISH LAVENDER	#1 POT
	33	RUDBECKIA FULGIDA VAR SULLIVANTII 'GOLDSTURM'	RUDBECKIA	#1 POT
GC				
	107	ADIANTUM PEDATUM	MAIDENHAIR FERN	#2 POT; 35CM


NOTES: * PLANT SIZES IN THIS LIST ARE SPECIFIED ACCORDING TO THE BC LANDSCAPE STANDARD, LATEST EDITION. CONTAINER SIZES SPECIFIED AS PER CNTA STANDARDS. BOTH PLANT SIZE AND CONTAINER SIZE ARE THE MINIMUM ACCEPTABLE SIZES. * REFER TO SPECIFICATIONS FOR DEFINED CONTAINER MEASUREMENTS AND OTHER PLANT MATERIAL REQUIREMENTS. * SEARCH AND REVIEW: MAKE PLANT MATERIAL AVAILABLE FOR OPTIONAL REVIEW BY LANDSCAPE ARCHITECT AT SOURCE OF SUPPLY. AREA OF SEARCH TO INCLUDE LOWER MAINLAND AND FRASER VALLEY. * SUBSTITUTIONS: OBTAIN WRITTEN APPROVAL FROM THE LANDSCAPE ARCHITECT PRIOR TO MAKING ANY SUBSTITUTIONS TO THE SPECIFIED MATERIAL. UNAPPROVED SUBSTITUTIONS WILL BE REJECTED. ALLOW A MINIMUM OF FIVE DAYS PRIOR TO DELIVERY FOR REQUEST TO SUBSTITUTE. SUBSTITUTIONS ARE SUBJECT TO BC LANDSCAPE STANDARD - DEFINITION OF CONDITIONS OF AVAILABILITY.

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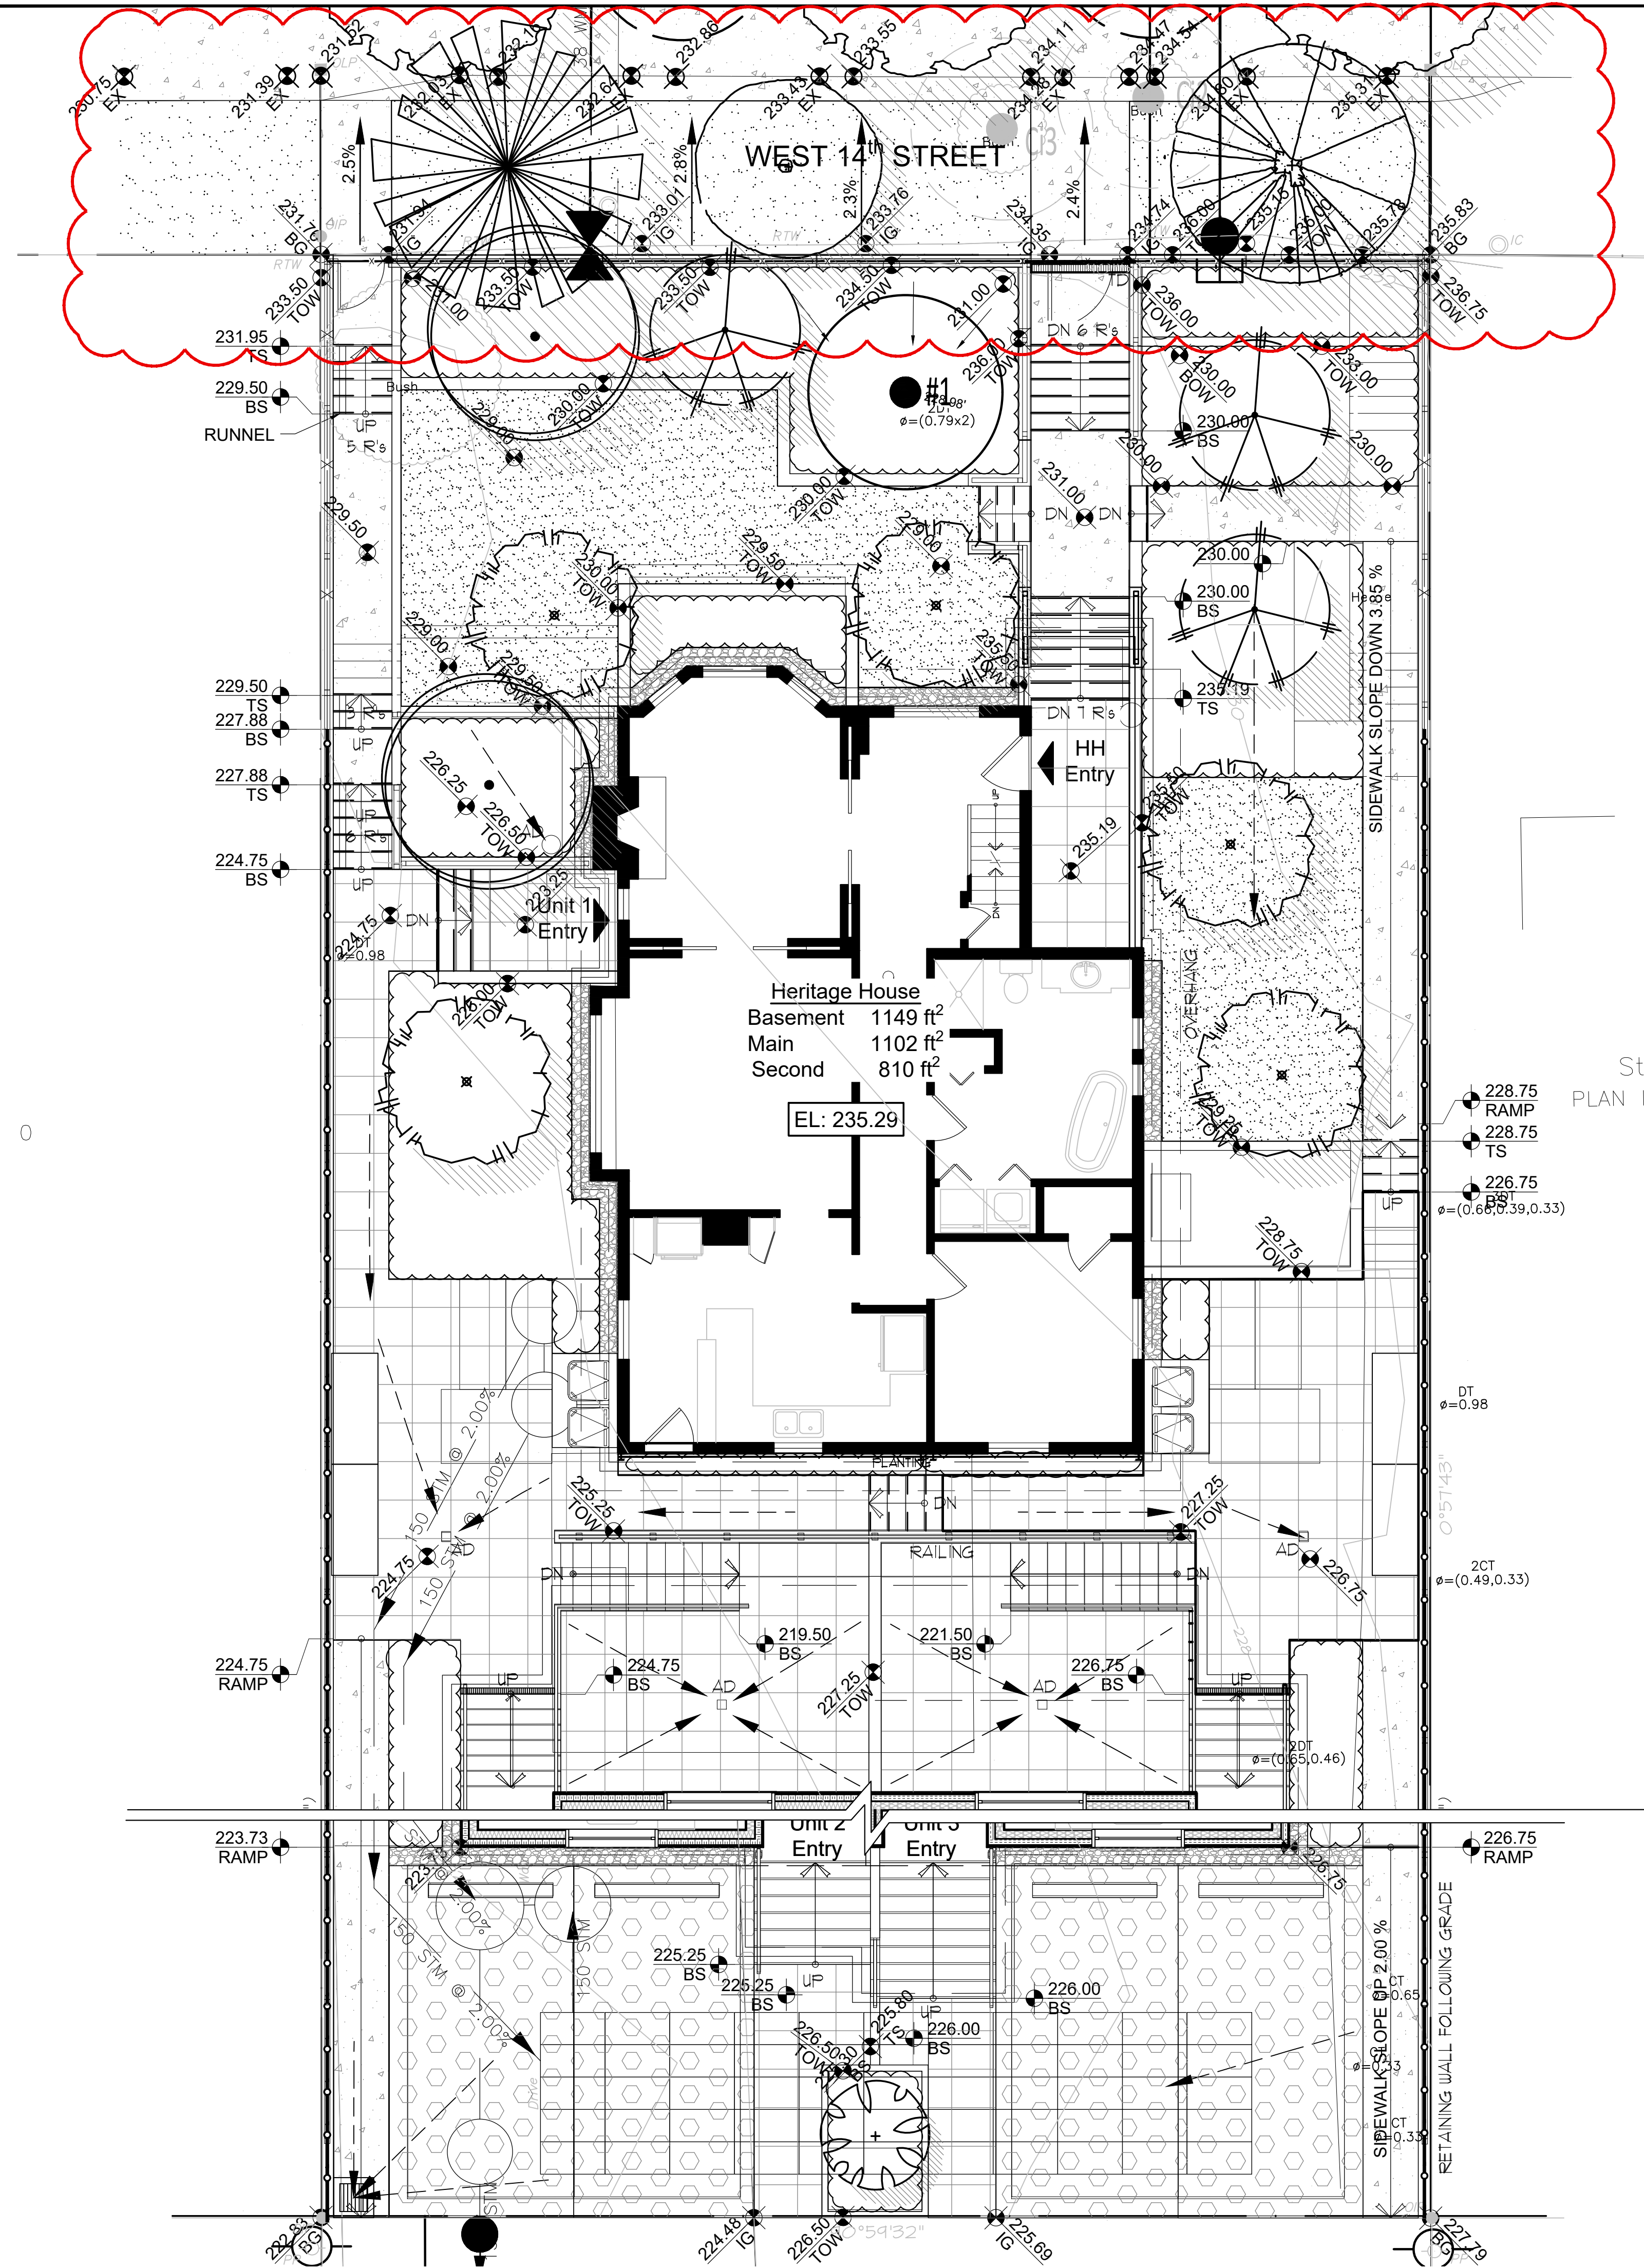
NO.	DATE	REVISION DESCRIPTION	DR.
11	2024-04-26	REVISED PER CITY COMMENTS	SH
10	2023-04-12	ISSUED FOR DP	QL
9	2023-07-12	ISSUED FOR DP	QL
8	2023-09-21	ISSUED FOR DP	QL
7	2023-09-09	ISSUED FOR DP	QL
6	2023-02-15	ISSUED FOR DP	QL
5	2023-08-16	ISSUED FOR DP	QL
4	2023-08-16	ISSUED FOR DP	QL
3	2023-08-25	ISSUED FOR DP	QL
2	2023-07-24	ISSUED FOR PRELIMINARY DESIGN	QL
1	2022-07-28	ISSUED FOR PRELIMINARY DESIGN	QL

SEAL:

PROJECT:
HERITAGE REVITALIZATION AND
NEW LOW ENERGY DUPLEX
311 W 14TH STREET
CITY OF NORTH VANCOUVER, BC

DRAWING TITLE:
**LANDSCAPE
LAYOUT PLAN**

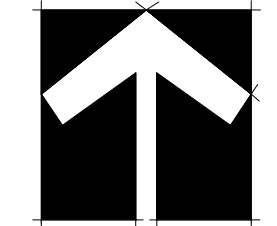DATE: JUL 21/22	DRAWING NUMBER:
SCALE: 1"=1/8"	L1
DRAWN: QL	
DESIGN: QL	
CHK'D: MTLM	
M2LA PROJECT NUMBER:	22-030



GRADING LEGEND

- XXX.XX TS TOP OF STEP
- XXX.XX BS BOTTOM OF STEP
- XXX.XX TW TOP OF WALL
- XXX.XX RAMP TOP/BOTTOM OF RAMP
- XXX.XX PROPOSED FINISH GRADE
- XXX.XX IG CIVIL GRADE


DRAINAGE LEGEND

- AD AREA DRAIN
- DRAINAGE DIRECTION
- DRENCH DRAIN
- CATCH BASIN

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5	2023-02-15	ISSUED FOR DP	QL
4	2022-08-11	ISSUED FOR DP	QL
3	2022-08-25	ISSUED FOR DP	QL
2	2022-07-24	ISSUED FOR PRELIMINARY DESIGN	QL
1	2022-01-21	ISSUED FOR PRELIMINARY DESIGN	QL

SEAL:

PROJECT:
HERITAGE REVITALIZATION AND
NEW LOW ENERGY DUPLEX
311 W 14TH STREET
CITY OF NORTH VANCOUVER, BC

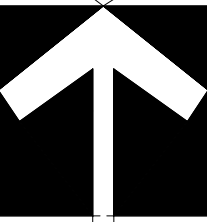DRAWING TITLE:
**GRADING &
DRAINAGE PLAN**

DATE: JUL 21, 2022	DRAWING NUMBER:
SCALE: 1"=3/16"	L2
DRAWN: QL	
DESIGN: QL	
CHK'D: MTLM	
M2LA PROJECT NUMBER:	22-030

POINT OF WATER
CONNECTION
(IRRIGATION)

WEST 14TH STREET

#1

HH
Entry

Unit 1
Entry

Heritage House
Basement 1149 ft²
Main 1102 ft²
Second 810 ft²

EL: 235.29

0°51'43"


LEGEND

- IRRIGATION SLEEVE
- POINT OF WATER CONNECTION

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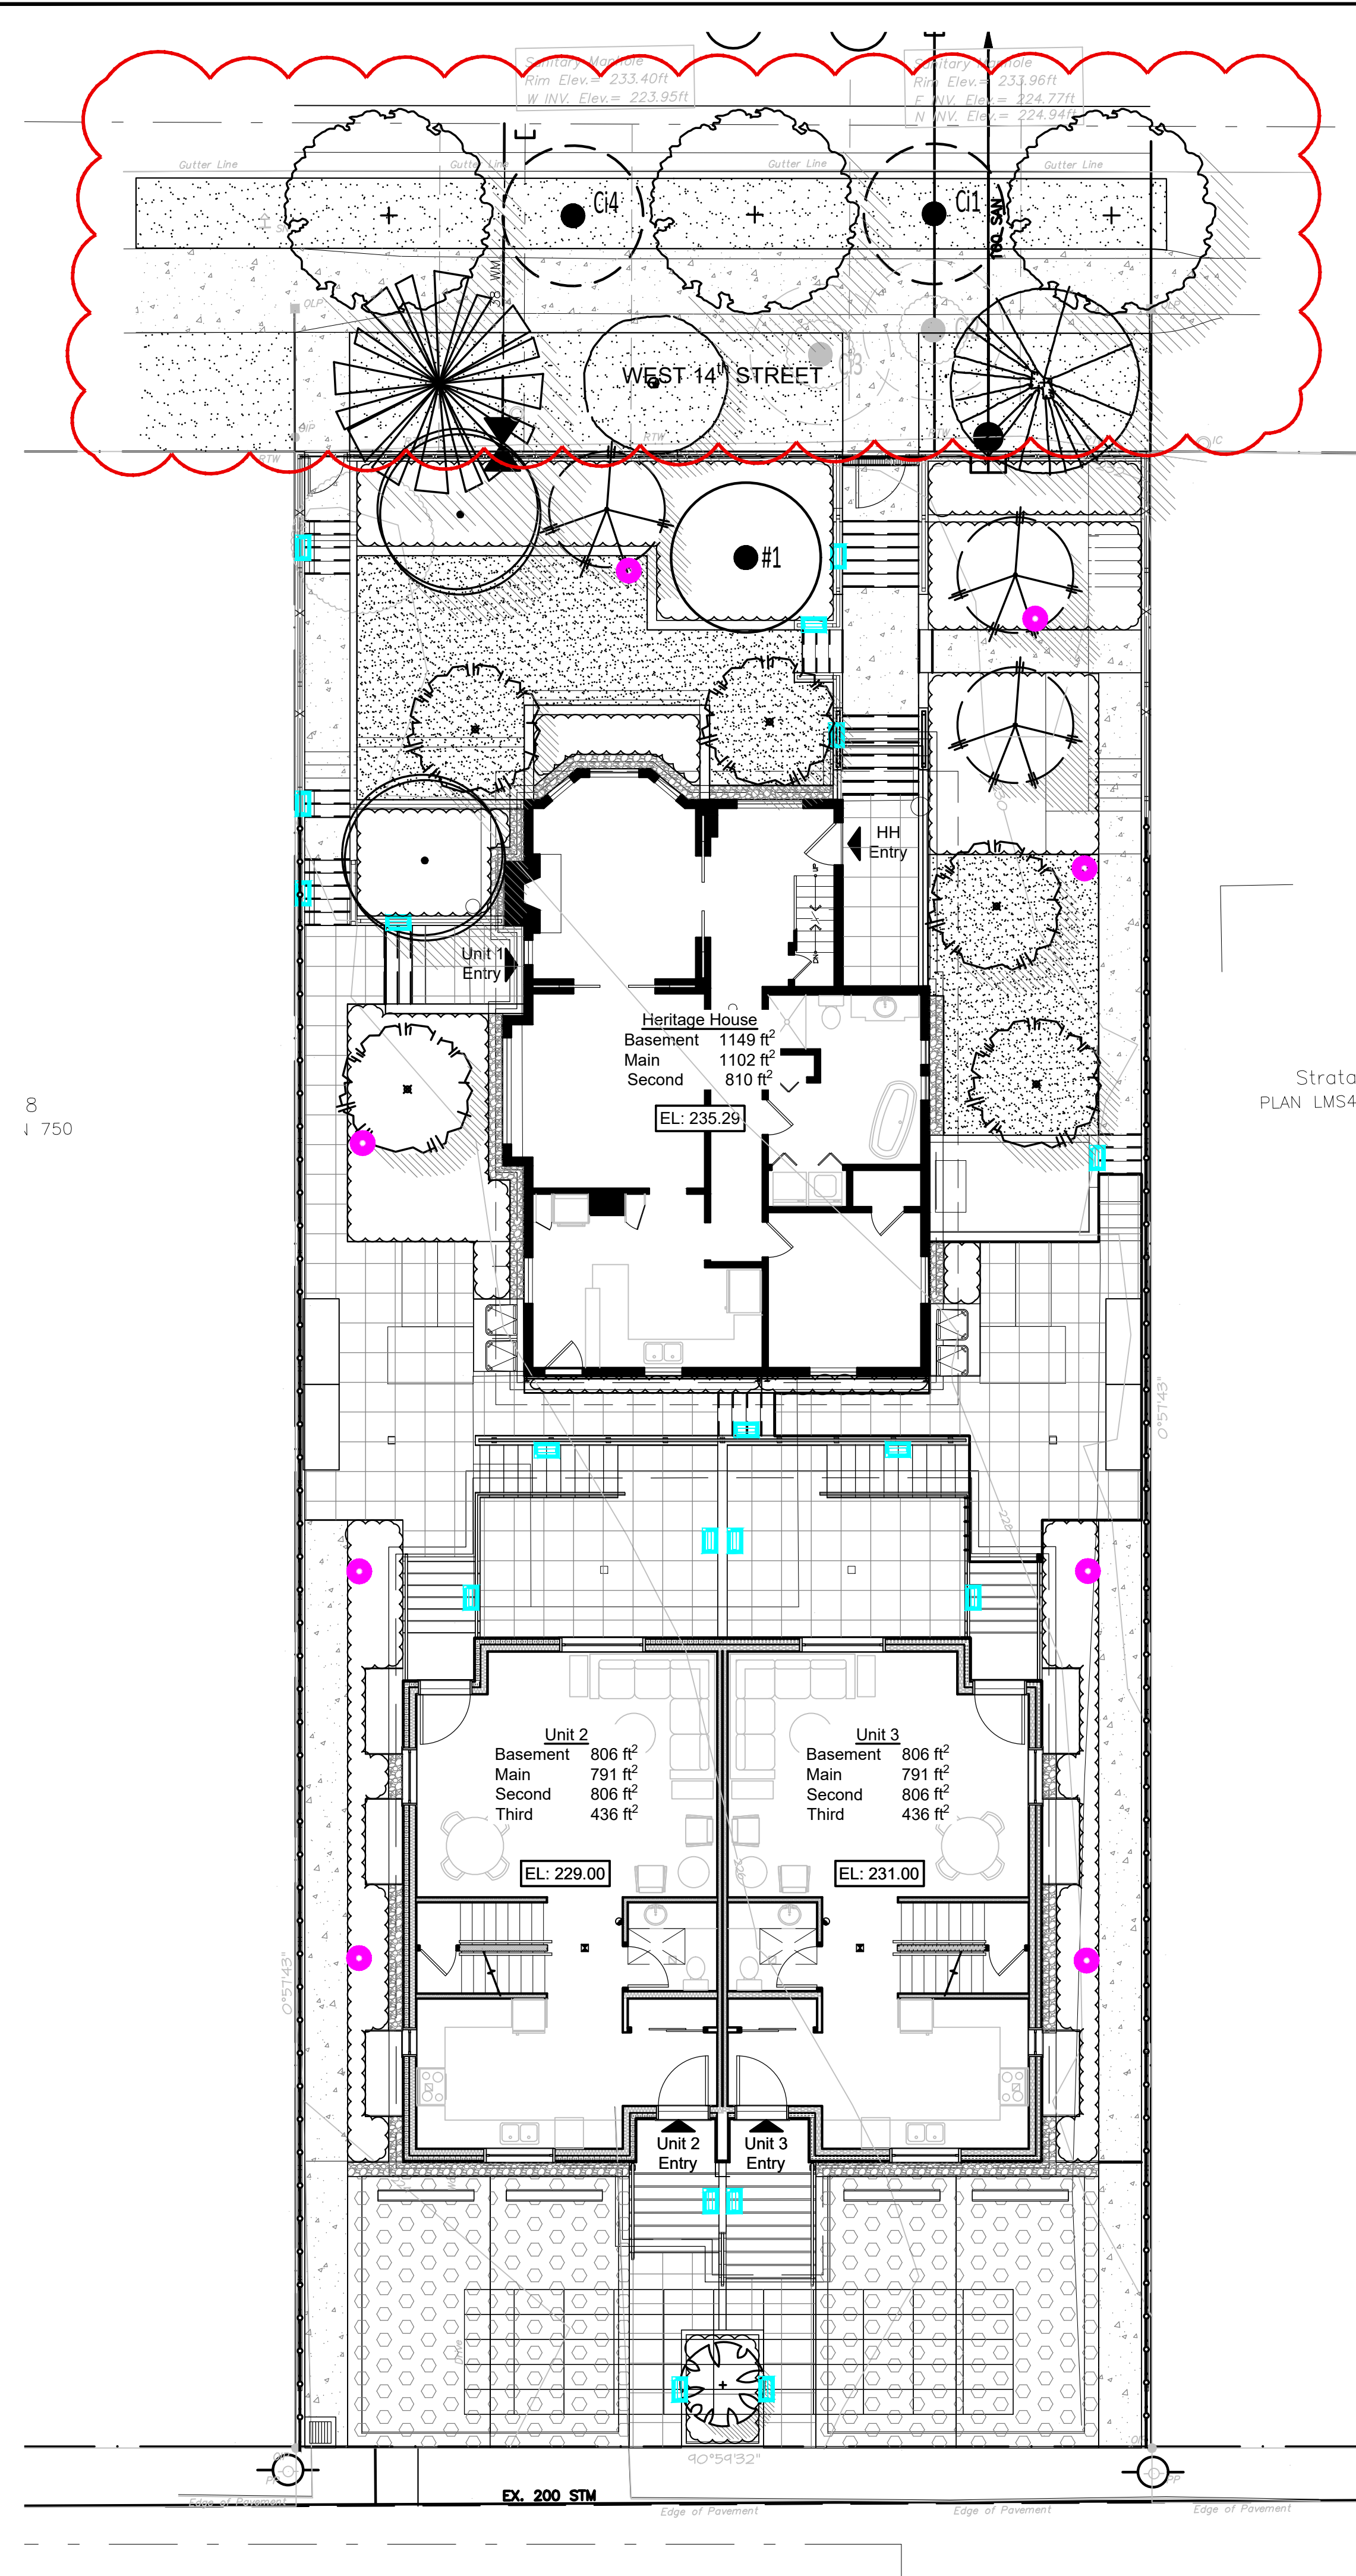
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1	2022-01-21	ISSUED FOR PRELIMINARY DESIGN	QL

SEAL:

PROJECT:
HERITAGE REVITALIZATION AND
NEW LOW ENERGY DUPLEX
311 W 14TH STREET
CITY OF NORTH VANCOUVER, BC

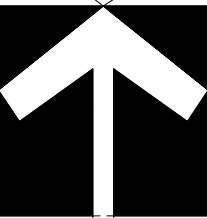DRAWING TITLE:
**IRRIGATION
PLAN**

DATE: JUL 21/22	DRAWING NUMBER:
SCALE: 1"=3/16"	L3
DRAWN: QL	
DESIGN: QL	
CHK'D: MTLM	
M2LA PROJECT NUMBER:	22-030




QUAD LED PATH LIGHT
6091



PRODUCT DESCRIPTION
Sleek linear design blends seamlessly into pathways while providing soft, even illumination

SPECIFICATIONS
Input: 9-15VAC (Transformer is required)
Power: 3.0W / 4.5VA
Brightness: Up to 100 lm
CRI: 90
Rated Life: 60,000 hours

- FEATURES**
- IP66 rated, Protected against powerful water jets
 - Factory sealed water tight fixtures
 - Solid diecast corrosion resistant aluminum alloy
 - Recommended spacing for installation: Residential 8 to 10ft; Commercial: 5 to 7ft
 - Mounting stake, 6 foot lead wire, and direct burial gel filled wire nuts are included
 - Maintains constant lumen output against voltage drop
 - UL & cUL 1838 Listed

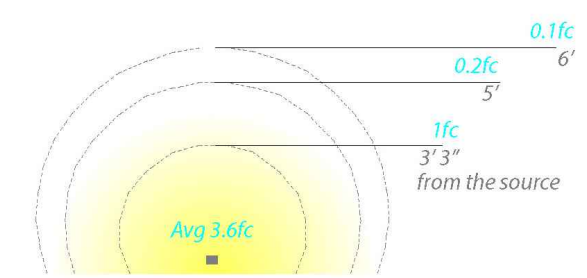

ORDERING NUMBER		Color Temp		Finish	
6091	Quad	27	2700K Warm White	BZ	Bronze on Aluminum
		30	3000K Pure White		

6091-__BZ
Example: 6091-30BZ

wacighting.com Phone (800) 526.2588
Headquarters/Eastern Distribution Center 44 Harbor Park Drive Port Washington, NY 11050
Central Distribution Center 1600 Distribution Ct Lithia Springs, GA 30122
Western Distribution Center 1750 Archibald Avenue Ontario, CA 91760

WAC Lighting retains the right to modify the design of our products at any time as part of the company's continuous improvement program.

WAC
LANDSCAPE LIGHTING

Fixture Type:

Catalog Number:

Project:

Location:

WAC LIGHTING

WL-LED140
Step And Wall Light


Model & Voltage	Color Temp & CRI	Lumens	Finish
WL-LED140 120 VAC	Amber 90	3	BK Black on Aluminum
WL-LED140F 277 VAC	White 90	3	BZ Bronze on Aluminum
	Amber 90	3	WT White on Aluminum
	White 90	3	

Example: WL-LED140-AM-BK

DESCRIPTION
WAC Lighting Step and Wall Lights are designed to seamlessly blend into any architecture featuring a sleek interchangeable magnetic faceplate with no visible hardware. These luminaires offer enhanced energy-efficient functionality and optimized light output to adequately illuminate stairs, walls and walkways with little or no glare. Light engine is IP66 sealed for both indoor and outdoor applications.

- FEATURES**
- Geometric design with downward illumination
 - Magnetized design for easy installation and maintenance
 - Low profile, flush to wall aesthetics with no visible hardware
 - 5 year warranty

SPECIFICATIONS
Construction: Die-cast corrosion resistant aluminum alloy
Power: 3W, 3.5W
Input: 277 VAC, 50/60Hz, 120 VAC
Dimming: ELV: 100-10%
Light Source: Integrated LED
Rated Life: 50000 Hours
Mounting: Fits into 2" x 4" J-Box with minimum inside dimensions of 3"L x 2"W x 2.5"D
Finish: Enamel Coated: White on Aluminum, Bronze on Aluminum, Black on Aluminum
Operating Temp: -40°F to 104°F (-40°C to 40°C)
Standards: ETL, cETL, Wet Location Listed, IP66, ADA, Title 24 JAB-2019 Compliant

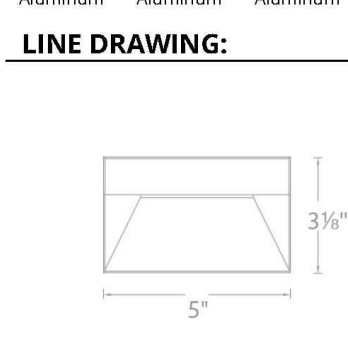

REPLACEMENT PARTS
W-4091-140-BK - LED140 Cover Plate BK
W-4091-140-BZ - LED140 Cover Plate BZ
W-4091-140-WT - LED140 Cover Plate WT

wacighting.com | Phone (800) 526.2588 | Fax (800) 526.2585 | Headquarters/Eastern Distribution Center 44 Harbor Park Drive Port Washington, NY 11050
WAC Lighting retains the right to modify the design of our products at any time as part of the company's continuous improvement program. August 2022




LIGHTING LEGEND

- STEP LIGHT
- BOLLARD LIGHT

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2	2022-07-24	ISSUED FOR PRELIMINARY DESIGN	QL
1	2022-01-28	ISSUED FOR PRELIMINARY DESIGN	QL

SEAL:


PROJECT:
HERITAGE REVITALIZATION AND
NEW LOW ENERGY DUPLEX
311 W 14TH STREET
CITY OF NORTH VANCOUVER, BC

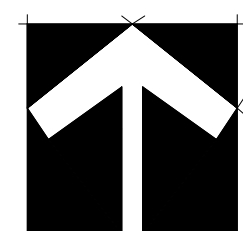DRAWING TITLE:
**LIGHTING
PLAN**

DATE: JUL 21/22	DRAWING NUMBER:
SCALE: 1"=1/8"	L4
DRAWN: QL	
DESIGN: QL	
CHK'D: MTLM	OF 11

M2LA PROJECT NUMBER: 22-030

West 14th Street

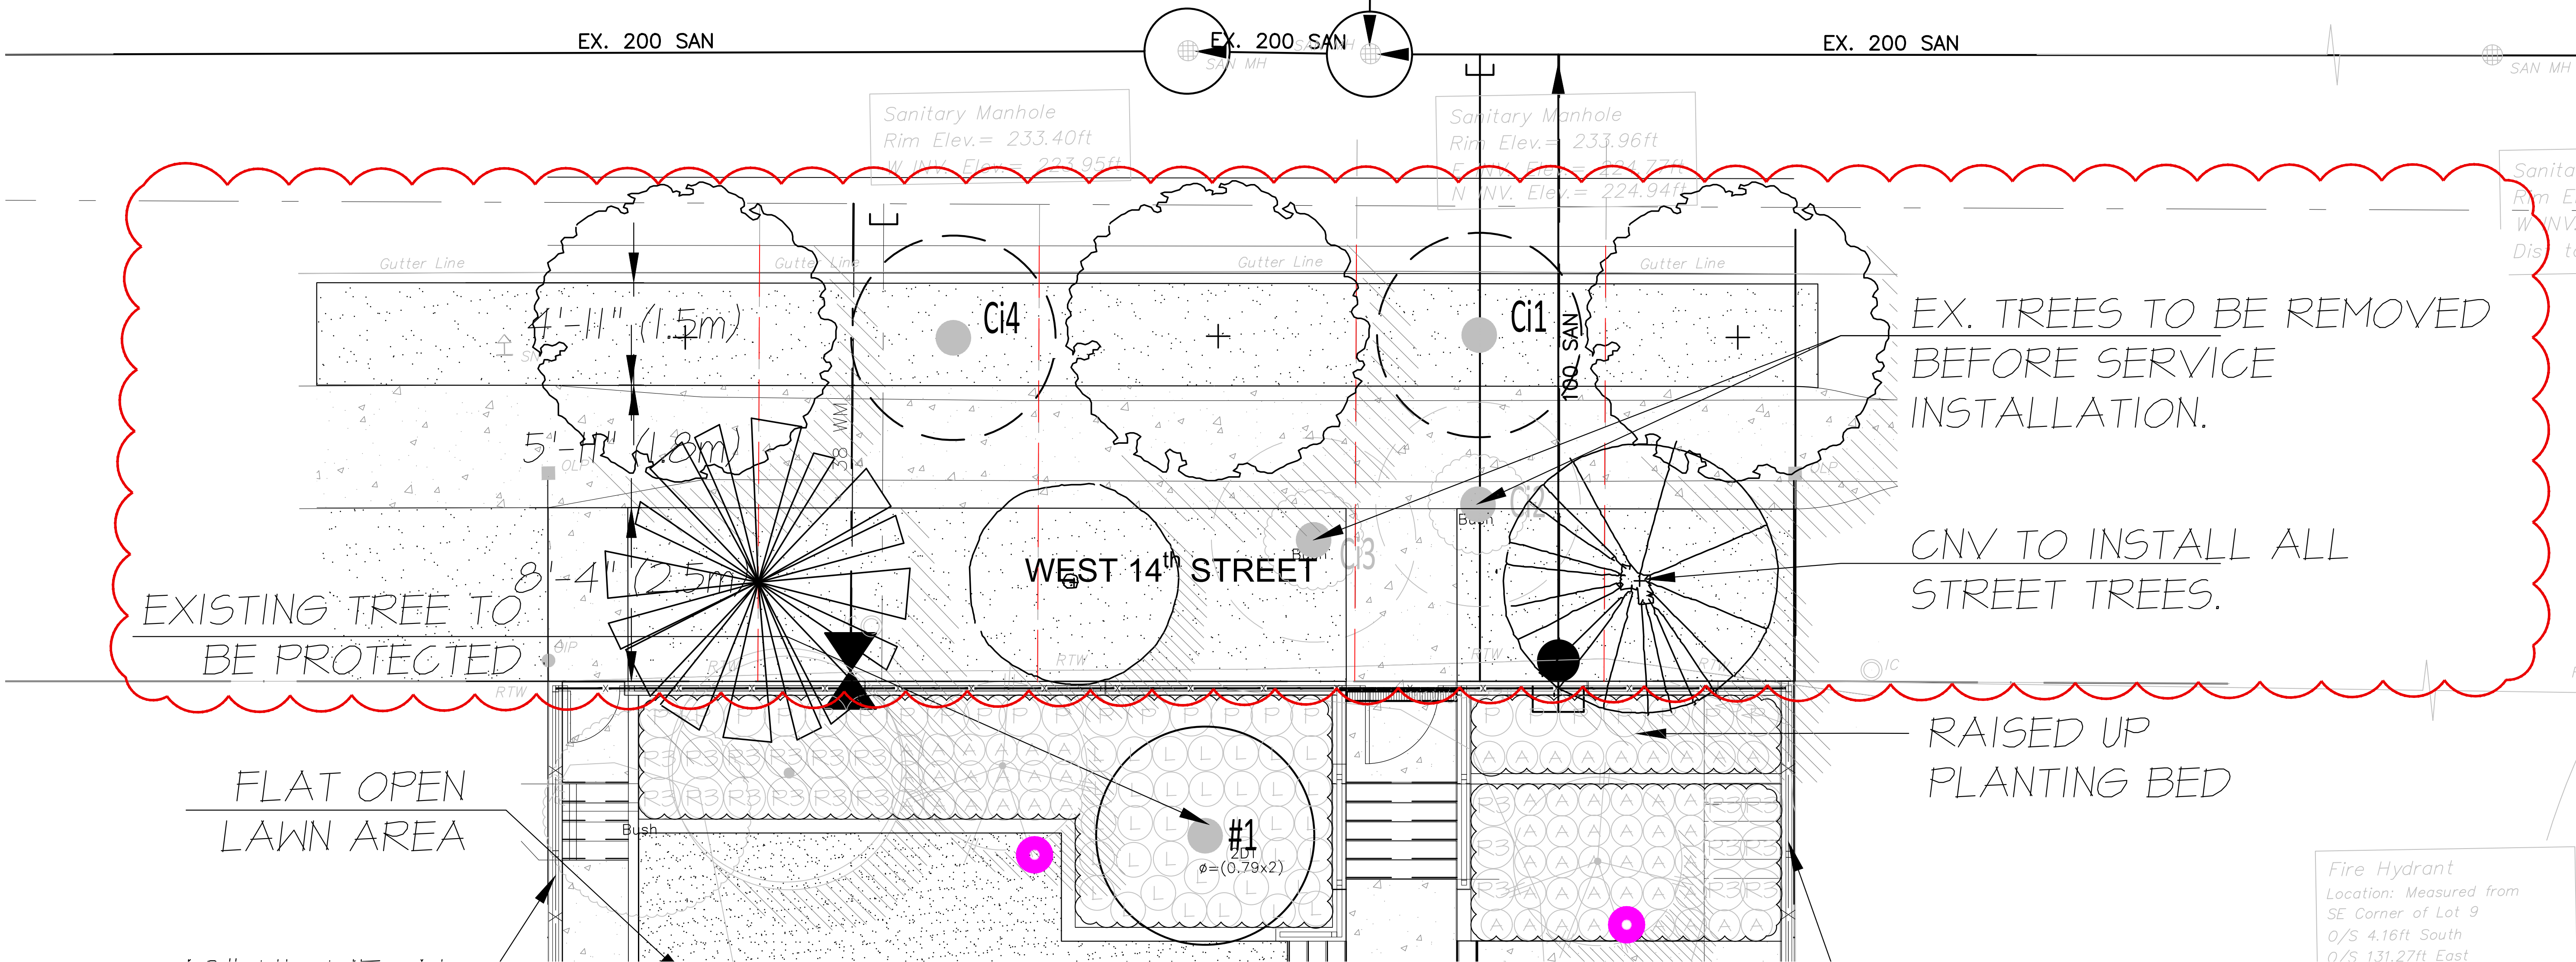

LEGEND

--- CLEARANCE FROM THE UNDERGROUND SERVICE LINES

PLANT SCHEDULE - OFFSITE

M2 JOB NUMBER: 22-030

KEY	QTY	BOTANICAL NAME	COMMON NAME	PLANTED SIZE / REMARKS
	2	ACER GIRCINATUM	VINE MAPLE	1.5M HT; B&B;
	2	QUERCUS COCCINEA	SCARLET OAK	6CM CAL; B&B
	1	EXISTING CITY TREE Ci1 TO BE RELOCATED	GREEN VASE ZELKOVE	
	1	EXISTING CITY TREE Ci2 TO BE REMOVED	GOLDEN GLOBE CEDAR	
	1	EXISTING CITY TREE Ci3 TO BE REMOVED	GOLDEN GLOBE CEDAR	
	1	EXISTING CITY TREE Ci4 TO BE RELOCATED	PIN OAK	


NOTES: * PLANT SIZES IN THIS LIST ARE SPECIFIED ACCORDING TO THE BC LANDSCAPE STANDARD, LATEST EDITION. CONTAINER SIZES SPECIFIED AS PER CNTA STANDARDS. BOTH PLANT SIZE AND CONTAINER SIZE ARE THE MINIMUM ACCEPTABLE SIZES. * REFER TO SPECIFICATIONS FOR DEFINED CONTAINER MEASUREMENTS AND OTHER PLANT MATERIAL REQUIREMENTS. * SEARCH AND REVIEW: MAKE PLANT MATERIAL AVAILABLE FOR OPTIONAL REVIEW BY LANDSCAPE ARCHITECT AT SOURCE OF SUPPLY. AREA OF SEARCH TO INCLUDE LOWER MAINLAND AND FRASER VALLEY. * SUBSTITUTIONS: OBTAIN WRITTEN APPROVAL FROM THE LANDSCAPE ARCHITECT PRIOR TO MAKING ANY SUBSTITUTIONS TO THE SPECIFIED MATERIAL. UNAPPROVED SUBSTITUTIONS WILL BE REJECTED. ALLOW A MINIMUM OF FIVE DAYS PRIOR TO DELIVERY FOR REQUEST TO SUBSTITUTE. SUBSTITUTIONS ARE SUBJECT TO BC LANDSCAPE STANDARD - DEFINITION OF CONDITIONS OF AVAILABILITY.

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1	2022-01-21	ISSUED FOR PRELIMINARY DESIGN	QL

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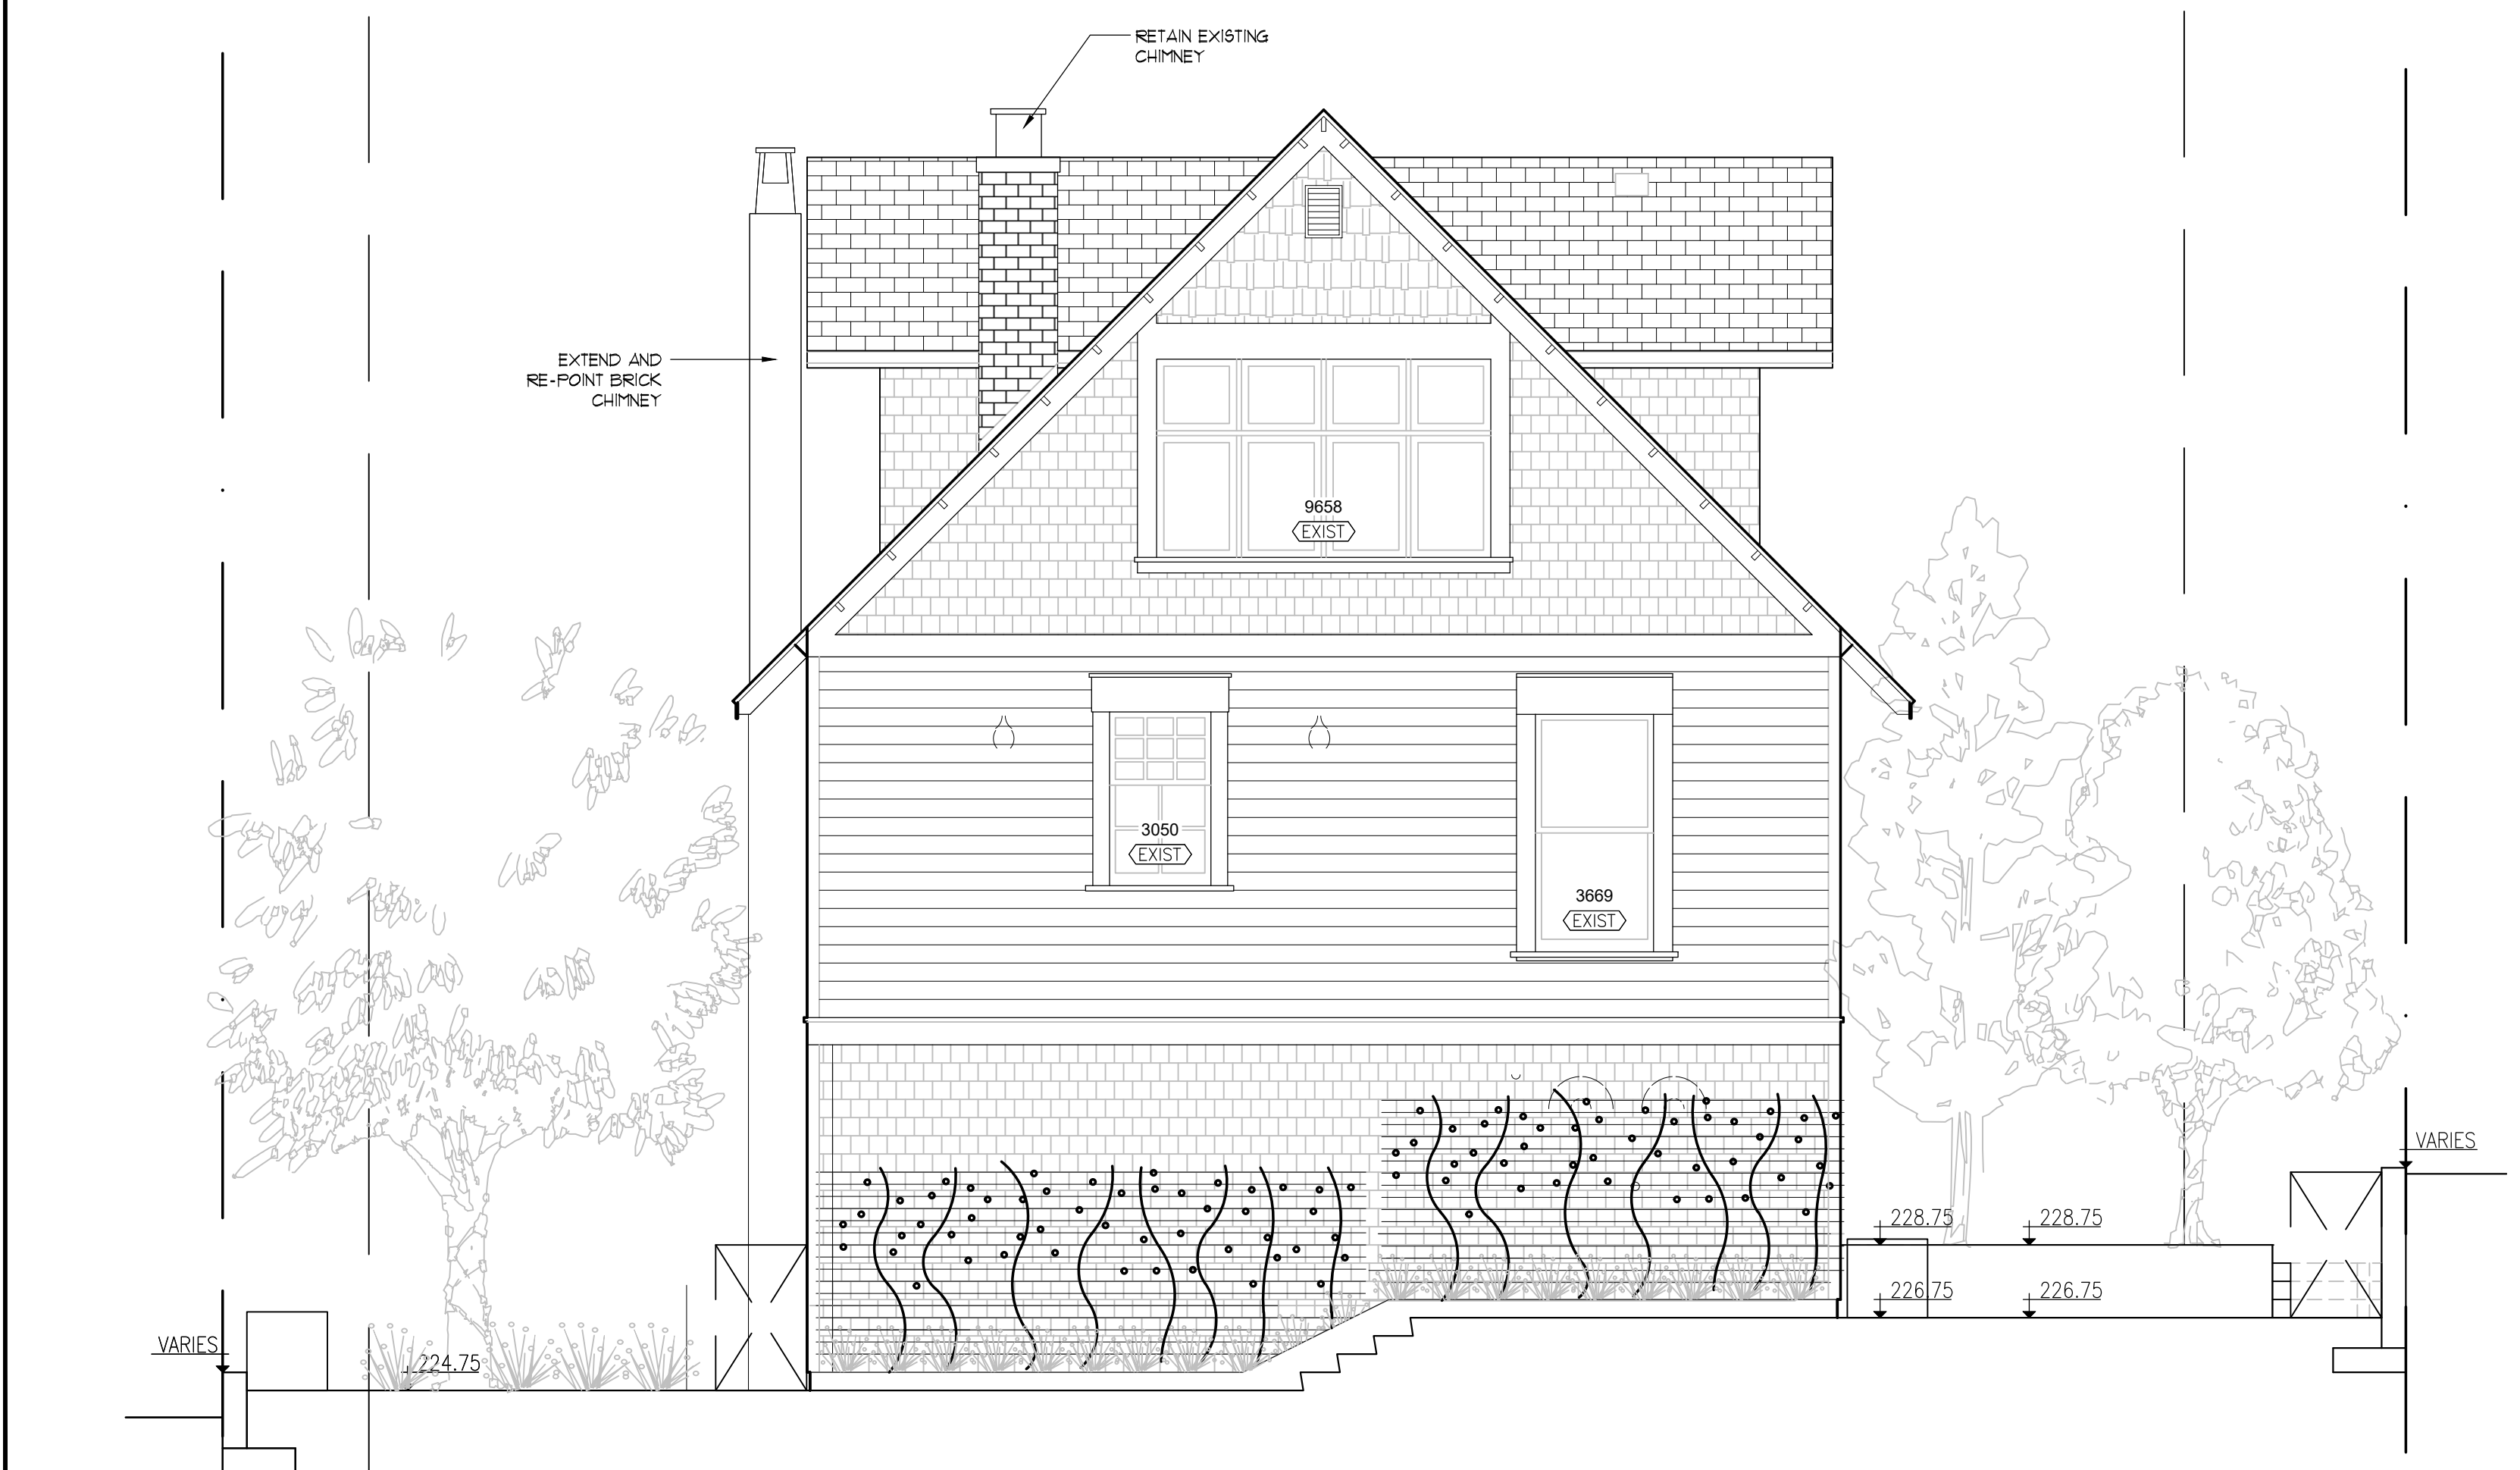
PROJECT:
HERITAGE REVITALIZATION AND
NEW LOW ENERGY DUPLEX
311 W 14TH STREET
CITY OF NORTH VANCOUVER, BC

DRAWING TITLE:
**OFFSITE LANDSCAPE
PLAN**

DATE: JUL 21/22	DRAWING NUMBER:
SCALE: 1"=10'	L5
DRAWN: QL	
DESIGN: QL	
CHK'D: MTLM	

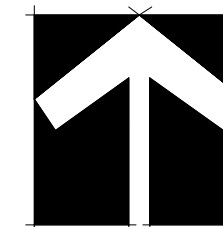M2LA PROJECT NUMBER: 22-030

22030-11



01 HERITAGE HOUSE SOUTH ELEVATION
L6 SCALE: 1'=1/4"



GREEN WALL CABLE SYSTEM - REFERENCE ONLY

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4	2022-06-11	ISSUED FOR DP	OL
3	2022-06-05	ISSUED FOR DP	OL
2	2022-07-26	ISSUED FOR PRELIMINARY DESIGN	OL
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NO.	DATE	REVISION DESCRIPTION	DR.




SEAL:

PROJECT:
HERITAGE REVITALIZATION AND
NEW LOW ENERGY DUPLEX
311 W 14TH STREET
CITY OF NORTH VANCOUVER, BC

DRAWING TITLE:

**LANDSCAPE
SECTIONS**

DATE: JUNE 29, 22	DRAWING NUMBER: L6 <i>OF 11</i>
SCALE: A5 SHOW IN	
DRAWN: GL	
DESIGN: GL	
CHK'D: MTL M	
M2LA PROJECT NUMBER: 22-030	

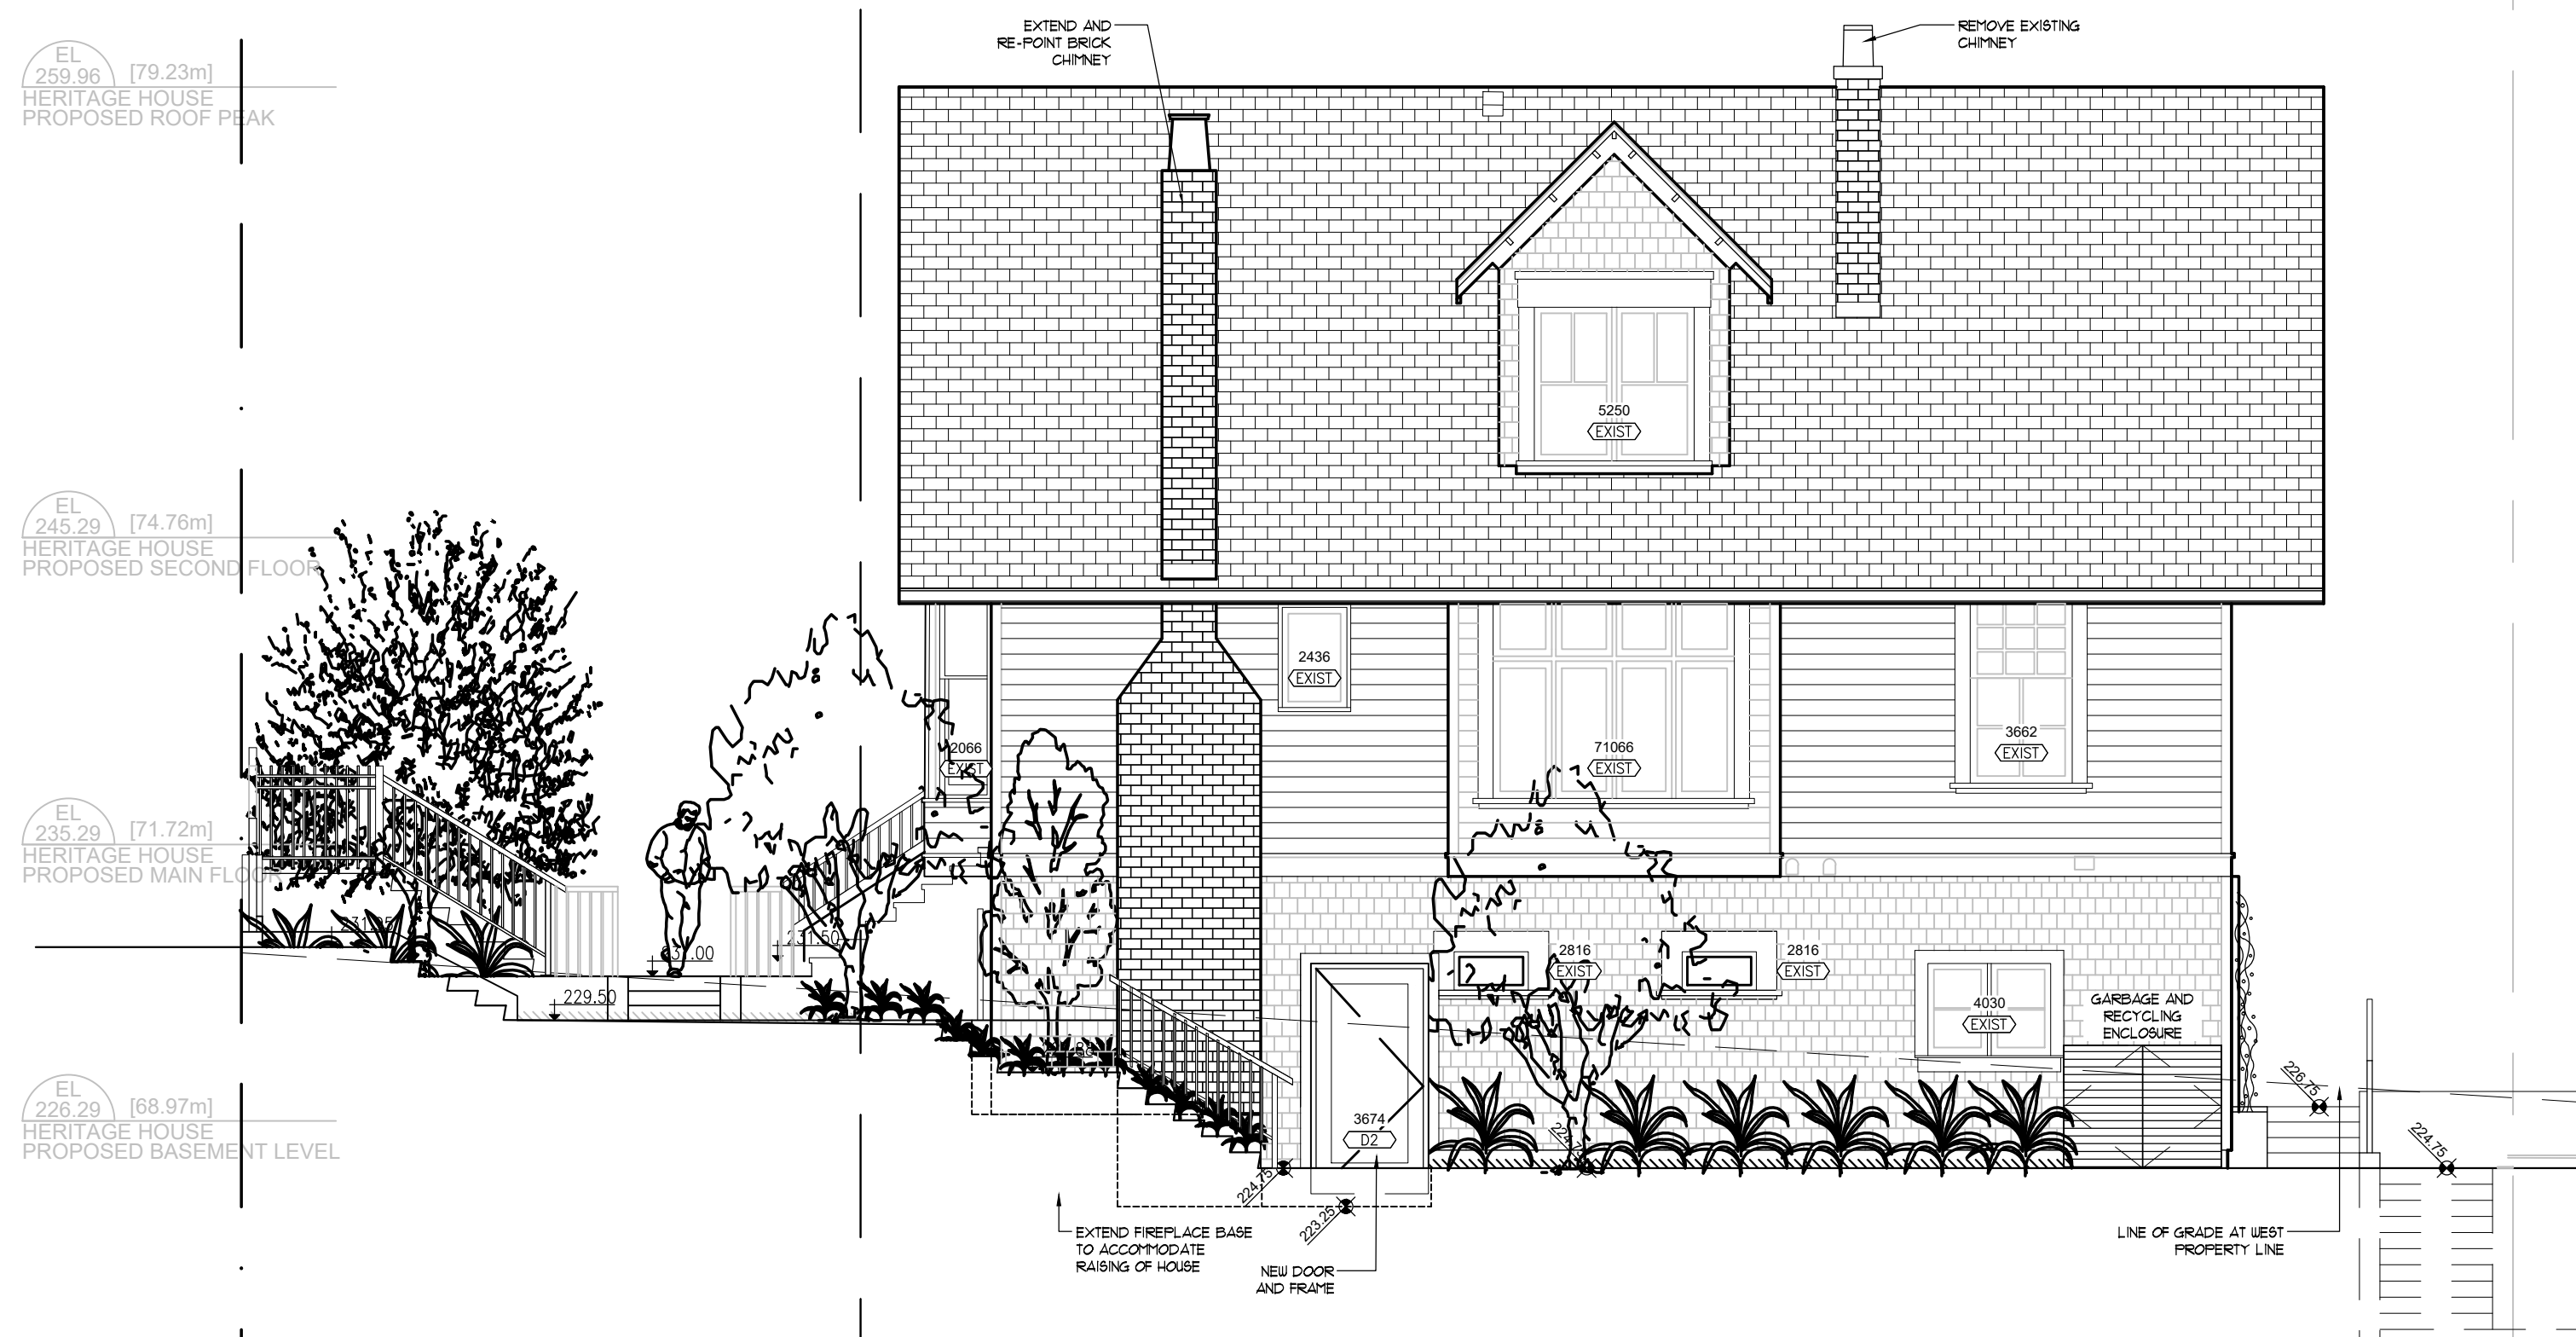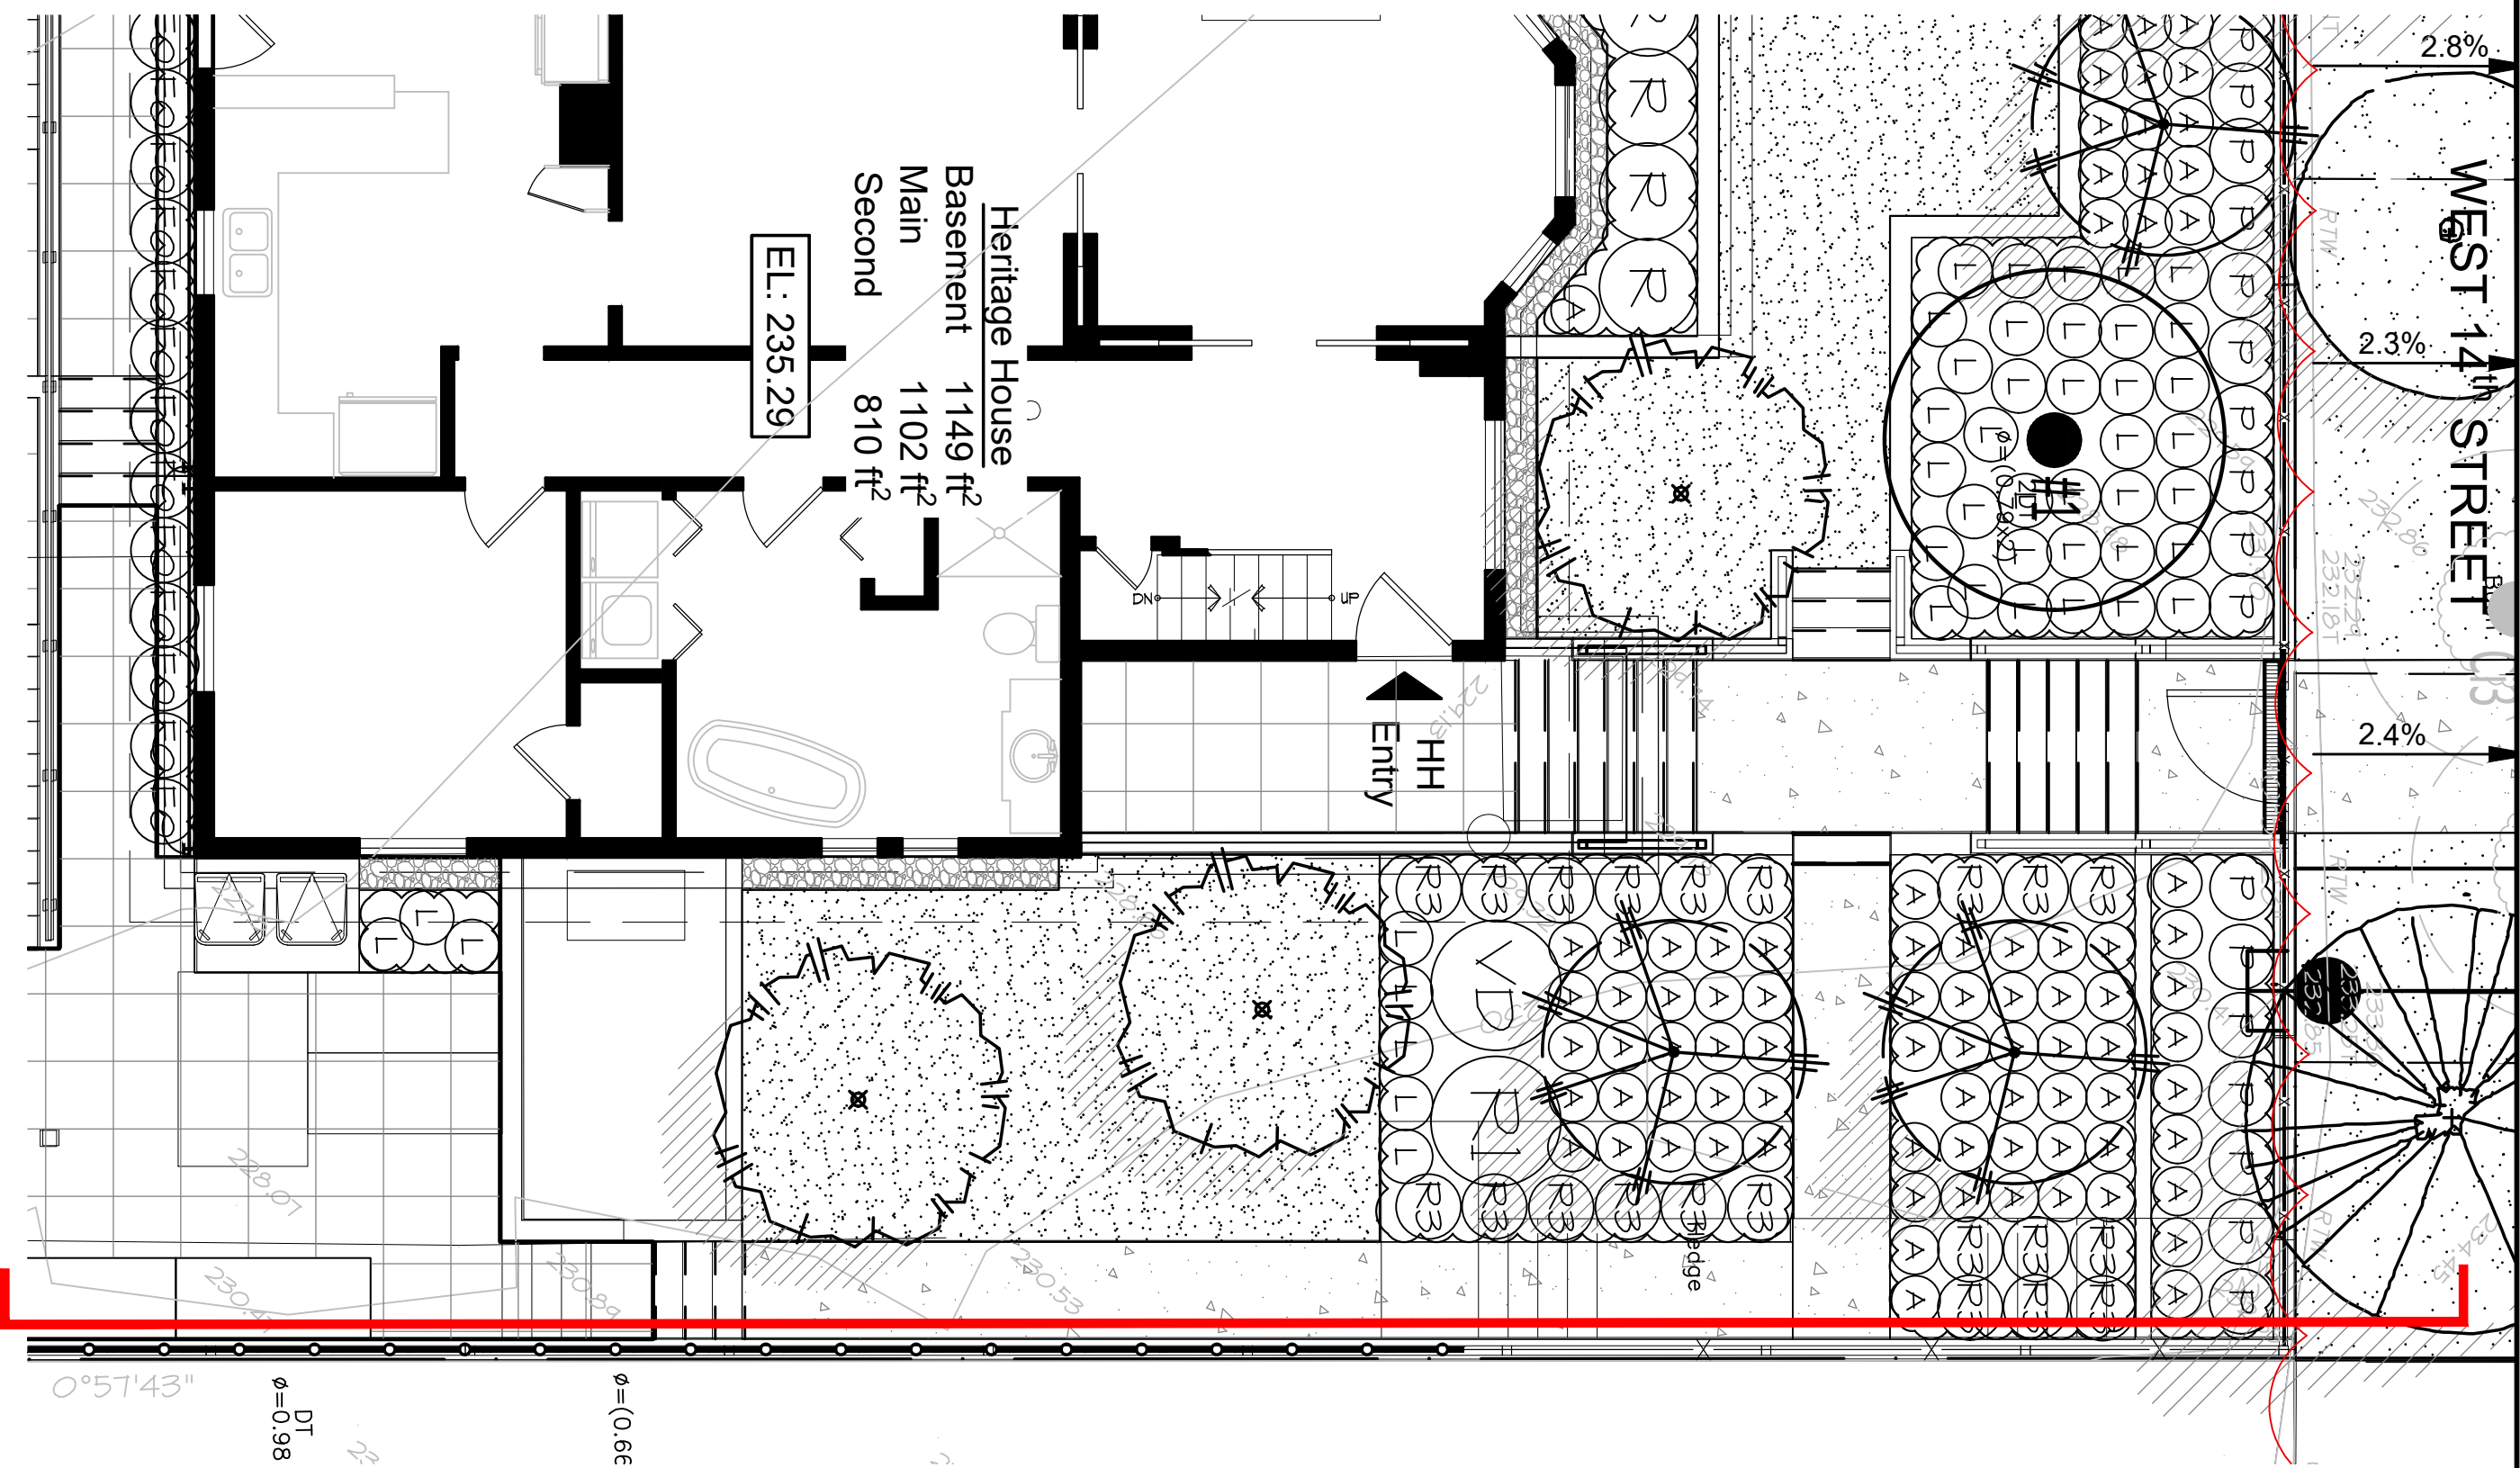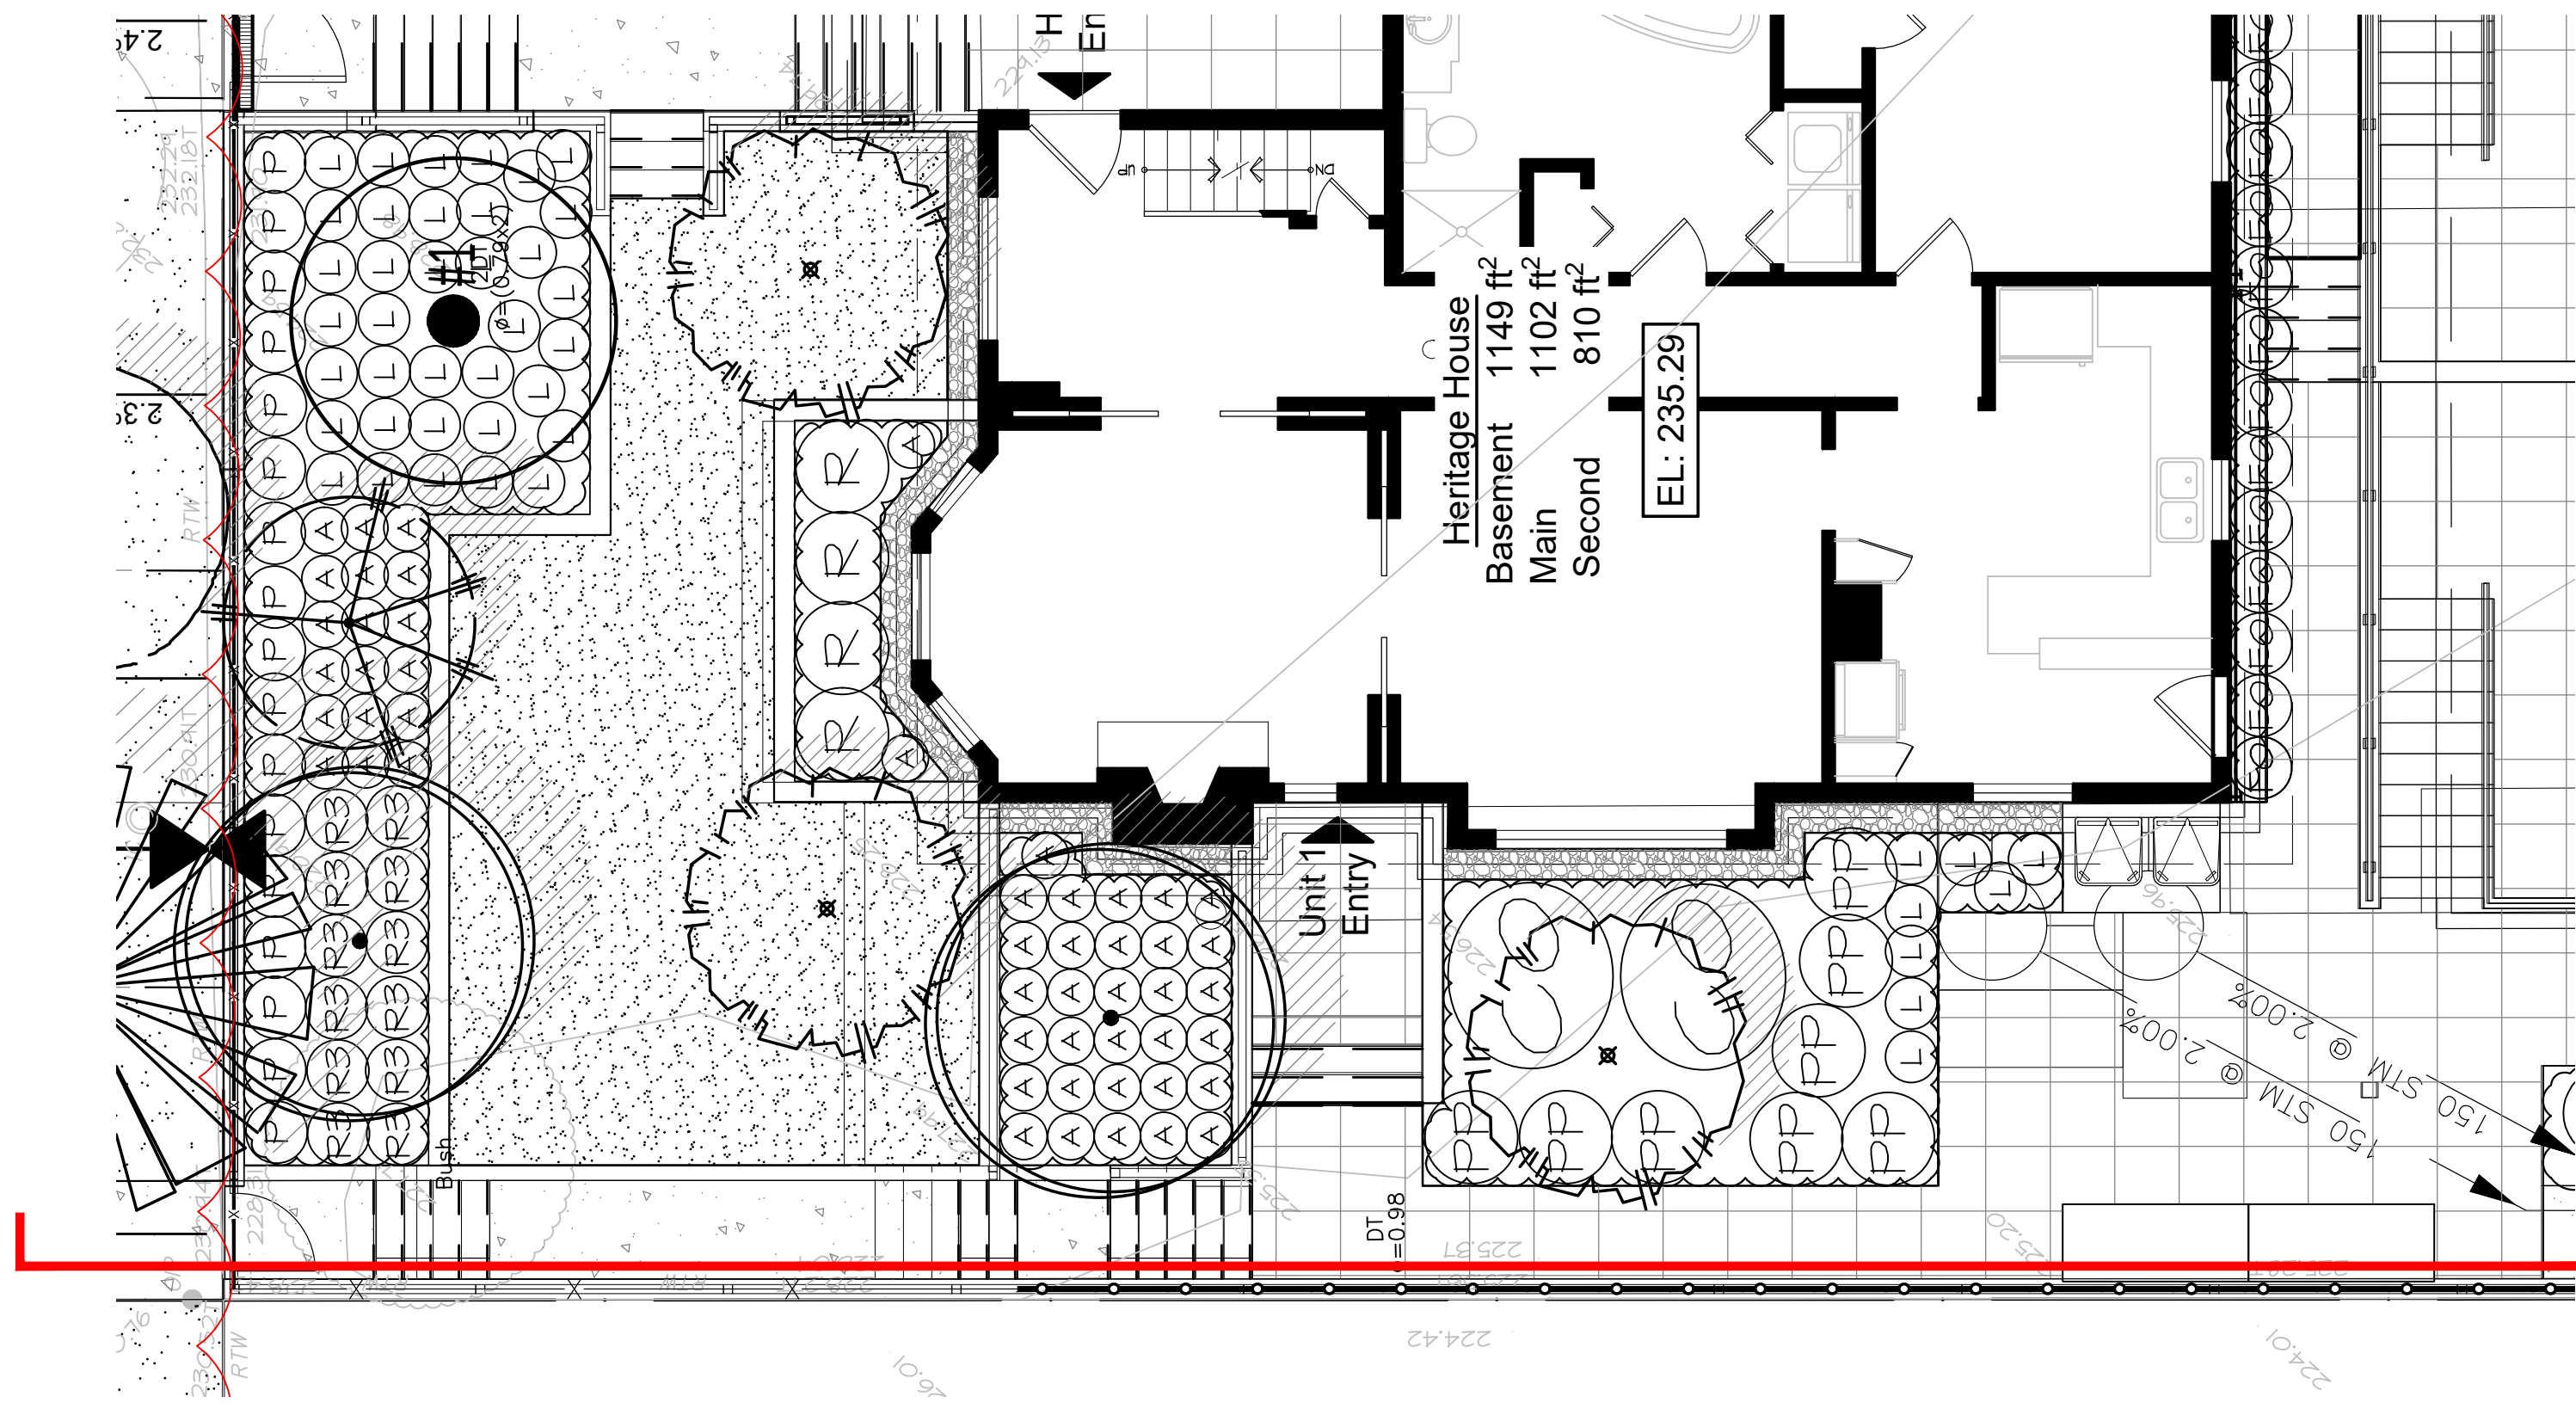

01 HERITAGE HOUSE WEST ELEVATION
L7 SCALE: 1"=3/16"



02 HERITAGE HOUSE EAST ELEVATION
L7 SCALE: 1"=3/16"

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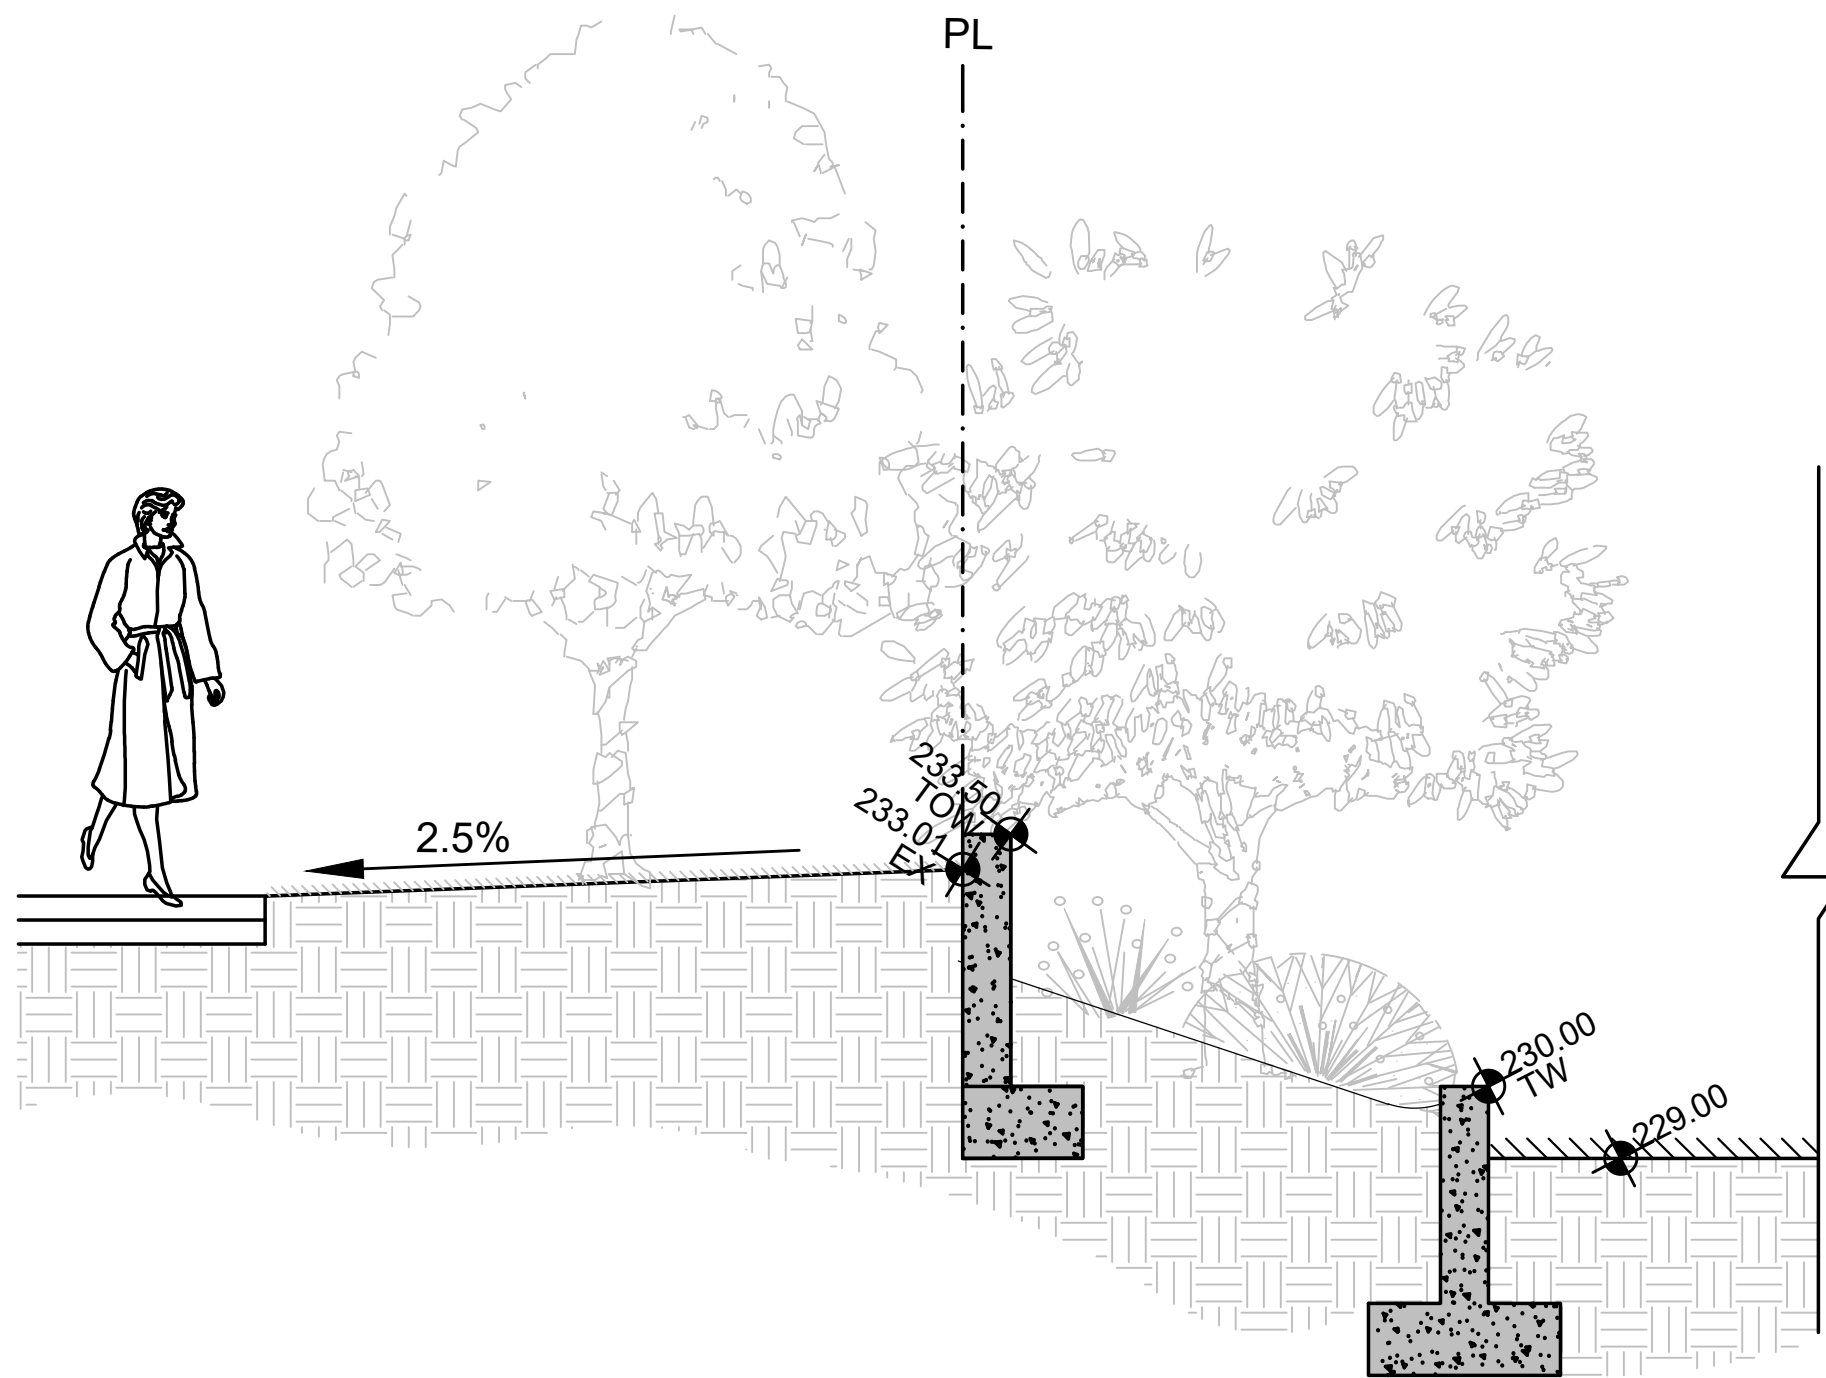
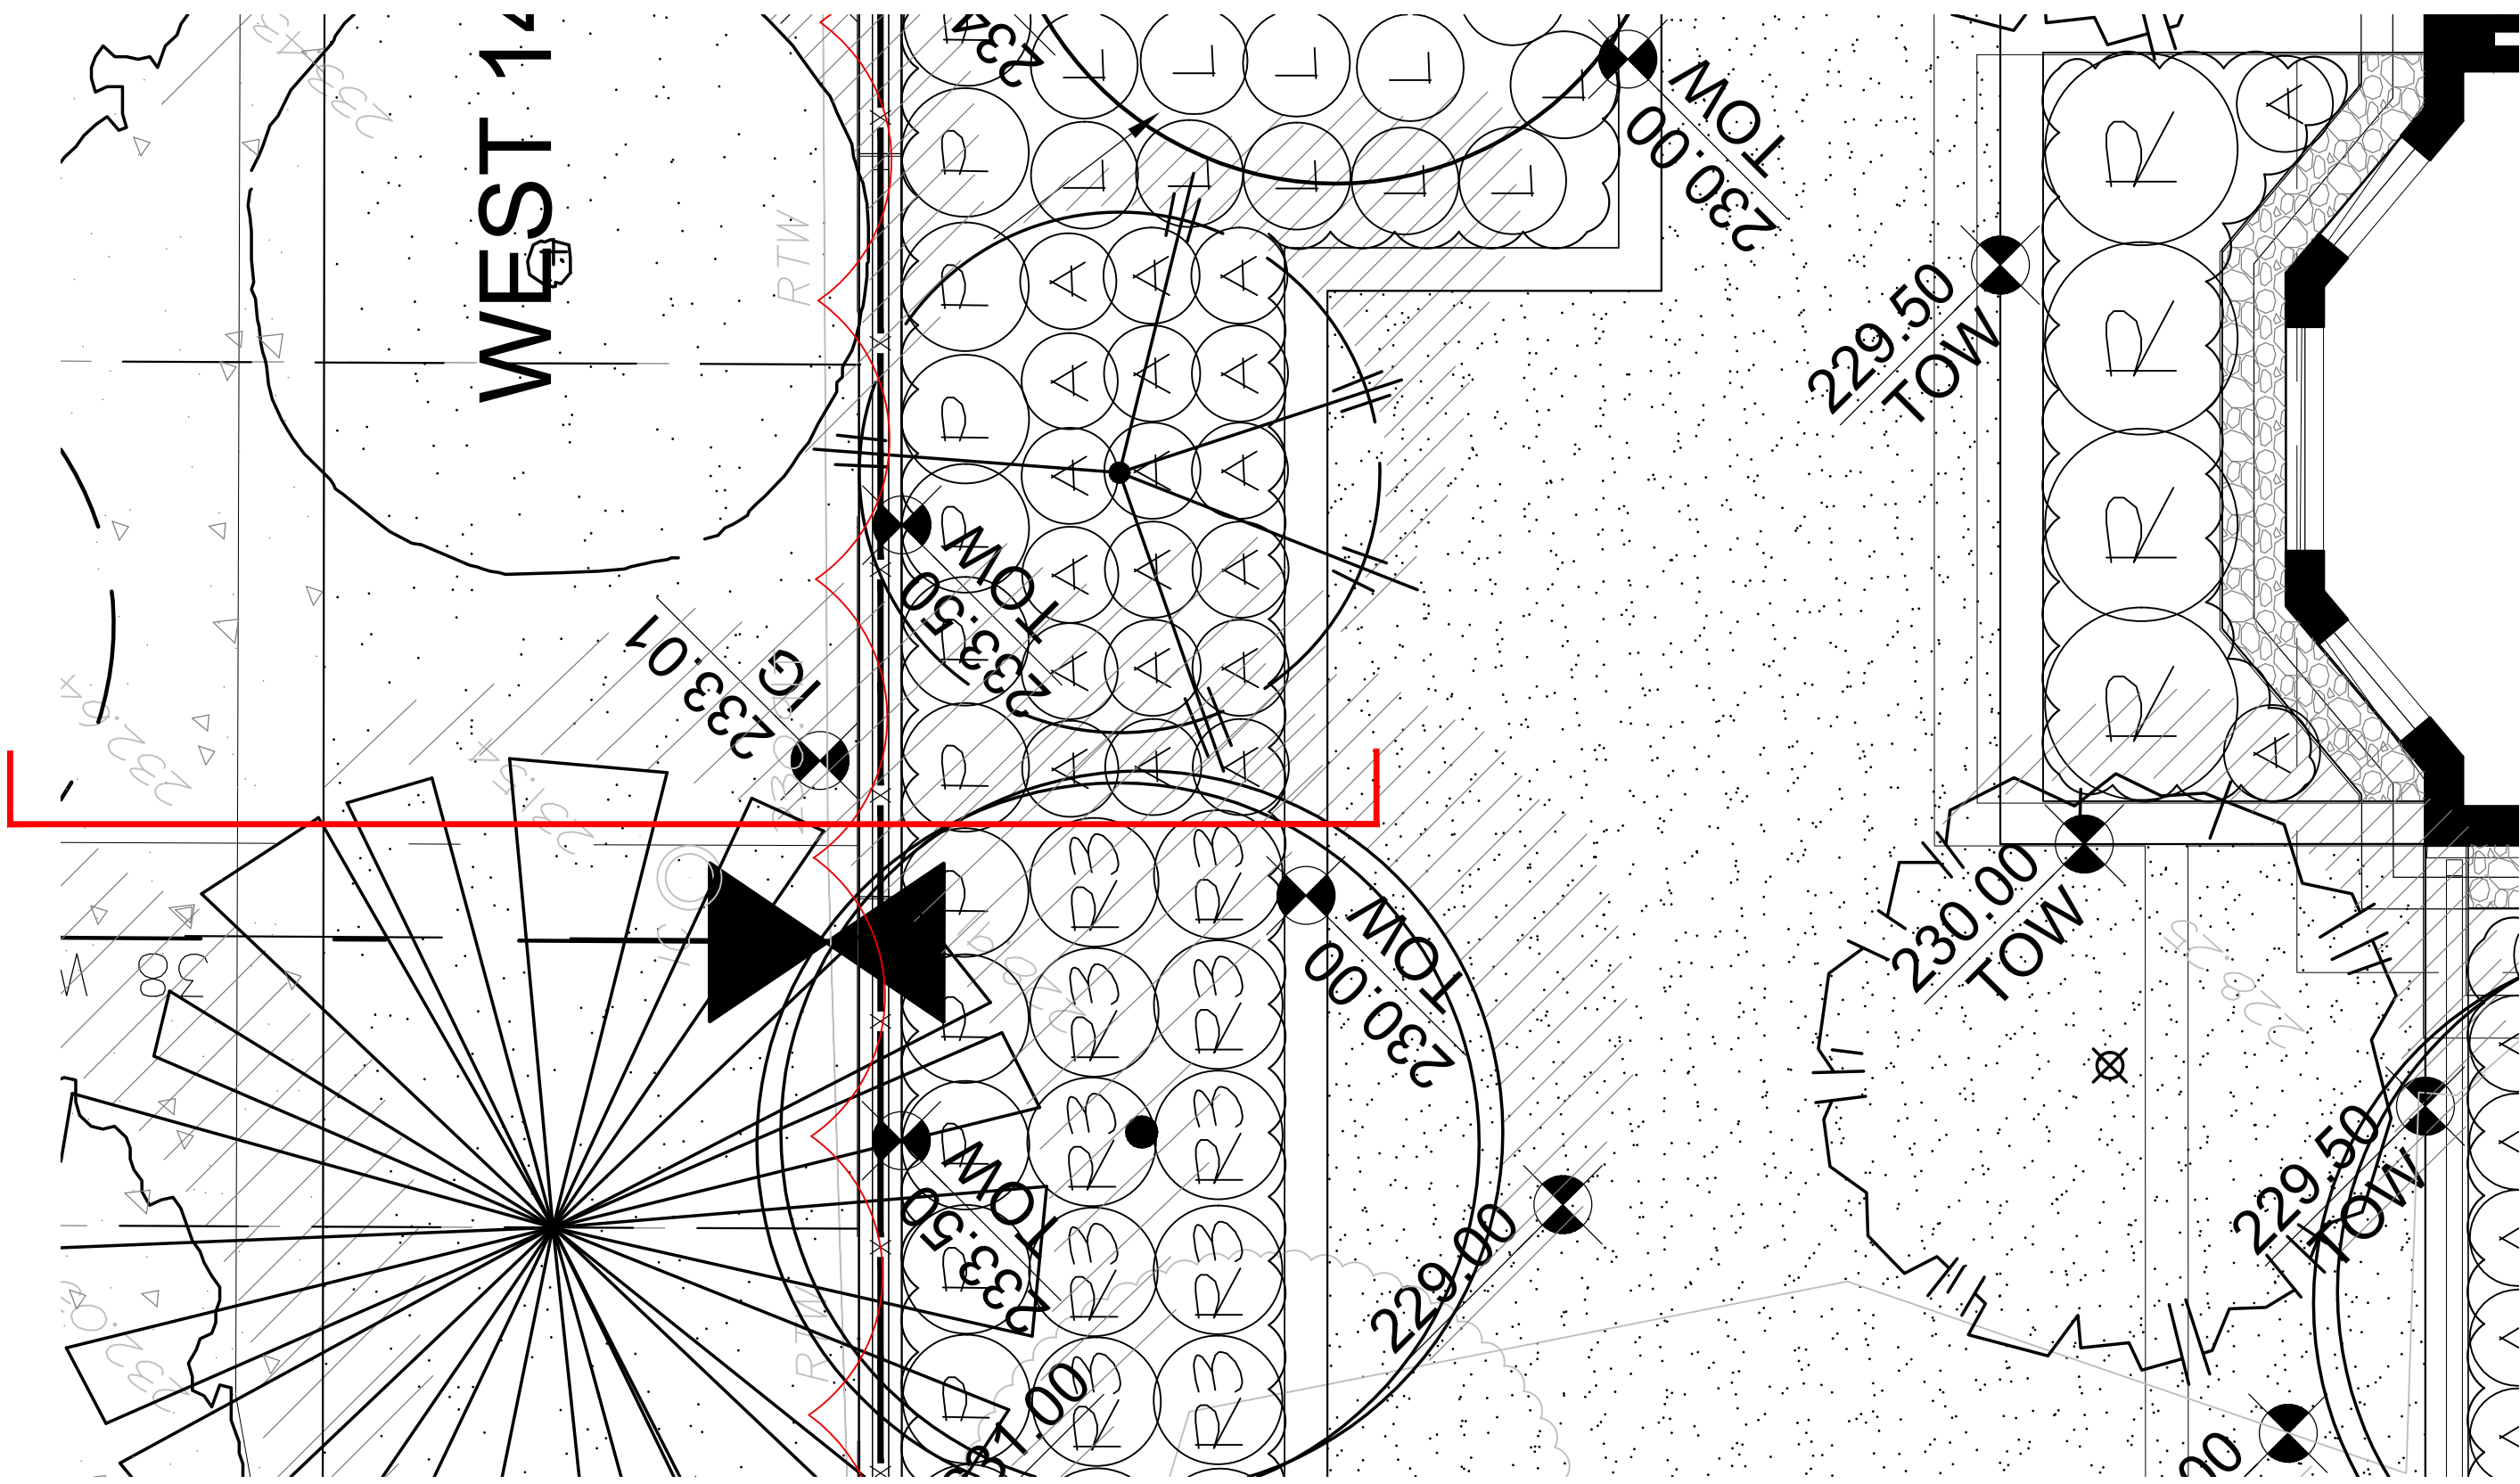
SEAL:

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311 W 14TH STREET
CITY OF NORTH VANCOUVER, BC

DRAWING TITLE:
**LANDSCAPE
SECTIONS**

DATE: JUL 1, 21/22	DRAWING NUMBER:
SCALE: 1"= 3/16"	L7
DRAWN: QL	
DESIGN: QL	
CHK'D: MTLM	

M2LA PROJECT NUMBER: 22-030



NOTE:
REFER TO STRUCTURAL
DRAWING FOR RETAINING
WALL DETAILS.


01 NORTH RETAINING WALL
L8

SCALE: 1"=1/4"

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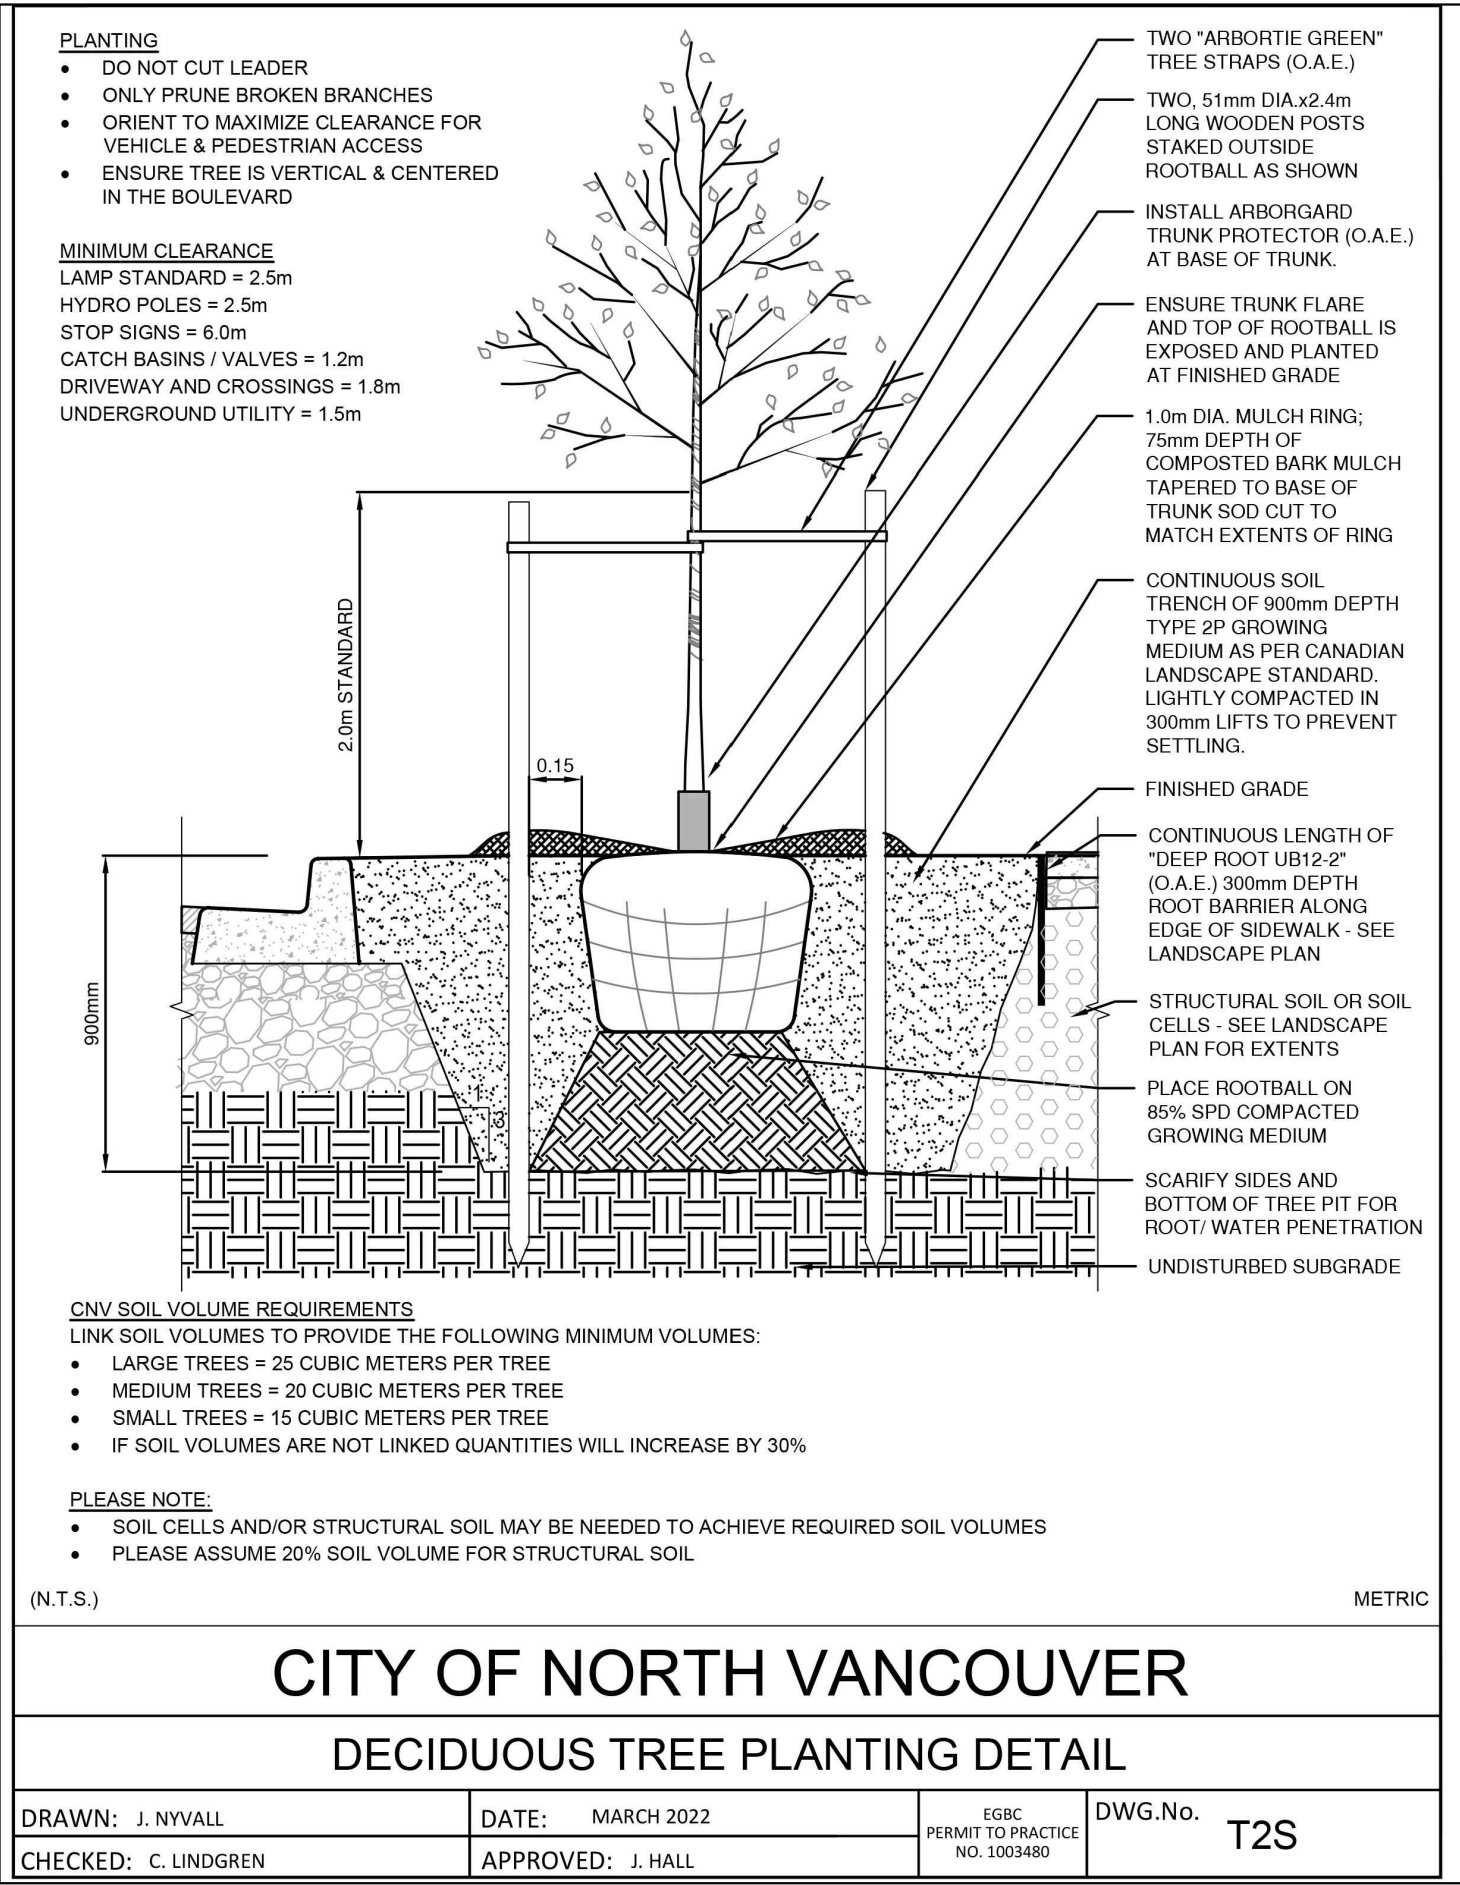
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NO.	DATE	REVISION DESCRIPTION	DR.

SEAL:

PROJECT:
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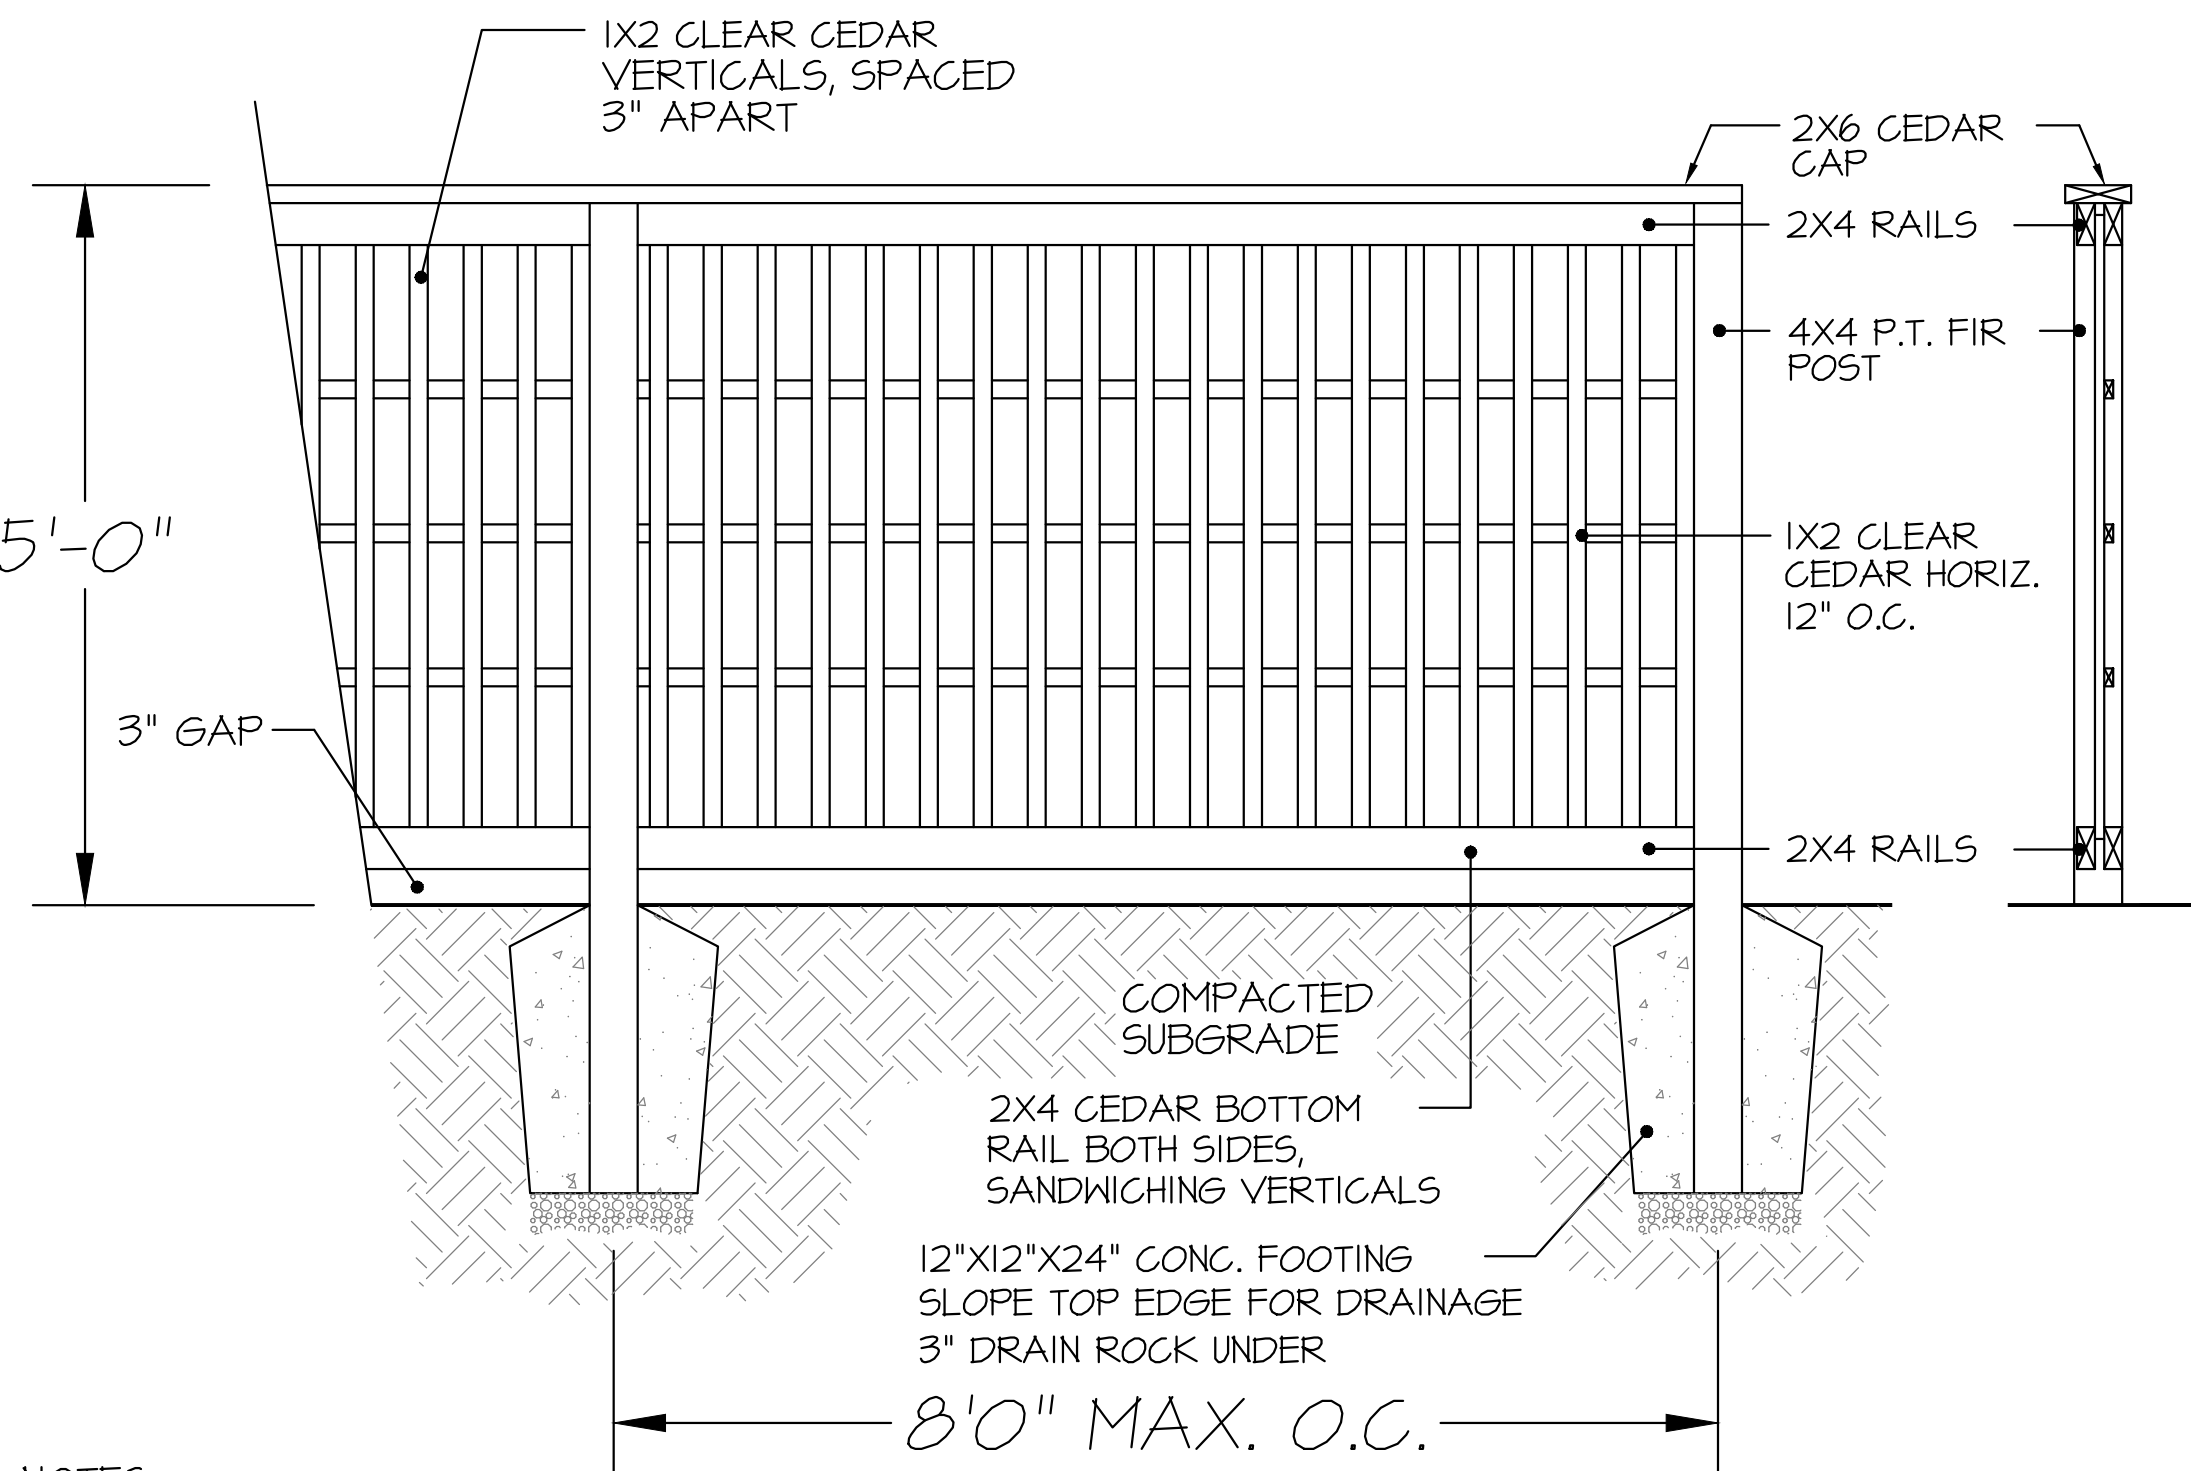
DRAWING TITLE:
**LANDSCAPE
SECTIONS**

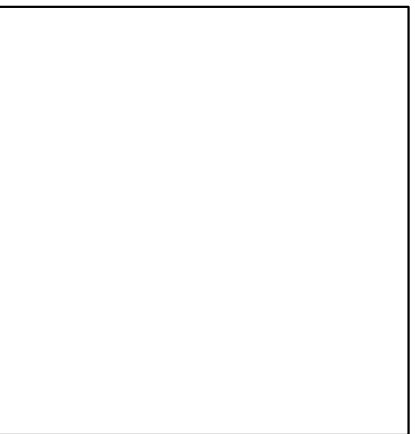DATE: JUL 17, 21, 22	DRAWING NUMBER:
SCALE: 1"= 3/16"	L8
DRAWN: QL	
DESIGN: QL	
CHK'D: MTLM	
M2LA PROJECT NUMBER:	OF 11 22-030



01 TREE PLANTING DETAIL

L9 SCALE: NTS



NOTES:


- ALL WOOD MEMBERS TO BE PRESSURE TREATED TO C.S.A. STANDARDS
- ALL HARDWARE TO BE HOT-DIPPED GALVANIZED
- APPLY TWO COATS OF STAIN TO MATCH BUILDING (TO BE APPROVED BY OWNER OR LANDSCAPE ARCHITECT)
- COAT ALL CUT SURFACES WITH SIMILAR PRESERVATIVE AS ABOVE

08 5 FT. HEIGHT PERIMETER FENCE

L9 SCALE: 3/4"=1'-0"

02 DRAIN ROCK STRIP AGAINST BUILDING

L9 SCALE: NTS

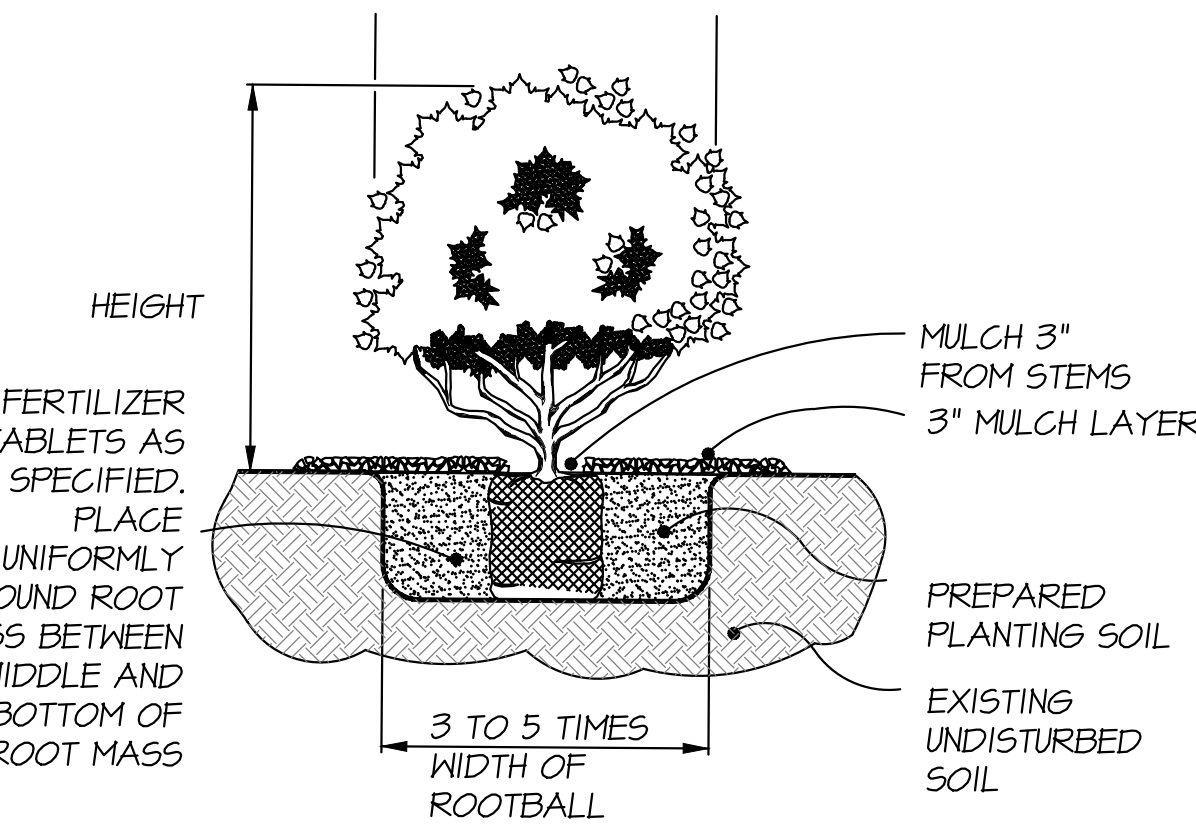


05 SHRUB PLANTING DETAIL

L9 SCALE: NTS

03 SCORE CUT CONCRETE AT GRADE DETAIL

L9 SCALE: 1-1/2"=1'-0"

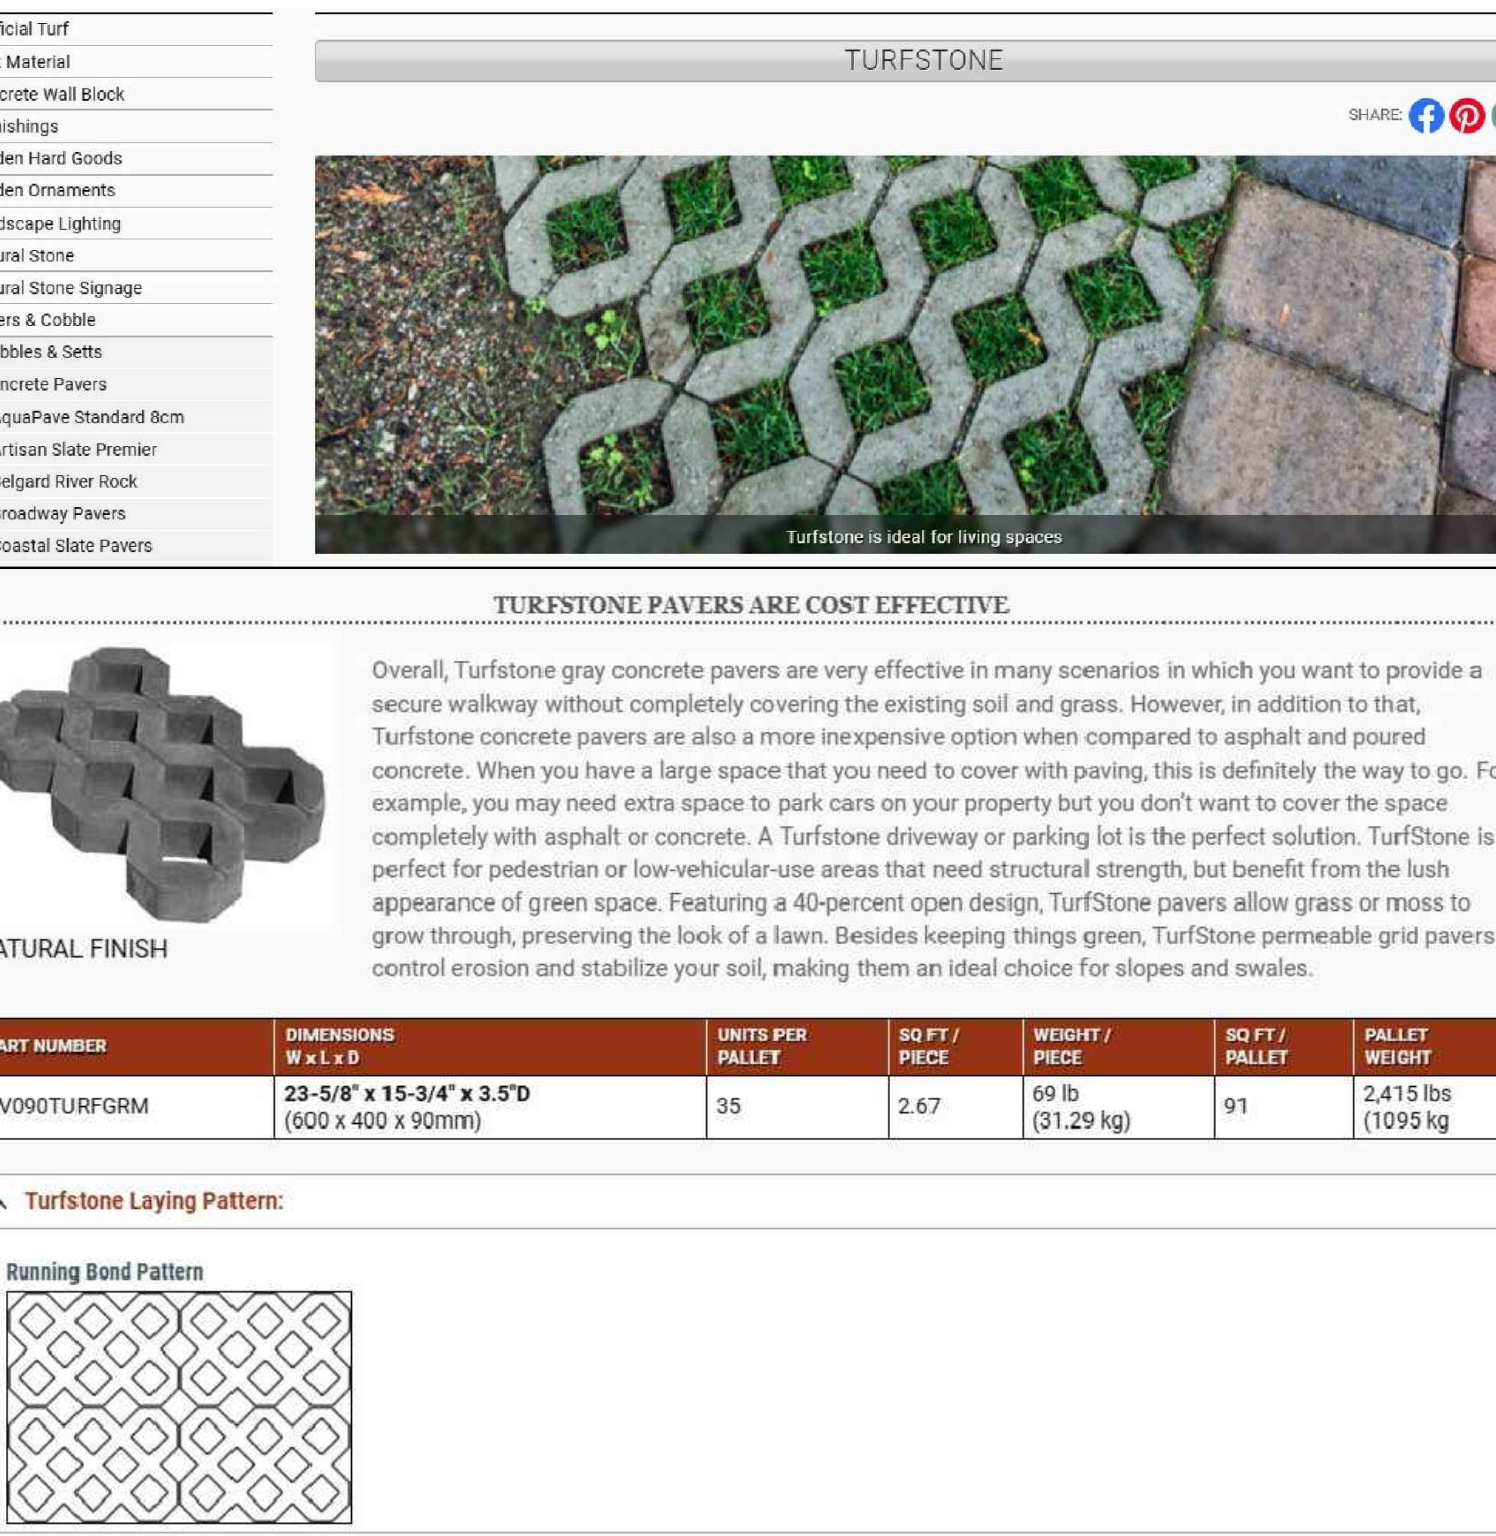


06 TURFSTONE BY NORTHWEST LANDSCAPE & STONE SUPPLY

L9


4 HYDRAPRESSED CONCRETE PAVERS AT GRADE

L9 SCALE: 3/4"=1'-0"

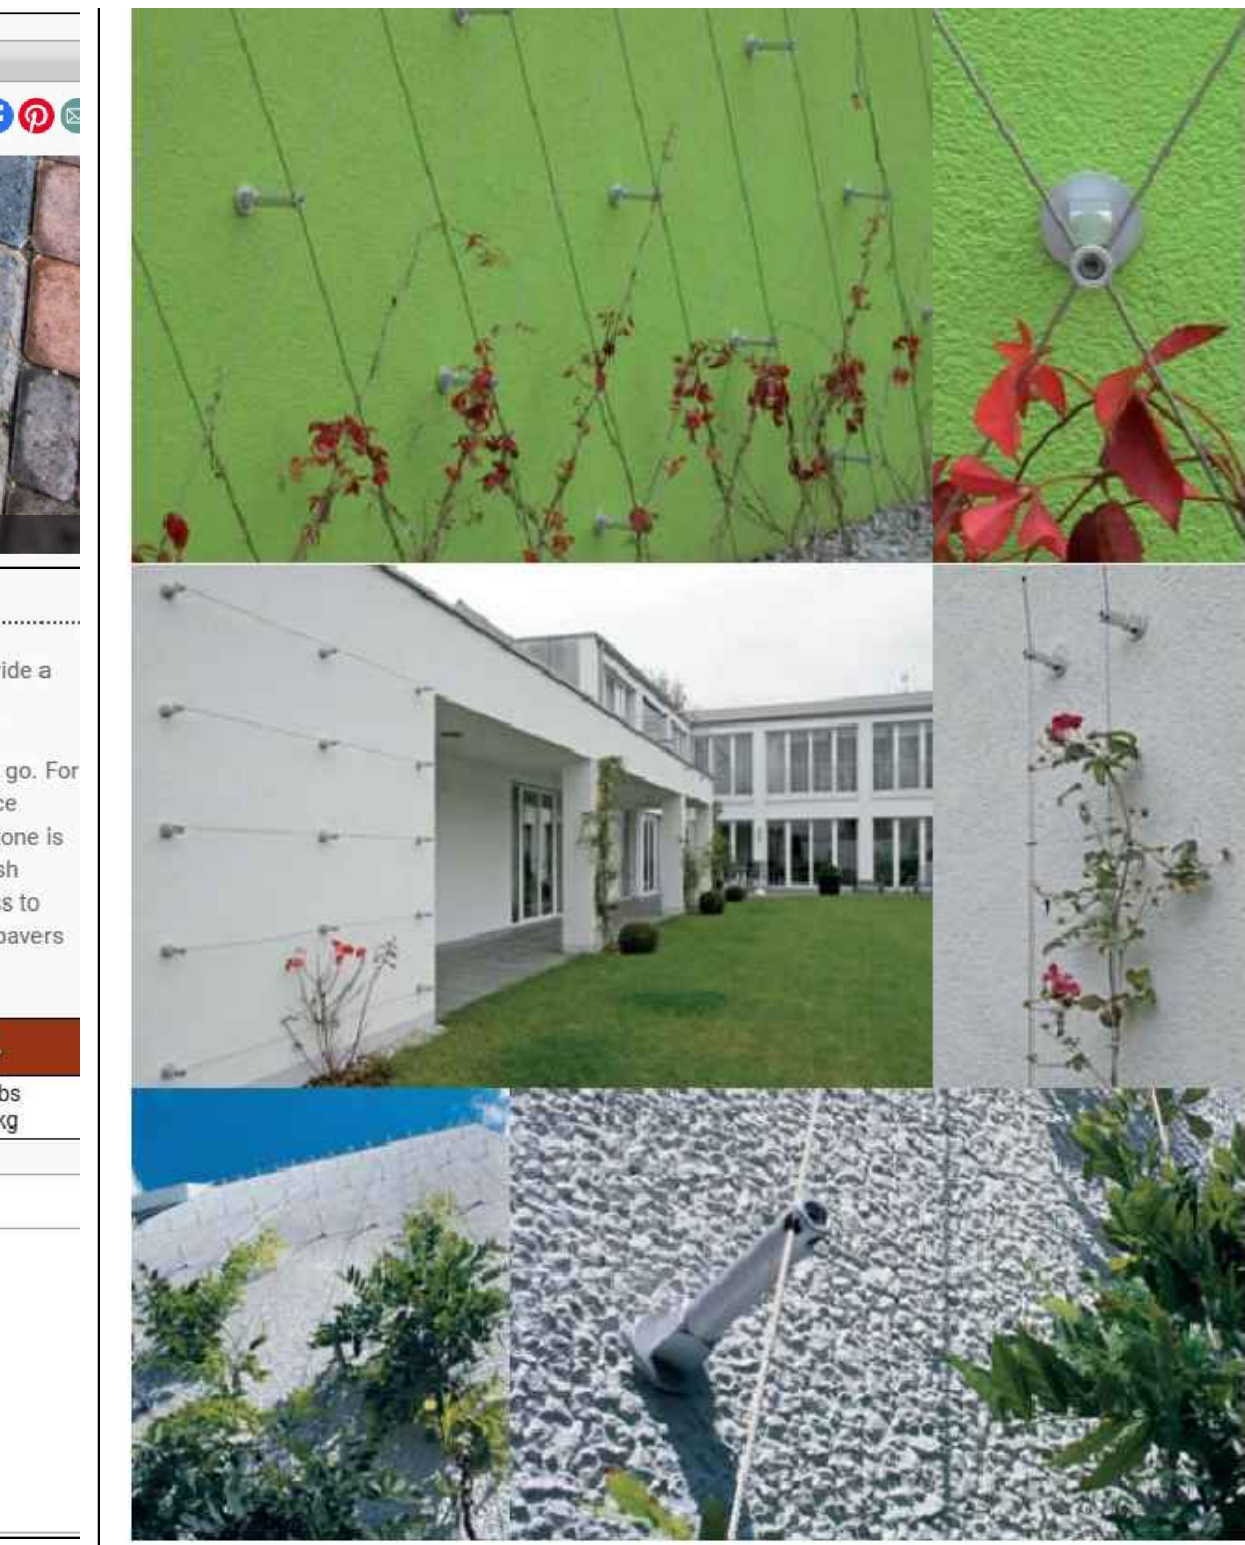

07 GREEN WALL WITH CABLE SYSTEM

L9

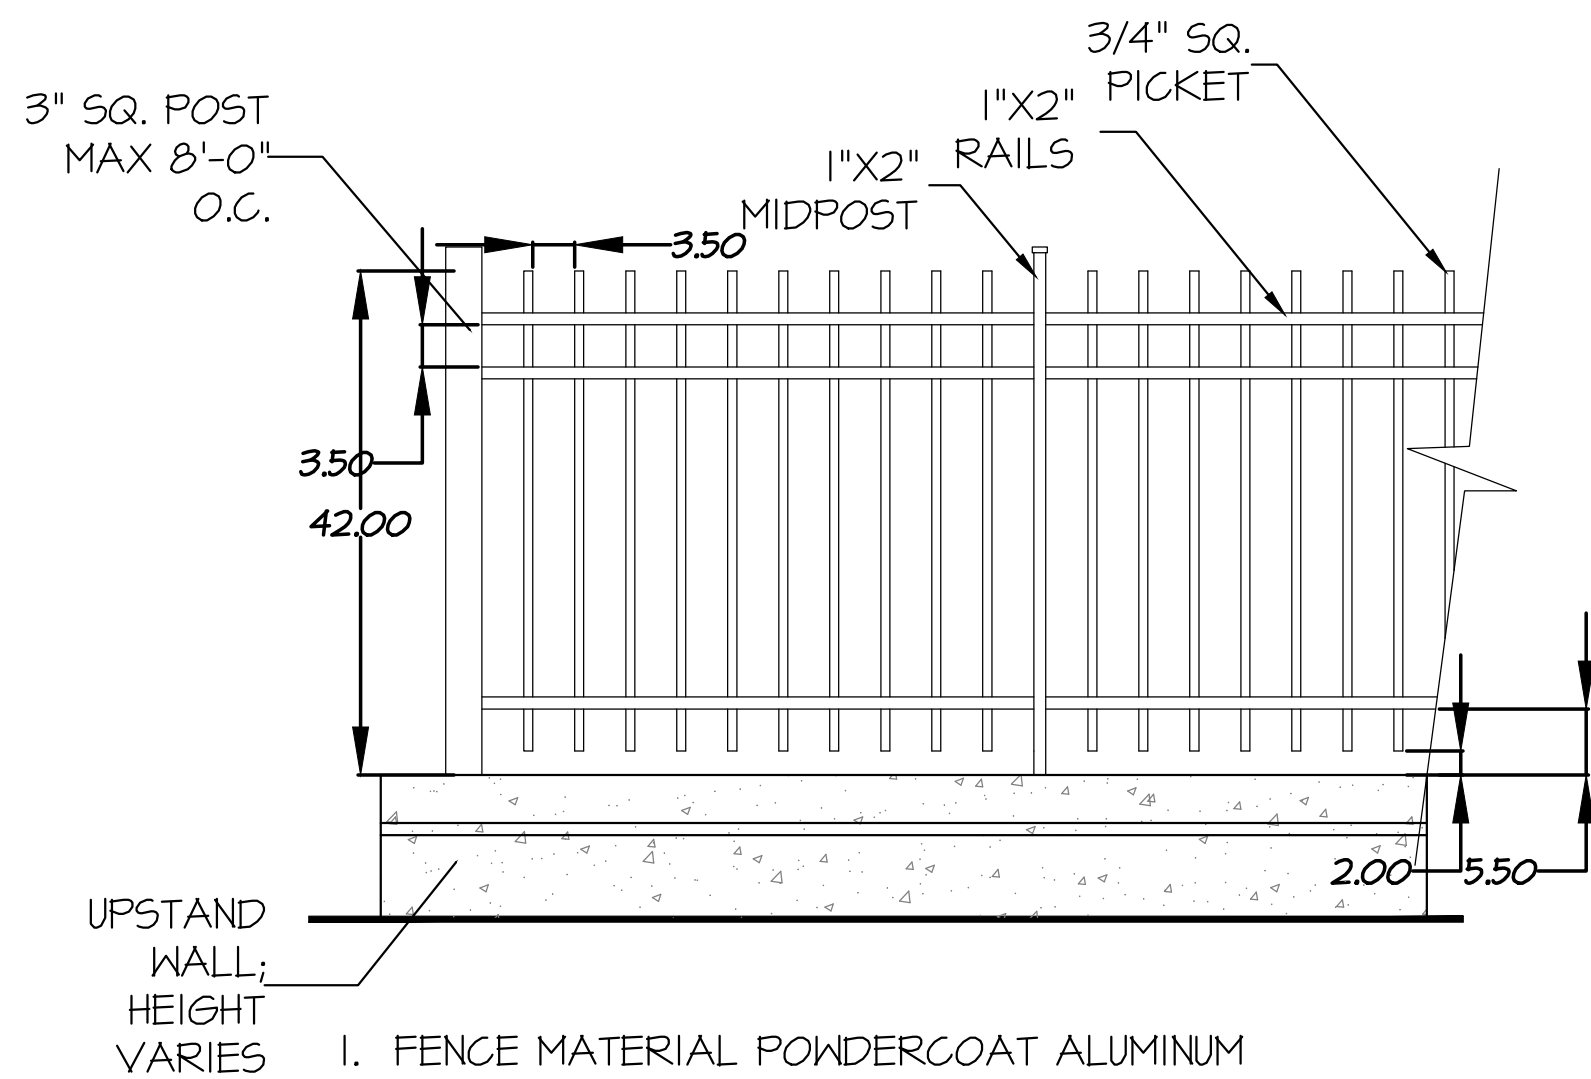

09 42" HT. METAL PICKET FENCE

L9 SCALE: 3/4"=1'-0"

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NO.	DATE	REVISION DESCRIPTION	DR.
11	2024-04-26	REVISED PER CITY COMMENTS	SH
10	2023-04-12	ISSUED FOR DP	QL
9	2023-07-12	ISSUED FOR DP	QL
8	2023-09-21	ISSUED FOR DP	QL
7	2023-09-09	ISSUED FOR DP	QL
6	2023-02-15	ISSUED FOR DP	QL
5	2023-08-16	ISSUED FOR DP	QL
4	2023-08-11	ISSUED FOR DP	QL
3	2023-08-05	ISSUED FOR DP	QL
2	2023-07-24	ISSUED FOR PRELIMINARY DESIGN	QL
1	2022-07-21	ISSUED FOR PRELIMINARY DESIGN	QL

SEAL:

PROJECT:
HERITAGE REVITALIZATION AND
NEW LOW ENERGY DUPLEX
311 W 14TH STREET
CITY OF NORTH VANCOUVER, BC

DRAWING TITLE:
**LANDSCAPE
DETAILS**

DATE: JUL 7, 21/22	DRAWING NUMBER:
SCALE: 1"= 3/16"	L9
DRAWN: QL	
DESIGN: QL	
CHK'D: MTLM	
M2LA PROJECT NUMBER:	22-030

PART ONE GENERAL REQUIREMENTS

11 REFERENCES

1. CCDC Doc 2 2008
Comply with all articles in the General Conditions of Contract in conjunction with this section unless superseded by other Contract Documents.
2. B.C. Landscape Standard, 7th edition 2008, prepared by the B.C. Society of Landscape Architects and the B.C. Landscape Nursery Association, jointly. All work and materials shall meet standards as set out in the B.C. Landscape Standard unless superseded by this specification or as directed by Landscape Architect with written instruction.
3. MASTER MUNICIPAL SPECIFICATIONS & STANDARD DETAILS, 2000 edition, prepared by the Consulting Engineers of British Columbia, Roadbuilders and Heavy Construction Association, and the Municipal Engineers Division
4. STANDARD FOR LANDSCAPE IRRIGATION SYSTEMS, 2008. Prepared by the Irrigation Industry Association of British Columbia.
5. MUNICIPAL BYLAWS AND ENGINEERING SPECIFICATIONS WHERE NOTED.

12 TESTING

1. A current test more than one month test for all growing medium to be used on this site is required. Provide and pay for testing by an independent testing facility pre-approved by the Landscape Architect. Deliver growing medium test results to Landscape Architect for review and approval prior to placement. Refer to Section 3.4 Growing Medium Testing for procedure.
2. Owner reserves the right to test or re-test materials. Contractor responsible to pay for testing if materials do not meet specification.

13 SUBMITTALS

1. Any alternate products differing from that contained in the contract documents must be pre-approved by the Landscape Architect.
2. Submittals to consist of product sample or manufacturer's product description.

14. SITE REVIEW

1. Under the terms of the Landscape Architect's Contract with the Owner and where the Landscape Architect is the designated reviewer, the Landscape Architect will observe construction as is necessary in their opinion to confirm conformance to the plans and specifications. Contact Owner Representative to arrange for site observation at the appropriate times. Allow two days notice. Observation schedule may include but will not be limited to the following:
 - 1.1 Start Up Site Meeting, General Contract: Prior to any site disturbance, a meeting with the general contractor to review tree preservation issues, general landscape issues and municipal requirements.
 - 1.2 Start Up Site Meeting, Landscape Contract (if separate): At the start of work with Owner's Representative, Site Superintendent and Landscape Contractor; a meeting is to be held to review expected work and to verify the acceptability of the subgrade and general site conditions to the Landscape Contractor. Provide growing medium test results for this meeting.
 - 1.3 Progress Site Visits: To observe materials and workmanship as necessary through the course of the work. Review of different aspects of the work may be dealt with on any single visit. Such elements may include: Site Layout, Rough Grading, Growing Medium - quality, depths, finish grading, Drainage and Drainage Materials; Lawns or Grass areas; Planting - plant material including negotiorals with suppliers, nursery inspections, plant sizes, quality, quantity, planning practice and layout, tree support; Mulch, Irrigation Systems, Play Equipment, Site Furniture, and other elements of the site development where the Landscape Architect is the designated reviewer such as: Pedestrian Paving, Fencing, Non-structural walls and slabs, Unit Paving.
 - 1.4 Substantial Performance Review: at work, accounting of all substitutions, deletions, plant counts, preparations of deficiency list, and recommendations for completion.
 - 1.5 Certificate of Completion: Upon the declaration of Substantial Performance, a recommendation for the issuance of the Certificate of Completion will be made to the Payment Certifier as defined in the contract.
 - 1.6 Deficiency Review: Prior to the completion of the holdback period, check for completion of deficiencies. Once completed, a Schedule "C" will be issued where required.
 - 1.7 Warranty Review: Prior to the completion of the warranty period (1-/- 11 months after issuance of the Certificate of Completion), review all warranty material and report recommendations for warranty replacement.

15 WORKMANSHIP

1. Unless otherwise instructed in the Contract Documents, the preparation of the subgrade shall be the responsibility of the General Contractor. Placement of growing medium constitutes acceptance of the subgrade by the Landscape Contractor. Any subsequent corrections to the subgrade required are the responsibility of the Landscape Contractor.
2. All work and superintendence shall be performed by personnel skilled in landscape contracting. In addition, all personnel applying herbicides and/or pesticides shall hold a current license issued by the appropriate authorities.
3. A site visit is required to become familiar with site conditions before bidding and before start of work.
4. Confirm location of all services before proceeding with any work.
5. Notify Landscape Architect of any discrepancies. Obtain approval from Landscape Architect prior to deviating from the plans.
6. Take appropriate measures to avoid environmental damage. Do not dump any waste materials into water bodies. Conform with all federal, provincial and local statutes and guidelines.
7. Collect and dispose of all debris and/or excess material from landscape operations. Keep paved surfaces clean and repair damage resulting from landscape work. Repairs are to be completed prior to final acceptance.
8. Where new work connects with existing, and where existing work is altered, make good to match existing undisturbed condition.

16 WARRANTIES

1. Guarantee all materials and workmanship for a minimum period of one full year from the date of Certificate of Completion.
2. Refer to individual sections for specific warranties.

PART TWO SCOPE OF WORK

21. SCOPE OF WORK

1. Other conditions of Contract may apply. Confirm Scope of Work at time of tender.
2. Work includes supply of all related items and performing all operations necessary to complete the work in accordance with the drawings and specifications and generally consists of the following:
 - 2.1 Retention of Existing Trees where shown on drawings.
 - 2.2 Finish Grading and Landscape Drainage
 - 2.3 Supply and placement of growing medium.
 - 2.4 Testing of imported growing medium and/or site topsoil.
 - 2.5 Supply and incorporation of additives to meet requirements of soil test and Table One.
 - 2.6 Preparation of planting beds, supply of plant material and planting.
 - 2.7 Preparation of rough grass areas, supply of materials and seedling.
 - 2.8 Preparation of lawn areas, supply of materials and sodding.
 - 2.9 Supply and placement of bark mulch.
 - 2.10 Maintenance of planted and seeded/sodded areas until accepted by Owner.
 - 2.11 SEPARATE PRICE: Establishment Maintenance, Section 3.11.
 - 2.12 Other work: Work other than this list, not specified by Landscape Architect.

2.2 MATERIALS

1. Growing Medium: Conform to BC Landscape Standard for definitions of imported and on-site topsoil. Refer to Table One below.

TABLE ONE: PROPERTIES OF GROWING MEDIUM FOR LEVEL 2 GROWNED AND LEVEL 3 MODERATE AREAS Canadian System of Soil Classification Textural Class "Loamy Sand" to "Sandy Loam"				
Applications	Low Traffic Areas: Trees and Large Shrubs	High Traffic Areas: Lawn Areas	Planting Areas and Planters	
Growing Medium Types	2L	2H	2P	
Percent Of Dry Weight Of Total Growing Medium				
Texture				
Coarse Gravel: larger than 25mm	0 - 1%	0 - 1%	0 - 1%	
All Gravel: larger than 2mm	0 - 5%	0 - 5%	0 - 5%	
Percent Of Dry Weight Of Growing Medium Excluding Gravel				
Sand: larger than 0.05mm smaller than 2.0mm	50 - 80%	70 - 90%	40 - 80%	
Silt: larger than 0.002mm smaller than 0.05mm	10 - 25%	0 - 15%	10 - 25%	
Clay: smaller than 0.002mm	0 - 25%	0 - 15%	0 - 25%	
Clay and Silt Combined	maximum 35%	maximum 15%	maximum 35%	
Organic Content (least):	3 - 10%	3 - 5%	10 - 20%	
Organic Content (interior):	3 - 5%	3 - 5%	15 - 20%	
Acidity (pH)	6.0 - 7.0	6.0 - 7.0	4.5 - 6.5	
Drainage:	Percolation shall be such that no standing water is visible 60 minutes after at least 10 minutes of moderate to heavy rain or irrigation.			

2. Fertilizer: An organic and/or inorganic compound containing Nitrogen (N), Phosphate (P), and Potash (Soluble P) in proportions required by soil test.
3. Lime: Ground agricultural limestone. Meet requirements of the B.C. Landscape Standard.
4. Organic Additive: Commercial compost product to the requirements of the B.C. Landscape Standard, 6th edition and pre-approved by the Landscape Architect. Recommended suppliers: The Answer Garden Products, Fraser Richmond Soils & Fire, Stream Organics Management.
5. Sand: Clean, washed pump sand to meet requirements of the B.C. Landscape Standard.
6. Composted Bark Mulch: 10mm (3/8") minus Fir/Hemlock bark chips and fines, free of chunks and sticks, dark brown in colour and free of all soil, stones, roots or other extraneous matter. Fresh orange in colour bark will be rejected.
7. Herbicides and Pesticides: If used, must conform to all federal, provincial and local statutes. Applicators must hold current licenses issued by the appropriate authorities in the area.
8. Filter Fabric: A non biodegradable blanket or other filtering membrane that will allow the passage of water but not fine soil particles. (Such as HIRAFI 140 NL, GEOLON N40 OR AMOCO 4545 or alternate product pre-approved by the Landscape Architect.)
9. Drainage Piping if required: Schedule 40 PVC nominal sizes.
10. Drain Rock: Clean, round, inert, durable, and have a maximum size of 19mm and containing no material smaller than 10mm.
11. Plant Material: To the requirements of the B.C. Landscape Standard. Refer to 3.3, Plants and Planting. All plant material must be provided from a certified disease free nursery. Provide proof of certification.
12. Sod: Refer to individual sections in this specification.
13. Supplier and installers of segmental block walls to provide engineered drawings for all walls; signed and sealed drawings for all walls, individually, in excess of 12m, or combinations of walls collectively in excess of 12m. Installations must be reviewed and signed off by Certified Professional Engineer, include cost of engineering services in tender price.
14. Miscellaneous: Any other material necessary to complete the project as shown on the drawings and described herein.

PART THREE SOFT LANDSCAPE DEVELOPMENT

3.1 RETENTION OF EXISTING TREES

1. Prior to any work on site - protect individual trees or plant groupings indicated as retained on landscape plans as vegetation retention areas.
1. In some instances the Landscape Architect will tag trees or areas to retain. Discuss tree retention areas at a start-up meeting with the Landscape Architect.
2. A physical barrier must be installed to delineate clearing boundaries. Refer to physical barrier detail. If detail not provided, comply with local municipal requirements.
3. No machine travel through or within vegetation retention areas or under crowns of trees to be retained is allowed.
4. Do not stockpile soil, construction materials, or excavated materials within vegetation retention areas.
5. Do not park, fuel or service vehicles within vegetation retention areas.
6. No debris fires, clearing fires or trash burning shall be permitted within vegetation retention areas.
7. No excavations, drain or service trenches nor any other disruption shall be permitted within vegetation retention areas without a review of the proposed encroachment by the Landscape Architect.
8. Do not cut branches or roots of retained trees without the approval of the Landscape Architect.
9. Any damage to existing vegetation intended for preservation will be subject to evaluation by an I.S.A. Certified Arborist using the "Guide for Plant Appraisal", Eighth Edition, 1992.
- 9.1 Replacement planting of equivalent value to the disturbance will be required. The cost of the evaluation and of the replacement planting will be the responsibility of the General Contractor and/or the person(s) responsible for the disturbance.
10. In municipalities with specific tree retention/replacement bylaws ensure compliance to bylaws.
11. In situations where required construction may disturb existing vegetation intended for preservation, contact Landscape Architect for review prior to commencing construction.

3.2 GRADES

1. Ensure subgrade is prepared to conform to depths specified in Section 3.5, Growing Medium Supply, below. Where planting is indicated close to existing trees, prepare suitable planting pockets for material indicated on the planting plan. Shape subgrade to eliminate free standing water and conform to the site grading and drainage plan.
2. On slopes in excess of 3:1 trench subgrade across slope to 150mm (6") minimum at 15m (5 ft.) intervals minimum.
3. Scarify the entire subgrade immediately prior to placing growing medium. Re-cultivate where vehicular traffic results in compaction during the construction procedures. Ensure that all planting areas are smoothly contoured after light compaction to finished grades.
4. Eliminate standing water from all finished grades. Provide a smooth, firm and even surface and conform to grades shown on the Landscape Drawings. Do not exceed maximum and minimum gradients defined by the B.C. Landscape Standard.
5. Construct swales true to line and grade, smooth and free of spots or high points. Minimum slope 2%, maximum side slopes 10%. Assure positive drainage to collection points.
6. Slope not to exceed the following maximums: Rough Grass 3:1; Lawn 4:1; Landscape plantings 2:1.
7. Finished soil/mulch elevation at building to comply with municipal requirements.
8. Inform Landscape Architect of completion of finished grade prior to placement of seed, sod, plants or mulch.

3.3 LANDSCAPE DRAINAGE

1. Related Work: Growing medium and Finish Grading, Grass areas, Trees Shrubs and Groundcovers, Planters, Crib Walls.
2. Work Included: Site finish grading and surface drainage. Installation of any drainage systems detailed on landscape plans. Note: Catch basins shown on landscape plans for coordination only, confirm scope of work prior to bid.
- 2.1 Coordinate all landscape drainage work with rest of site drainage. Refer to engineering drawings and specifications for connections and other drainage work.
- 2.2 Determine exact location of all existing utilities and structures and underground utilities prior to commencing work, which may not be located on drawings and conduct work so as to prevent interruption of service or damage to them. Protect existing structures and utility services and be responsible for damage caused.
- 2.3 Planter drains on slab: Refer to Section 3.8, Installing Landscapes on Structures.
3. Execution
 - 3.1 Do trenching and backfilling in accordance with engineering details and specifications.
 - 3.2 Lay drains on prepared bed, true to line and grade with inverts smooth and free of spots or high points. Ensure barrel of each pipe is in contact with bed throughout full length.
 - 3.3 Commence laying pipe at outlet and proceed in upstream direction.
 - 3.4 Lay perforated pipes with perforations at 8pm and 4pm positions.
 - 3.5 Make joints tight in accordance with manufacturer's directions.
 - 3.6 Do not allow water to flow through the pipes during construction except as approved by Engineer.
 - 3.7 Make watertight connections to existing drains, new or existing manholes or catchbasins where indicated or as directed by Landscape Architect.
 - 3.8 Plug upstream ends of pipe with watertight clean out caps.
 - 3.9 Surround and cover pipe with drain rock in uniform 150mm layers to various depths as shown in details, minimum 100mm.
 - 3.10 Cover drain rock with non-woven filter cloth lap all edges and seams minimum 150mm.
 - 3.11 Assure positive drainage.
 - 3.12 Back fill remainder of trench as indicated.
 - 3.13 Protect subdrains from flotation during installation.

3.4 GROWING MEDIUM TESTING

1. Submit representative sample of growing medium proposed for use on this project to an independent laboratory. Provide test results to Landscape Architect prior to placing. Test results to include:
 - 1.1 Physical properties, % content of gravel, sand, silt, clay and organics.
 - 1.2 Acidity (pH) and quantities of lime or sulphur required to bring within specified range.
 - 1.3 Nutrient levels of principle and trace elements and recommendations for required soil amendments.
 - 1.4 Carbon/Nitrogen level.

3.5 GROWING MEDIUM SUPPLY AND PLACEMENT

1. Supply all growing medium required for the performance of the Contract. Do not load, transport or spread growing medium when it is so wet that its structure is likely to be damaged.
2. Supply all growing medium admixtures as required by the soil test. Amended growing medium must meet the specification for growing medium as defined in Table One for the various areas.
- 2.1 Thoroughly mix required amendments into the full depth of the growing medium.
- 2.2 Special mixes may be required for various situations. Refer to drawing notes for instructions.
3. Place the amended growing medium in all grass and planting areas. Spread growing medium in uniform layers not exceeding 6" (150mm), over unfrozen subgrade free of standing water.
 4. Minimum depths of growing medium placed and compacted to 80%:
 - 4.1 On-grade:
 - 4.1.1 Seeded and sodded lawn: 10" (450mm)
 - 4.1.2 Moss planted shrubs & groundcovers: 18" (450mm)
 - 4.1.3 Groundcover only areas, if defined on plan: 18" (450mm)
 - 4.1.4 Tree & large shrub pits: _____ depth to conform to depth of rootball - width shall be at least twice the width of the root ball with saucer shaped sides.
 - 4.2 On-Slab:
 - 4.2.1 Irrigated lawn: 9" (210mm)
 - 4.2.2 Groundcover areas: 12" (300mm)
 - 4.2.3 Lawn without automatic irrigation: 12" (300mm)
 - 4.2.4 Shrub & groundcover areas: 15" (380mm)
 - 4.2.5 Trees and specimen shrubs: 30" (760mm) over columns and/or edge of slab (verify column locations on-site for tree locations)
 - 4.2.6 Depth noted includes 1" to 2" (25-50mm) sand over filter fabric.
 - 4.2.7 Maximum 18" depth growing medium except where rounded for trees over column points.
 5. Manually spread growing medium/planting soil around existing trees, shrubs and obstacles.
 6. In perimeter seeded grass areas, feather growing medium out to nothing at edges and blend into existing grades.
 7. Finished grades shall conform to the elevations shown on landscape and site plans.

3.6 ROUGH GRASS AREA - SEEDING

1. General: Rough grass areas are noted on the drawings as "Rough Grass". Treat all areas defined as rough grass between all property lines of the project including all boulevards to edge of roads and lanes.
2. Preparation of Surface: To B.C. Landscape Standard (Class 3 Areas (Rough Grass) Section 7.1.13
 - 2.1 Clean existing soil by mechanical means of debris over 50mm in any dimension.
 - 2.2 Roughly grade surfaces to allow for maintenance seeding and for positive drainage.
3. Time of Seeding: Seed from early spring (generally April 1st) to late fall (September 15th) of each year. Further extensions may be obtained on concurrence of the Landscape Architect.
4. Seed Supply & Testing: All seed must be obtained from a recognized seed supplier and shall be No. 1 grass mixture delivered in containers bearing the following information:
 - 4.1 Analysis of the seed mixture
 - 4.2 Percentage of each seed type
5. Seed Mixture: All varieties shall be rated as strong performers in the Pacific Northwest and are subject to client approval.

70% Creeping Red Fescue
20% Annual Ryegrass
5% Saline Perennial Ryegrass
5% Kentucky Bluegrass

For Wildflower Areas use a mixture of Wildflowers with Hard Fescues (Terralink Coastal Wildflowers) with Hard Fescue or pre-approved alternate.
6. Fertilizer: Mechanical seeding: Apply a complete synthetic slow-release fertilizer with maximum 35% water soluble nitrogen and a formulation ratio of 18-18-18 - 50% sulphur urea coated, 112 kg/ha(100lbs/acre) using a mechanical spreader.
7. Seeding: Apply seed at a rate of 112x/H (100lbs /acre) with a mechanical spreader. Incorporate seed into the top 1/4" (6mm) of soil and lightly compact.
8. Acceptance: Provide adequate protection of the seeded areas until conditions of acceptance have been met. Comply with Section 3.7 Hydroseeding.

3.7 HYDROSEEDING

1. May be used as an alternate to mechanical seeding in rough grass areas.
2. May not be used in areas of lawn unless pre-approved by the Landscape Architect prior to bidding.
3. Preparation and Growing Medium
 - 3.1 In areas of Rough Grass: Comply with Section 3.6 Rough Grass.
 - 3.2 Where approved for use in areas of lawn, comply with Section 3.8 Lawn Areas: Sodding.
4. Pre-tension: Ensure that fertilizer in solution does not come in contact with the foliage of any trees, shrubs, or other susceptible vegetation. Do not spray seed or mulch on objects not expected to grow grass. Protect existing site equipment, roadways, landscaping, reference points, monuments, markers and structures from damage. Where contamination occurs, remove seeding slurry by satisfaction of any means approved by the Landscape Architect
5. Mulch should consist of virgin wood fibre or recycled paper fibre designed for hydraulic seeding and dyed for ease of monitoring application. If using recycled paper material for wood fibre substitute use 15% by weight). Conform to B.C. Landscape Standard for mulch requirements.
6. Water: Shall be free of any impurities that may have an injurious effect on the success of seeding or may be harmful to the environment.
7. Equipment: Use industry standard hydraulic seeder/mulcher equipment with the tank volume certified by an identification plate or sticker affixed to main view on the equipment. The hydraulic seeder/mulcher shall be capable of sufficient agitation to mix the material into a homogeneous slurry and to maintain the slurry in a homogeneous state until it is applied. The discharge pumps and gun nozzles shall be capable of applying the materials uniformly over the designated area.

PART THREE SOFT LANDSCAPE DEVELOPMENT - CONT

8. Application Rate:
 - 8.1 Seed Mixture: 136 kg/ha (125 lbs/acre)
 - 8.2 Fertilizer: 102 kg/ha (100 lbs/acre)
 - 8.3 Coastal Wildflower Mix: Where specified, apply (31 lbs/acre) 1/4 lb.: 1 lb. of grass seed)
 - 8.4 Notes:
 - 8.4.1 At the time of Tender provide a complete chart of all components of the mix proposed including mulch, tackifier, water etc. Sloped sites require tackifier.
 - 8.4.2 Fertilizer:
 - 8.4.2.1 Rough Grass: If a soil analysis is available, comply with results.
 - 8.4.2.2 Lawn: Where hydroseeding is approved, comply with soil analysis recommendations.
9. Accurately measure the quantities of each of the materials to be charged into the tank either by mass or by a commonly accepted system of mass-calibrated volume measurements. The materials shall be added to the tank while it is being filled with water, in the following sequence; seed, fertilizer. Thoroughly mix into a homogeneous slurry. After charging, add no water or other material to the mixture. Do not leave slurry in the tank for more than four (4) hours.
10. Distribute slurry uniformly over the surface of the area to be hydroseeded. Blend application into previous applications and existing grass areas to form uniform surfaces.
11. Clean up: Remove all materials and other debris resulting from seeding operations from the job site.
12. Maintenance: Begin maintenance immediately after seeding and continue for 60 days after Substantial Completion and until accepted by the Owner. Re-seed at three week intervals where germination has failed: Protect seeded areas from damage with temporary wire or twine fences complete with signage until grass area is taken over by the Owner. Water in sufficient quantities to ensure deep penetration and at frequent intervals to maintain vigorous growth until grass is taken over by the Owner. It is the Owner's responsibility to supply water at no extra cost to the Contract.
13. Acceptance of the Rough Grass Areas: Proper germination of all specified grass species is the responsibility of the Landscape Contractor. The grass shall be reasonably well established, with no apparent dead or bare spots and shall be reasonably free of weeds (to B.C. Landscape Standard, Section 13 Maintenance Level 4 (Open space). Sixty days after substantial completion, areas meeting the conditions above will be taken over by the Owner. Areas seeded in Fall will be accepted in Spring one month after start of growing season, provided that the above conditions for acceptance are fulfilled.

3.8 LAWN AREAS - SODDING

1. General: Treat all areas defined as lawn areas on the landscape plan between all property lines of the project including all boulevards to edge of roads and lanes.
2. Growing Medium: Comply with Section 2.2.1, Growing Medium. Prior to sodding, request an inspection of the finished grade, and depth and condition of growing medium by the Landscape Architect.
3. Time of Sodding: Sod from April 1st to October 1st. Further extensions may be obtained on concurrence of the Landscape Architect.
4. Sod Supply: Conform to all conditions of B.C. Landscape Standard, Section 8, B.C. Standard for Turfgrass Sod.
5. Specified Turfgrass by area: Refer to Table 2 below.

TABLE 2 SPECIFIED TURFGRASS BY AREA			
Area	Description	Quality Grade	Major Species
CLASS 1	Lawn, all areas noted on drawings as lawn in urban development sites including boulevard grass	No. 1 Premium	Kentucky Blue for sun, Fescues for shade
CLASS 2	Grass - public parks, industrial and institutional sites	No. 2 Standard	same
CLASS 3	Rough Grass	see hydroseeding	
SPECIAL			

6. Line: The line shall be as defined in Section 2.2.3, Materials. Apply at rates recommended in required soil test. Refer to Section 3.4 for method.

7. Fertilizer: Refer to Section 2.2.2, Materials. Apply specified fertilizer at rates shown in the required soil test. Apply with a mechanical spreader. Cultivate into growing medium 48 hours prior to sodding. Apply separately from lime.
8. Sodding: Prepare a smooth, firm, even surface for laying sod. Lay sod staggered with sections closely butted, without overlapping or gaps, smooth and even with adjoining areas and roll lightly. Water to obtain moisture penetration of 3" to 4" (75 - 10cm). Comply with requirements of B.C. Landscape Standard Section 8, B.C. Standard for Turfgrass Sod.
9. Maintenance: Begin maintenance immediately after sodding and continue for 60 days after Substantial Completion and until accepted by the Owner. Protect sodded areas from damage with temporary wire or twine fences complete with signage until lawn is taken over by the Owner. Water to obtain moisture penetration of 3" to 4" (75-10cm) at intervals necessary to maintain sufficient growth. Keep grass cut at height of between 1-1/2" (1cm) and 2" (5cm). Provide adequate protection of sodded areas against damage until the turf has been taken over by Owner. Repair any damaged areas, re-grade as necessary. Aeration may be required if in the Landscape Architect's opinion, drainage through the sod base medium is impaired.
10. Acceptance of Lawn Areas: The turf shall be reasonably well established, with no apparent dead spots or bare spots and shall be reasonably free of weeds (to B.C. Landscape Standard, Section 13 Maintenance Level 2 (Approved Lawn)).

3.9 PLANTS AND PLANTING

1. Conform to planting layout as shown on Landscape Plans.
2. Obtain approval of Landscape Architect for layout and preparation of planting prior to commencement of planting operations.
3. Make edge of beds with smooth clean defined lines.
4. Time of Planting:
 - 4.1 Plant trees, shrubs and groundcovers only during periods that are normal for such work as determined by local weather conditions when seasonal conditions are likely to ensure successful adaptation of plants to their new location.
5. Standards:
 - 5.1 All plant material shall conform to the requirements of the B.C. Landscape Standard, 7th edition 2008, unless exceeded by drawing Plant Schedule or this specification.
 - 5.1.1 Refer to B.C. Landscape Standard, Section 9, Plants and Planting and in Section 12, BC/LMA Standard for Container Grown Plants for minimum standards.
 - 5.1.2 Refer to Plant Schedule for specific plant and container sizes and comply with requirements.
 - 5.2 Plant material obtained from areas with less severe climatic conditions shall be grown to withstand the site climate.
6. Review:
 - 6.1 Review at the source of supply and/or collection point does not prevent subsequent rejection of any or all planting stock at the site.
7. Availability:
 - 7.1 Area of search includes the Lower Mainland and Fraser Valley. Refer to Plant Schedule for any extension of area.
 - 7.2 Supply proof of the availability of the specified plant material within 30 days of the award of the Contract.
8. Substitution:
 - 8.1 Obtain written approval of the Landscape Architect prior to making any substitutions to the specified material. Non-approved substitutions will be rejected.
 - 8.2 Allow a minimum of 5 days prior to delivery for request to substitute.
 - 8.3 Substitutions are subject to BC Landscape Standard - definition of Conditions of Availability.
9. Plant Species & Location:
 - 9.1 Plants shall be true to name and of the height, caliper and size of root ball as shown on the landscape/site plan plant schedule. Caliper of trees is to be taken 6" (15cm) above grade.
 - 9.2 Plant all specified species in the location as shown on the Landscape drawings. Notify Landscape Architect if conflicting rock or underground/overhead services are encountered.
 - 9.3 Deviation of given planting location will only be allowed after review of the proposed deviation by the Landscape Architect.
10. Excavation:
 - 10.1 Trees and large shrubs: Excavate a saucer shaped tree pit to the depth of the rootball and to at least twice the width of the rootball. Assure that finished grade is at the original grade the tree was grown at.
11. Drainage of Planting Holes:
 - 11.1 Provide drainage of planting pits where required, ie, on sloped conditions, break out the side of the planting pit to allow drainage down slope, and in flat conditions, round to raise the rootball above impervious layer. Notify the Landscape Architect where the drainage of planting holes is limited.
12. Planting and Fertilizing Procedures:
 - 12.1 Plant all trees and shrubs with the roots placed in their natural growing position. If burlapped, loosen around the top of the ball and cut away or fold under, do not pull burlap down under the ball. Carefully remove containers without injuring the rootballs. After settled in place, cut twine. For wire baskets, clip and remove top three rows of wire.
 - 12.2 Fill/fin the planting holes by gently firming the growing medium around the root system in 6" (15cm) layers. Settle the soil with water. Add soil as required to meet finish grade. Leave no air voids. When 2/3 of the topsoil has been placed, apply fertilizer as recommended by the required soil test at the specified rates.
 - 12.3 Where planting is indicated adjacent to existing trees, use special care to avoid disturbance of the root system or natural grades of such trees.
 - 12.4 Where trees are in lawn areas, provide a clean cut mulched 900mm (3 ft.) diameter circle centered on the tree.
13. Staking of Trees:
 - 13.1 Use two 2"x2"x5 stakes, unless superseded by municipal requirements. Set stakes minimum 2 ft. in soil. Do not drive stake through rootball.
 - 13.2 Leave the tree carefully vertical.
 - 13.3 Tie to pre-approved commercial, flat woven polypropylene fabric belt, minimum width 19mm (3/4"). Approved product: Arbor-Tie - available from Deepfoot.
 - 13.4 Coniferous Trees over 6 ft. height: Guy with three 2-strand wires (11 gaug). Drive three stakes equidistant around the tree completely below grade.
 - 13.5 Trees 6 ft. - on Wood or Concrete Docks: Guy as above using three deodent line. 2"x2"x4" buried to the maximum possible depth instead of stakes.
 - 13.6 Mark all guy wires with visible flagging material.

14. Pruning:
 - 14.1 Limit pruning to the minimum necessary to remove dead or injured branches. Preserve the natural character of the plants, do not cut the leader. Use only clean, sharp tools. Make all cuts clean and cut to the branch collar leaving no stubs. Shape affected areas so as not to retain water. Remove damaged material.
15. Mulching:
 - 15.1 Mulch all planting areas with an even layer of mulch to 2-1/2 - 3" (65 - 75mm) depth. Confirm placement of mulch in areas labeled "Groundcover Area" on drawings. Mulch a 3 ft. (900mm) diameter circle around trees in lawn areas, leave a clean edge.
16. Acceptance:
 - 16.1 The establishment of all plant material is the responsibility of the Landscape Contractor.
17. Plant Material Maintenance:
 - 17.1 Maintain all plant material for 60 days after landscape work has received a Certificate of Completion.
 - 17.2 Watering: Conform to B.C. Landscape Standard, Section 13.3.2 - Watering and generally as follows:
 - 17.2.1 Water to supplement natural rainfall such that the soil moisture content is kept to 50% to 100% of field capacity. Water to the full depth of the root zone each time. The Owner is responsible to supply water at no extra cost to the Contract. Confirm source of water prior to beginning work.
 - 17.3 Use appropriate measures to combat pests or diseases damaging plant material. Comply with all local governing statutes and guidelines for chemical control.
 - 17.4 Plant material which fails to survive shall be replaced in the next appropriate season as determined by the Landscape Architect.
 - 17.5 Repair free guards, stakes, and guy wires, when necessary.
 - 17.6 Maintain areas relatively weed free. Appearance level 2, B.C. Landscape Standard, Chapter 13.
 - 17.7 Maintain mulch to specified depths.
 18. Plant Warranty:
 - 18.1 Replace all unsatisfactory plant material except those designated "Specimen" for a period of one (1) year after the Certificate of Completion. Replace all unsatisfactory plant material designated "Specimen" for a period of two (2) years after the Certificate of Completion. Replace all unsatisfactory trees and shrubs and continue to replace these until the specified number is complete and satisfactory to the Landscape Architect. Such replacement shall be subject to the notification, inspection and approval as specified for the original planting, and shall not constitute an extra to the Contract.
 - 18.2 These Plants, identified as hardy within one zone of the Canada Department of Agriculture hardiness zone for the area, specified by the Landscape Architect and installed by the Contractor, which are killed through below normal temperatures below the average of the extreme minimum temperatures officially recorded in the area concerned, in the last 10 years, will not be replaced without cost of replacement borne by the Owner.
 - 18.3 A review may be requested during the latter part of the warranty growing season. All plant material showing well developed foliage, healthy growth and bud forming, will then be taken over.

PART THREE SOFT LANDSCAPE DEVELOPMENT - CONT

- 18.4. For all plant material, the Landscape Architect reserves the right to extend the Contractor's responsibility for another growing season if, in his opinion, leaf development and growth is not sufficient to ensure future satisfactory growth.
- 18.5. Where the Owner is responsible for plant maintenance and has not provided adequate maintenance, the plant replacement section of the contract may be declared void. The Landscape Architect shall determine whether maintenance has been satisfactory using the B.C. Landscape Standard, Section 13, Maintenance as the guide. The required maintenance standard is a minimum of Level Three - Medium. Refer to Section 3.11, Establishment Maintenance.
- 18.6. The Landscape Contractor is responsible to replace any plant material or repair any construction included in the Contract that is damaged or stolen until the issuance of the Certificate of Completion.
- 18.7. Deviation from the specifications may require extension of the Warranty Period as determined by the Landscape Architect.

3.10 INSTALLING LANDSCAPE ON STRUCTURES

1. Verify that drainage and protection material is completely installed and acceptable before beginning work. Contact Landscape Architect for instructions if not in place.
2. Coordinate work with construction of planters and planter drainage.
- 2.1 Verify that planter drains are in place and operative and that drain drains is present prior to placing any drain rock or soil.
3. Provide clean out at all through-slab drain locations. Use 390mm min. dia. PVC pipe filled with drain rock unless specific drawing detail shown.
4. Install drain rock evenly to a minimum depth of 4" (100mm) alternate sheet drain if specified. Install sheet drain as per manufacturer's recommendations.
5. Cover drain rock (or alternate sheet drain if specified on drawing details) with filter fabric: Lappings 65 (150mm) at all edges. Obtain approval of drainage system prior to placing growing medium.
6. Place an even layer of 25 - 50mm clean washed pump sand over filter fabric.
7. Place growing medium to depths specified in Section 3.5 above for various surface treatments. Refer to Drawing details for any light weight filler required to alter grade. Use Styrofoam block over drain rock shaped to provide smooth surface transition at edges. Buttl each piece tightly together and cover with filter fabric to prevent soil from migrating downward.

3.11 ESTABLISHMENT MAINTENANCE (Provide a separate price for this section)

PART ONE - GENERAL

1.1 COPYRIGHT
1. The Structural Soil specification is provided as an instrument of service and remains the property of M2 landscape Architecture. The information provided in this specification is for exclusive use by our client for the specific project noted. This information contained in this document may not be reproduced or distributed, in whole or in part, without the permission of M2 Landscape Architecture.
1.2 SCOPE OF WORK
1. The work of this section shall govern the supply of all equipment, materials and labour necessary for the preparing and placing and compacting Structural Soil Mix on a prepared sub grade.
2. It is the intent that the structural soil mixture will provide the necessary load bearing characteristics for light load hard surface paving areas while allowing and promoting the development of free roots. The long term goals the promotion of healthy, long lived trees while reducing the potential negative implications of large scale roof development under hard surface areas.
3. Refer to drawings for location and dimension of structural soil mixture.
4. All other related work as described in the drawings and/or this specification.
1.3 RELATED WORK
1. Section 02100, Landscape Requirements
2. Section 02710, Landscape Drainage
3. Section 02810, Irrigation System
4. Section 02933, Sodding (Seeding)
5. Section 02906, Planting Trees, Shrubs, and Groundcover
1.4 RELATED MASTER MUNICIPAL SPECIFICATIONS
1. Contractor to report all conflicts with civil engineering to Landscape Architect
2. Section 02210, Site Grading
3. Section 02223, Excavating, Trenching, and Backfilling
4. Section 02226, Aggregates and Granular Materials
5. Section 02666, Waterworks
6. Section 02721, Storm Sewers
7. Section 02725, Manholes and Catch Basins
1.5 STANDARDS
1. BCSLA/BCLNA Landscape Standard (most current edition)
2. Canadian System of Soil Classification
1.6 QUALITY ASSURANCE
1. All structural soil material used in street tree planting shall be from a source approved by the Consultant and all similar materials supplied to the site shall be of similar nature and from a single source. 14 days prior to supplying any material to the site, inform the Consultant of proposed source and provide a copy of an analysis undertaken by a recognized testing agency approved by the owner, at the Contractor's expense and indicating the particle size characteristics of the proposed material in written form as laid out in 2.11 of this section.
2. All nutritive admixtures to structural soil material supplied to the site shall be from a source approved by the Consultant and all similar nutritive admixtures supplied to the site shall be of similar nature and from a single source. 14 days prior to supplying any nutritive admixture, inform the Consultant of proposed source and provide a copy of an analysis undertaken by a recognized testing agency approved by the owner. The test report shall quantify and qualify the following characteristics of the proposed nutritive admixture.
2.1 Gravel, sand and fines content each as a % of dry weight mineral
2.2 Organic material content as a percentage of dry weight.
2.3 Acidity (pH)
2.4 Salinity in millimhos/cm at 25 degrees C.
2.5 Basic fertility (total nitrogen available K, Ca, Mg, P)
2.6 Recommendation for incorporation of necessary amendments.
3. Provide and pay for all required testing of materials proposed for use on this project. At the Consultant's discretion, all materials may be re-tested. Contractor will be responsible for costs of re-testing if materials do not meet specification and for correction of the deficiency.
4. Cost of imported materials shall include cost of modifications from source to ensure that these materials meet specifications.
5. Acceptance of material at source does not preclude future rejection if material fails to conform to requirements specified.
6. Confirm compaction of subgrade and structural soil by Geotechnical Reports from qualified Geotechnical Engineer.
7. Aggregate Test:
7.1 Provide source and sieve designation of intended aggregate material prior to ordering.
7.2 At the Landscape Architect's discretion, materials may be retested. Contractor is responsible for costs of testing if sample does meet specification and for correction of any deficiency.
7.3 Submit 2.5kg sample of stone to Landscape Architect prior to mixing. Sample should be labelled to include source of material submitted.
8. Structural Soil Mix Design
8.1 Prepare sample of structural soil mix with proposed mix ratios for approval by Landscape Architect a minimum of 14 days prior to placement. Notify Landscape Architect minimum 2 days prior to mixing samples.
8.2 Landscape Architects may request additional samples of Structural Soil mixture to be tested in the event that further refinement of the mixture is necessary.
1.7 SCHEDULING
1. Obtain approval from Consultant of schedule 14 days in advance of structural soil preparation or delivery of material to site. Co-ordination of the installation of the structural soil mixture is critical. Ensure scheduling has been co-ordinated with all consultants and related contractors.
2. Schedule to include;
2.1 date for commencement of preparation of structural soil at source
2.2 sub grade preparation at site
2.3 shipping dates
2.4 arrival dates on site
2.5 installation dates
3. Schedule work to co-ordinate with installation of any drainage, irrigation, tree grate footings, lighting, paving etc.
4. Complete work to ensure tree planting will occur under optimum conditions
5. Do not handle or place structural soil mix in rain.
1.8 FIELD REVIEW
1. Start up meeting with Consultant is required to confirm the areas of installation and mixing. If not previously submitted, ensure growing medium sample and test report, aggregate stone sample and structural soil sample and report are supplied at the Start-up Meeting.
2. Co-ordinate site meeting with Consultant at the following times
2.1 drainage installation and connection
2.2 irrigation installation
2.3 mixing of structural soil mixture
2.4 installation of structural soil mixture
2.5 sub grade preparation and layout.
2.6 installation of trees
3. Where materials are installed in phases, it is the contractors responsibility to inform the Consultant of critical installation times for each phase as noted in Section 1.8.2.
1.9 SAMPLES
1. Provide 2 kg samples of all materials required for the preparation of structural soil minimum 14 days prior to commencement of installation. Samples of all material shall be submitted with test report from approved testing agency as per section 1.3.2. and 1.3.3
1.10 PRODUCT HANDLING
1. All materials used in the composition of structural soil shall not be prepared, worked or traveled upon when in a wet or frozen condition.
2. Supply and handle dolomite lime, fertilizer, stabilizer and other chemical amendments in standard, sealed, waterproof containers with net weight and product analysis clearly marked on exterior of package.
1.11 DELIVERY, STORAGE AND PROTECTION
1. For structural soil prepared at source and delivered to site, deliver all materials to site in such a manner as to prevent damage to or separation of all materials used in the preparation of structural soil.
2. On-site storage of prepared structural soil shall be undertaken in such a manner as to prevent damage or separation of any materials.
3. Structural soils to be installed as soon as practicable after mixing, any structural soils stored overnight whether on-site or at source shall be covered with tarpaulin of material approved by the Consultant until such time as materials installed.
4. All material to be stockpiled shall be protected in accordance With B. C. Ministry of Environment guidelines.

PART TWO - PRODUCTS

2.1 GROWING MEDIUM

1. TABLE ONE:

1.1 Provide all growing medium required to complete the work.

1.2 Comply with the requirements of Table 1, below

1.3 Organic material in the growing medium must be well decomposed to prevent oxygen consumption caused as a result of decomposition of the organic matter in the soil mixture.

TABLE ONE

PROPERTIES	GROWING MEDIUM FOR GAP-GRADED MIXTURE
TEXTURE: Particle size classes by the Canadian System of Soil Classification	
Gravel: greater than 2mm - less than 75mm	0
Sand: greater than 0.05mm - less than 2mm	maximum 60%
Silt: greater than 0.002 mm - less than 0.05 mm	maximum 35%
Clay: less than 0.002mm	maximum 15%
Clay and Silt Combined	maximum 40%
ACIDITY (pH):	6.0 - 7.0
DRAINAGE: Minimum saturated hydraulic conductivity (cm/hr) in place.	3.0
SALINITY: Saturated extract conductivity shall not exceed:	3.0 millimhos/cm at 25°C
ORGANIC CONTENT: Percent of Dry Weight (%)	8% - 12%

2.2 AGGREGATE

1. Clean inert stone of high angularity is preferred over washed gravel.

2. Stone dimension aspect ratio should approach 1:1:1 with a maximum of 2:1:1 length: width: depth.

3. Single size stone, 75mm clear sieve designation: Blasted Quarry Rock.

4. Aggregate to be used for structural soil shall be free of any foreign elements or material. Provide samples and test reports as described in section 1.5 and 1.8

5. Aggregate quality: Material shall be sound hard, durable, free from soft, thin, elongated or laminated particles, organic material, clay lumps or material, or other substances that would act in a deleterious manner or use intended.

2.3 SOIL STABILIZER

1. A non-toxic organic binder.
Product: Stabilizer, The Original Natural Binder, as available from Island Sport Turf, Parksville, BC. 250-616-1199. Also available from Yardworks Supply Ltd., Aldergrove, BC. 604-607-3004.

2.4 GRANULAR BASE

1. To Master Municipal Specification Section 02226, Aggregates and Granular Materials.

2.5 PAVING MATERIALS

1. Refer to architectural drawings.

2.6 FILTER FABRIC

1. Non Woven filter fabric shall be installed as a separation layer directly above the compacted structural soil mixture. Do not install fabric until adequate compaction of the structural soil mixture has been confirmed.

2. Filter fabric shall be selected and designed to withstand wear and tear during construction without deterioration of its strength and filtering properties. Conform to the following ASTM designations:

- Grab Tensile Strength ASTM-D-4632 4.00 kN
- Tensile Elongation ASTM-D-4632 50%
- Mullen Burst ASTM-D-3786 1270 kPa
- Flow Rate ASTM-D-4491 6110 l/min/m²

3. Fabric shall be Amoco 4545 or approved equivalent.

PART THREE - EXECUTION

3.1 SUBGRADE
1. Excavate sub grade to establish tree pit / trench as indicated on contract drawings. Place the structural soil under the paving adjacent to the planting pits, NOT in the planting pits themselves.
2. Areas designated as structural soil tree pits for street tree planting shall be prepared to ninety-five percent (95%) Modified Proctor Density and shall be free of stones, debris, root branches, toxic materials, building materials and other deleterious materials to the approval of the civil engineer.
3.2 PREPARATION OF EXISTING GRADE
1. Verify that grades are correct. If discrepancies occur, notify Consultant and do not commence work until directed.
2. Excavate trench to Master Municipal Specification Section 02223, Trenching, Excavation and Compaction allowing for design depth and width of structural soil mix.
2.1 Refer to contract drawings for areas to be treated and to details for dimensions
2.2 Compact to 95% Modified Proctor Density.
2.3 Subgrade elevations shall slope parallel to the finished grades and/or toward the subsurface drain lines as indicated on the civil engineering drawings.
4. Do not proceed with the installation of the structural soil material until all walls, curbs, and utility work in the area has been installed. Structural elements or design features that are dependent on the structural soil mixture for support may be postponed until after the installation of the mixture.
5. Re-compact disturbed subgrade to requirements of master municipal specifications and civil engineering drawings.
3.3 SUB DRAINS
1. Install to requirements of Master Municipal Specifications. Refer to Section 02666, Waterworks, Section 02721, Storm Sewers, and Section 02725, Manholes and Catch Basins
1.1 Install prior to installation of the structural soil mixture.
1.2 Co-ordinate all contract drainage work with other drainage on-site
1.3 Confirm location of storm sewer connections with civil engineer.
3.4 IRRIGATION
1. Install to requirements of Section 02810, Irrigation System. Refer also to Irrigation Drawings.
1.1 Install irrigation main lines in co-ordination with installation of the structural soil. Confirm timing at start-up meeting
1.2 Co-ordinate all contract irrigation work with other civil engineering and drainage on-site
1.3 Confirm location of irrigation connections with civil engineer.
3.5 MIXING STRUCTURAL SOIL MATERIAL
1. Ensure consistent even distribution of all components by thorough mixing. The ratio of components will vary and may require adjustment to ensure the soil volume is adequate to fill all voids in the stone.
2. Base Ratio of Materials:
- 4 cu metre of aggregate stone section 2.2
- 125 cu metre of Growing Medium section 2.1
- 2 kg Stabiliser section 2.3
• Water as required
• The amount of water required will vary according to moisture present in growing medium.
3. Combine the stone, growing medium and Stabilizer product into a thorough, homogeneous mixture. Moisten mixture with fine spray of clean potable water while mixing to activate Stabilizer product.
3.6 MIXING
1. Do not OVER MIX, OVER HANDLING can result in separation of the growing medium from the stone. Further and final mixing will occur during the placement of the material.
2. All mixing shall be performed on a flat hard, level surface approved by the consultant, using the appropriate soil mixing equipment.
3. Prepare sample Structural Soil Mixes to determine ratio of mix components. Submit sample with test results for approval.


PART THREE - EXECUTION (cont)

3.6 MIXING
1. Do not OVER MIX, OVER HANDLING can result in separation of the growing medium from the stone. Further and final mixing will occur during the placement of the material.
2. All mixing shall be performed on a flat hard, level surface approved by the consultant, using the appropriate soil mixing equipment.
3. Prepare sample Structural Soil Mixes to determine ratio of mix components. Submit sample with test results for approval.
3.7 PLACEMENT
1. Subgrade shall be approved by the Consultant prior to placement of the structural soil mixture.
2. Structural soil shall be moist, but not saturated with water when placed. Placement shall be handled to avoid damage to drainage structures, irrigation equipment, concrete structure or pavement.
3. Place Stone mixture in 300mm lifts through entire area of structural soil mixture.
4. Compact each lift of structural soil material with vibrating drum roller to the satisfaction of the civil engineer.
5. Provide Geotechnical Report to confirm compaction. Test to ensure uniform, acceptable compaction rates have been achieved for each lift and in all areas of structural soil mixture. Refer to Quality Assurance, section 1.5
6. Provide a uniformly firm and level surface allowing for specified depths of road base and / or growing medium to meet finished design grade.
7. Installation of structural soil in the location of the tree is not recommended. Various techniques such as reinforced wood boxes, steel boxes, large diameter PVC pipe, etc. have been employed to allow for sand to be installed at the tree location with the compacted structural soil surrounding the hole. At the time of tree installation, the sand is removed and growing medium (as per Section 2.1) added to surround the root ball.
3.8 INSTALLATION OF FILTER FABRIC
1. After approval of structural soil mixture compaction, install Filter Fabric.
2. Ensure minimum 60cm overlap of all fabric seams and beyond edge of structural soil.
3.9 GRANULAR BASE MATERIAL
1. Place minimum 75 mm granular base on top of filter fabric over structural soil layer.
2. Compact granular base to 95% Modified Proctor Density. Compaction must be consistent with other surrounding granular base materials.
3. All areas shall be graded too the contours and elevations indicated on the contract drawings. Ensure positive drainage.
3.10 PROTECTION
1. Protect existing conditions from damage or staining and make good any damage.
2. All damage will be repaired at the expense of the installation contractor.
3.11 TREE PLANTING
1. Remove structural soil or other backfill material (sand, see comments in section 3.7.7) from the full dimensions of the tree grate area (1.2m x 1.2m x depth of root ball).
2. Re compact all material below root ball to original specified density to prevent settling of the root ball in the hole.
3. Ensure tree is planted in the exact centre of the specified planting station straight and true.
4. Install tree in accordance with BCSLA Landscape Standard. Cut away synthetic root ball twine, cut back improperly sized wire baskets, pull back burlap from around trunk etc.
5. Backfill with Growing Medium as per Section 2.1. Ensure the same growing medium used in the structural soil mix is installed as backfill material.
6. Place 50mm depth composted fir/hem bark mulch over the top of the open tree pit area.
3.12 TREE GRATES
1. Site Furniture and to contract drawings for tree grates, frames and footings.
3.13 ACCEPTANCE
1. Consultant shall inspect structural soil "in place" and determine acceptance of material, and finish grading prior to paving.
2. Finish grade shall be to within 15mm of proposed grades within 3.0m of any adjacent fixed elevation and to within 15mm of proposed grades over any other 3.0 length. Finish grades shall not be uniformly high or low.
3.14 SURPLUS MATERIAL
1. Remove all excess fill soils and mix stock piles and dispose of all waste materials, trash and debris from the site.
2. Clean up any soil or dirt spilled on any paved surface at the end of each working day.
3. Upon completion of the structural soil mixture installation. Leave area broom-clean. Avoid washing the area until all of the paving has been completed.

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11	2024-09-26	REVISED PER CITY COMMENTS	SH
10	2023-09-10	ISSUED FOR DP	QL
9	2023-07-10	ISSUED FOR DP	QL
8	2023-09-21	ISSUED FOR DP	QL
7	2023-09-09	ISSUED FOR DP	QL
6	2023-02-15	ISSUED FOR DP	QL
5	2022-08-16	ISSUED FOR DP	QL
4	2022-08-11	ISSUED FOR DP	QL
3	2022-08-02	ISSUED FOR DP	QL
2	2022-07-24	ISSUED FOR PRELIMINARY DESIGN	QL
1	2022-07-28	ISSUED FOR PRELIMINARY DESIGN	QL
NO.	DATE	REVISION DESCRIPTION	DR.

SEAL:

PROJECT:
HERITAGE REVITALIZATION AND
NEW LOW ENERGY DUPLEX
311 W 14TH STREET
CITY OF NORTH VANCOUVER, BC

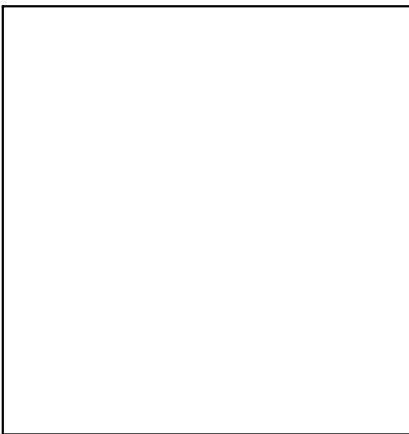DRAWING TITLE:

STRUCTURAL SOIL
SPECIFICATIONS

DATE: JUL 7, 21/22	DRAWING NUMBER:
SCALE: 1"= 3/16"	
DRAWN: QL	
DESIGN: QL	
CHK'D: MTLM	OF 11

M2LA PROJECT NUMBER: 22-030