

Revision:



Project:

120-128 East 14th Street North Vancouver.

Draw by:	AL
Check by:	SV
Date:	INSERT DATA
Scale:	1/8''=1'-0''
Drawing Title:	


Landscape Site Plan Level 1


Project No.:
21075

Sheet No.:

L.1.1



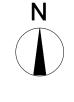

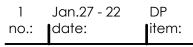

Revision:



Project:


120-128 East 14th Street North Vancouver.

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Landscape Site Plan Level 2

Project No.: 21075

Sheet No.:

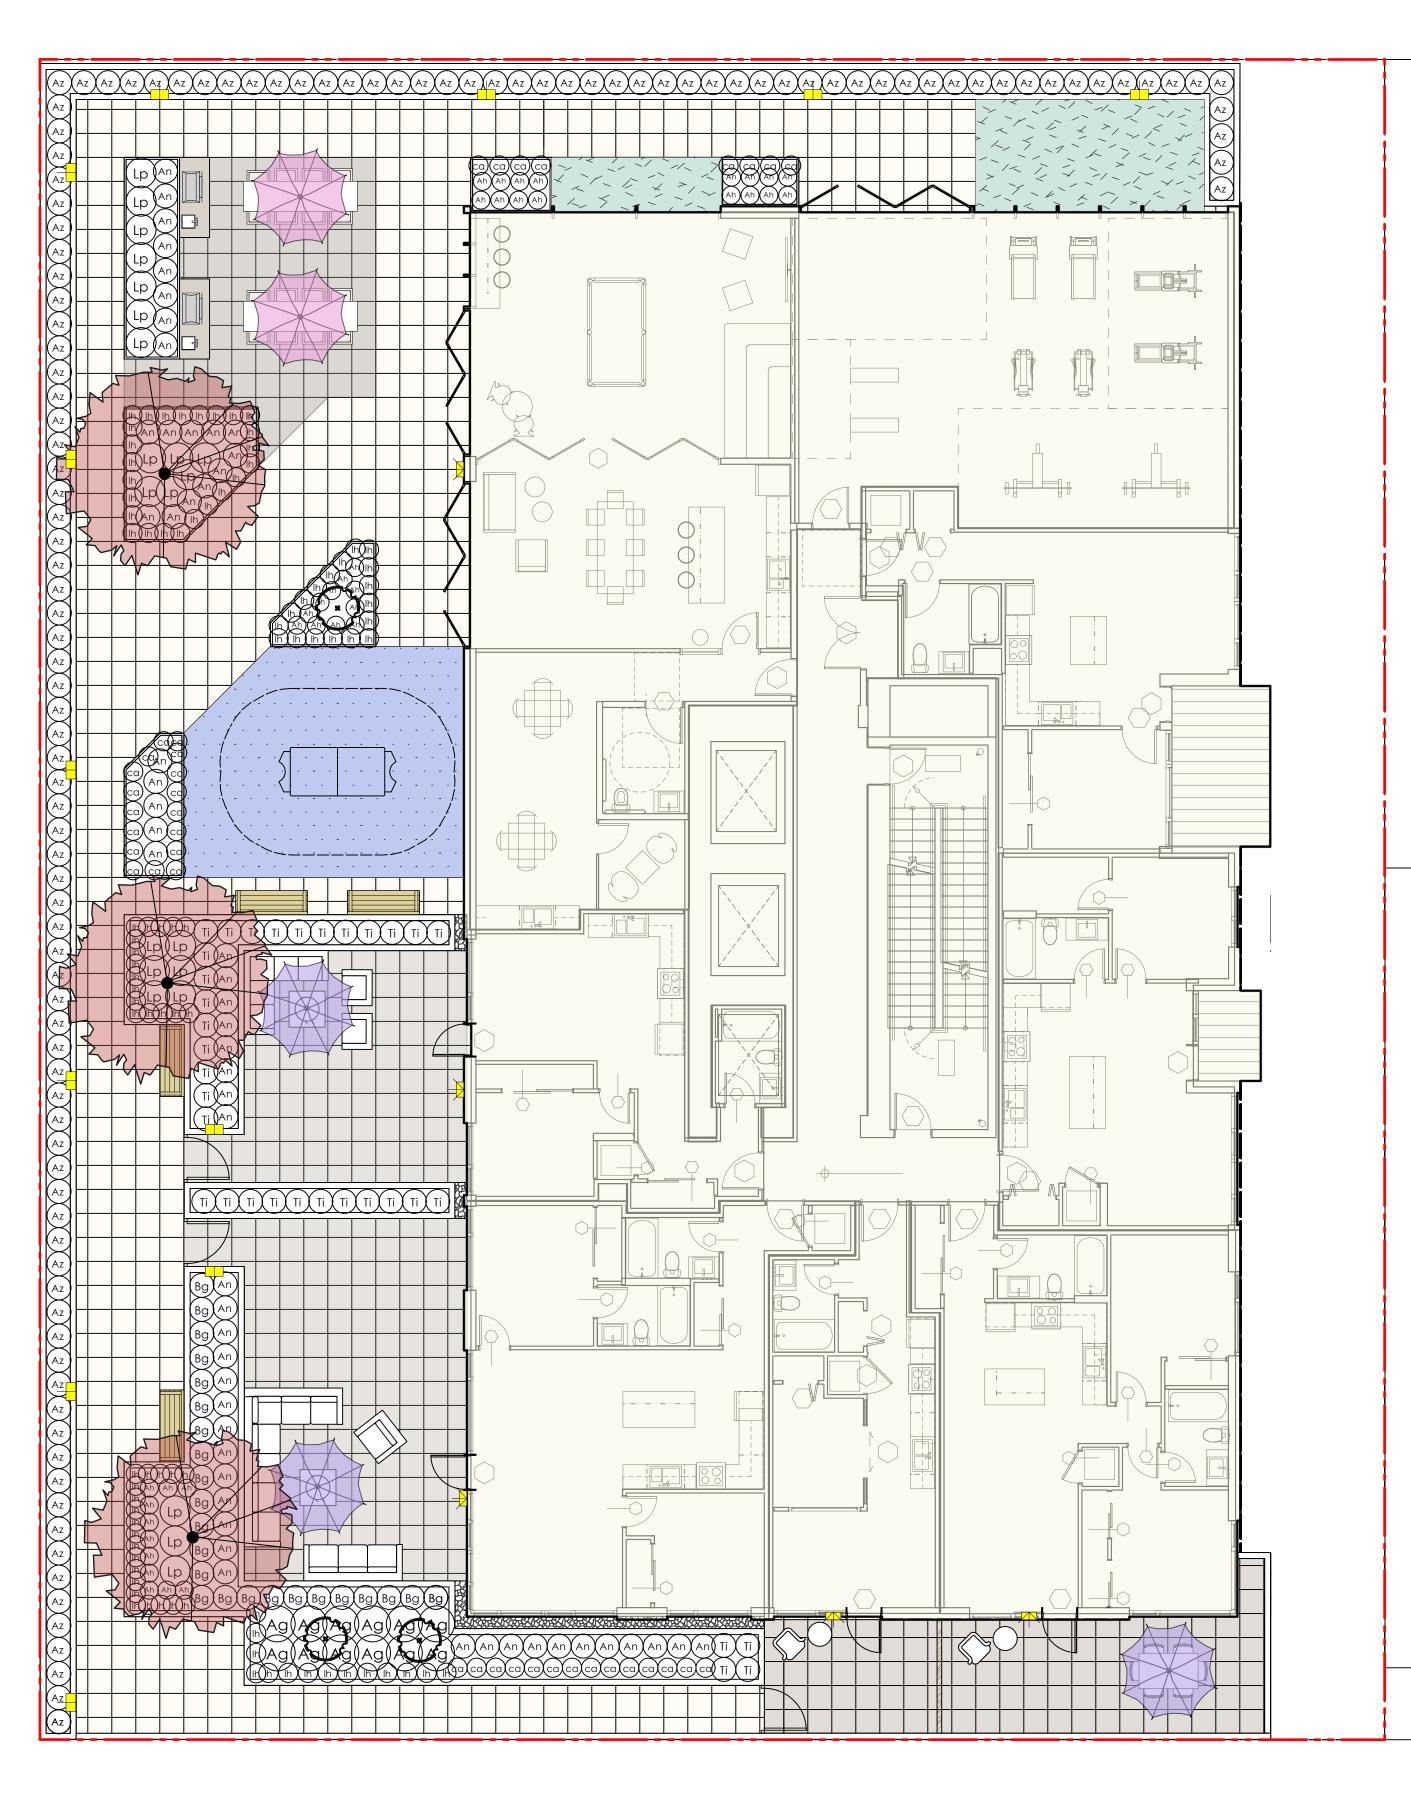

GENERAL PLANTING NOTES:


- 1. All work shall meet or exceed the requirements as outlined in the Current Edition of the Canadian Landscape Standard.
- 2. Plant sizes and related container classes are specified according to the Current Edition of the Canadian Landscape Standard. For container classes #3 and smaller, plant sizes shall be as shown in the plant list and the Standard; for all other plants, bothplant size and container class shall be as shown in the plant list. Specifically, when the plant list call for #5 class containers, these shall be as defined in the BCNTA (ANSI) Standard.

GENERAL IRRIGATION NOTES:

- 1. All items as specified Rainbird or pre-approved equals.
- 3. Backflow Preventer, Blowout Tee and Controller to be installed to meet local plumbing codes.
- 4. Exact locations and layout to be approved by Landscape Architect prior to installation. No valves or valve boxes to be located within hard paved surfaces. Adjust all head locations, heights, and overall performance of the system to the satisfaction of the Landscape Architect
- 5. All valve boxes to have 6" of drain rock in base.
- 6. Install sleeving for pipes below all paved surfaces.
- 7. Minimum 16" cover over all irrigation lines.
- 8. Irrigation is to be provided to all soft landscape areas.

PLANT LI	ST				
	TREES				
	Sym	Qty	Latin Name	Common name	Size/Spacing
	and the second	3	Cornus kousa	Kousa Dogwood,	5cm cal. B&B
					5cm cal. B&B
	Shrubs Sym	Qty	Latin Name	Common name	Size/Spacing
	An	56	Azalea 'Nikko'	Nikko Azalea	#2 pot,24" O.C.
	Ag	12	Azalea `Gumpo White` (Satsuki hybrid)	Gumpo White Azalea	#2 pot,24" O.C.
	Ah	38	Azalea `Hino-White'	Azelea Hino White	#2 pot,18" O.C.
	Bg	25	Buxus microphylla japonica 'Green Beauty'	Green Beauty Boxwood	#3 pot,24" O.C.
	Az	122	Camellia japonica 'Girard's Fuchsia'	Japanese Azalea	#2 pot,24" O.C.
{ * }	•	3	Hamamelis x intermedia 'Arnold Promise'	Arnold Promise Witch Hazel	15 ga. pot, Specim
	Lp	22	Lonicera Pileata	Privet Honeysuckle	#2 pot,30" O.C.
	Ti	34	Taxus x media 'Hillii' (Male Plants Only)	Hill's Yew	4' ht B&B, R to R
GROUNDCO	OVERS, GRASS	ES, FERNS & V	INES		
	Sym	Qty	Latin Name	Common name	Size/Spacing
_	ca	39	Carex morrowii 'Ice Dance'	Ice Dance Japanese Sedge	#1 pot 12" O.C.
	lh	94	Lavandula angustifolia 'Hidcote'	Hidcote Lavender	#2 pot 18" O.C.



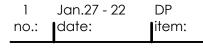

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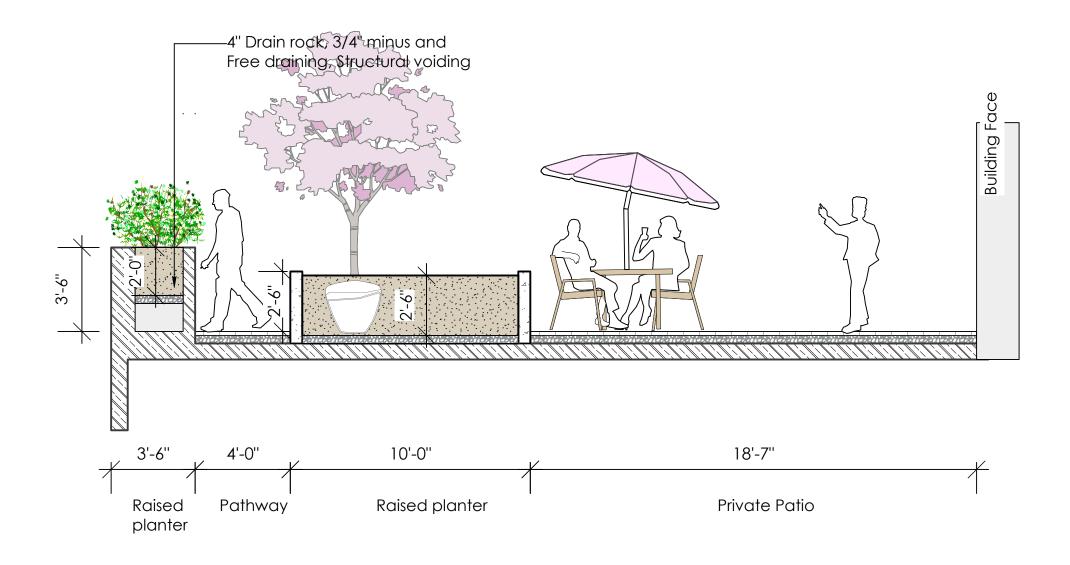
Drawing Title:

Plant Design Plan Level 2

Project No.: 21075


Sheet No.:

L-1.3



A Section through pathway and private patio

Scale: 1/4" = 1'-0"

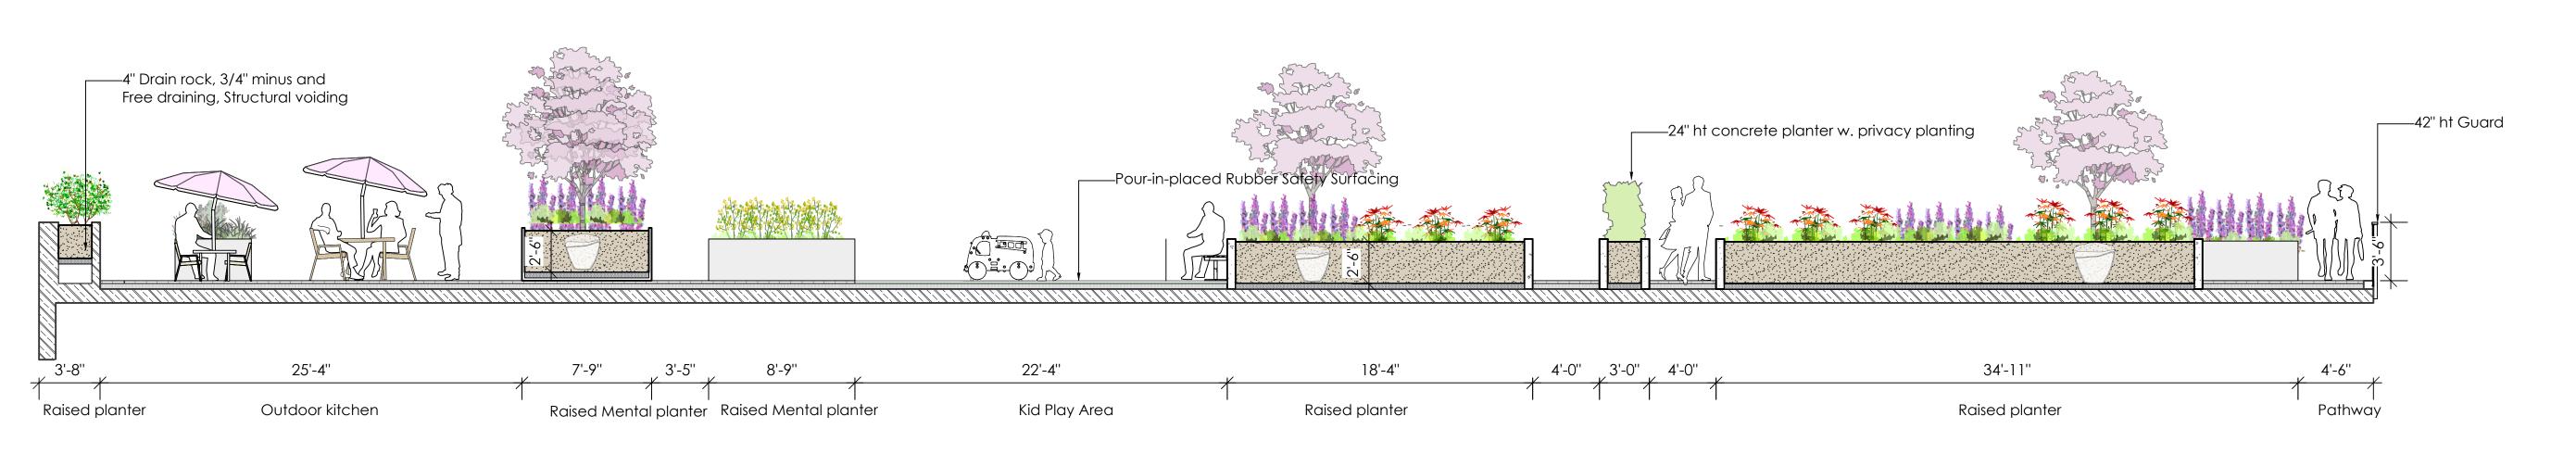

B Section through outdoor kitchen and kid play area

Scale: 3/16" = 1'-0"

no.: date: item:

Revision:

DURANTE KREUK LTD.
102 - 1637 West 5th Avenue
Vancouver B.C. V6J 1N5
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1 Jan.27 - 22 DP

Project:

120-128 East 14th Street North Vancouver.

Draw by: AL

Check by: SV

Date: INSERT DATA

Scale: As shown

Drawing Title:

Landscape Section


Project No.: 21075

Sheet No.:

1. Do not cut Tree Leader.

- 2. Protect tree from damage during planting. Ensure rootball protected from Sun, Frost
- 3. Ensure tree location does not conflict with Underground Services. "Call before digging". 4. All street trees to be staked with 2 - 4"Ø x 8' long. Minimum depth of stake embedment is 3'. Ensure stakes do not penetrate or damage rootball. Ensure all stakes are aligned
- 5. Provide min. 5 cubic meters of growing medium per tree. 6. Refer to Growing Medium Chart below for surface area depth of Growing Medium.


parallel to sidewalk/road on tree pit centreline.

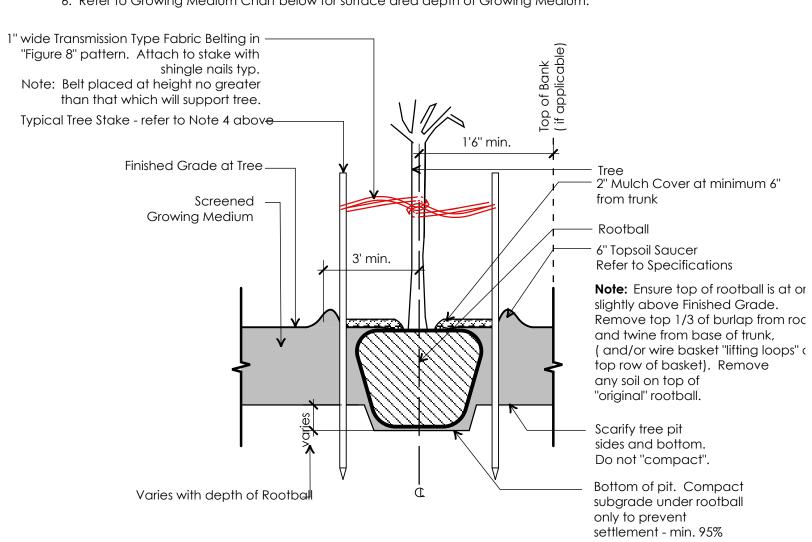


				J.I .D.
	Depth of Growing		Variation 1	Variation 2
_	Medium Total (mm)	Area (M2)	Size of Surface Square	Size of Surface Circle
	450	11.11	3.3 M x 3.3 M	3.80 M Ø
_	600	8.33	2.9 M x 2.9 M	3.25 M Ø
-	750	6.67	2.6 M x 2.6 M	2.90 M Ø

Tree Planting on Grade L 2-1 Scale: 1" = 1'-0"

L 2-1

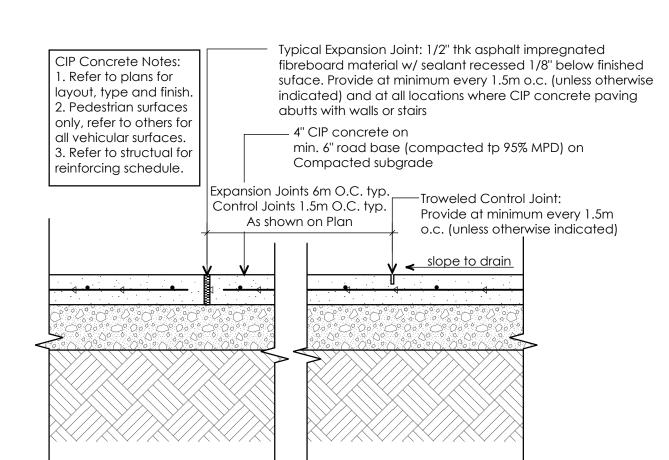



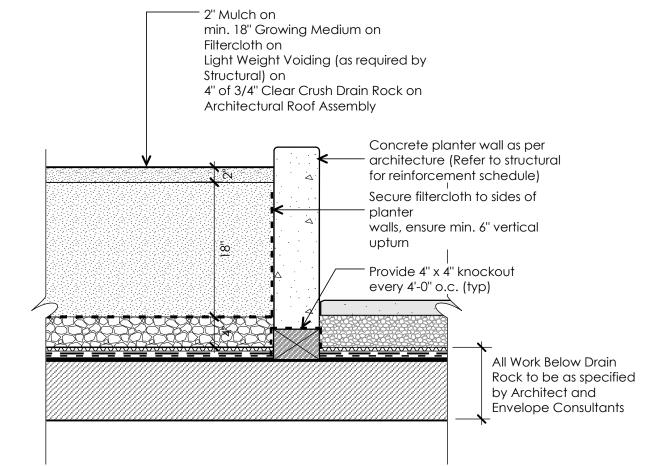

Typical CIP Concrete Planter on Slab

Scale: 1" = 1'-0"

2 Tree Retention

6" of 1-2" ø decorative River Rock

3/4" clear crush drain rock —

extend gravel to connect

to permiter drainage.

at building face

Ld - 06


L 2-1

L 2-1


How can trees be successfully retained?

Trees can be retained only if an adequate root mass can be maintained in good condition. Trees retained with inadequate roots, or where roots sustain significant damage due to construction, will most likely die within a few years. If the damage is severe, they can soon become hazardous and fail, potentially causing damage to present and present.

Retaining significant trees when properties are redeveloped is important in maintaining the established natural character associated with many of Vancouver's neighbourhoods. Their continued healthy growth is greatly enhanced by the By-law requirement of providing special protective barriers. Barriers are required to protect the roots, trunks and branches of trees on private property as well as on City property prior to and during on-site construction (Figure 3). (To calculate the dimensions for tree barriers on private property, refer to Schedule D 'Tree Protection Distance Table' below. For trees on City property, refer to Section 4.2 of the Tree Retention, Relocation

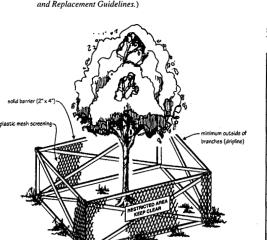

Trun Diame (cm	ter	Minimum Protection Req'd Around Tree (distance from trunk in metres)
20		1.2
25		1.5
30		1.8
35		2.1
40		2.4
45		2.7
50		. 3
55		3.3
60		3.6
75		4.5
90		5
100	, 1	6.0

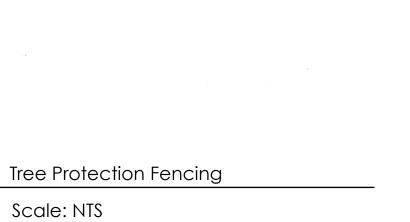

____2" x 6" on edge

Scale: 1" = 1'-0"

specifications

NOTES

Drip Strip at Building Face

shown. Refer to L03 for dimensions.

architect and architect.

consultant for review.

level to be 2" below rim.

deflect outward.

Green Theory

Tristan Tressel

Phone: 604 475 7002

3. Planters to be get powder coated (aluminum) to match

CONTACT FOR METAL PLANTERS - OR APPROVED EQUAL

804 1515 Broadway St. Port Coquitlam BC V3C 6M2

Email: tristan@greentheorydesign.com

Prefabricated Metal Planters


Scale: 1" = 1'-0"

https://greentheorydesign.com

architectural railings. RAL Colour to be reviewed by landscape

-pressure treated stake

Planting Bed

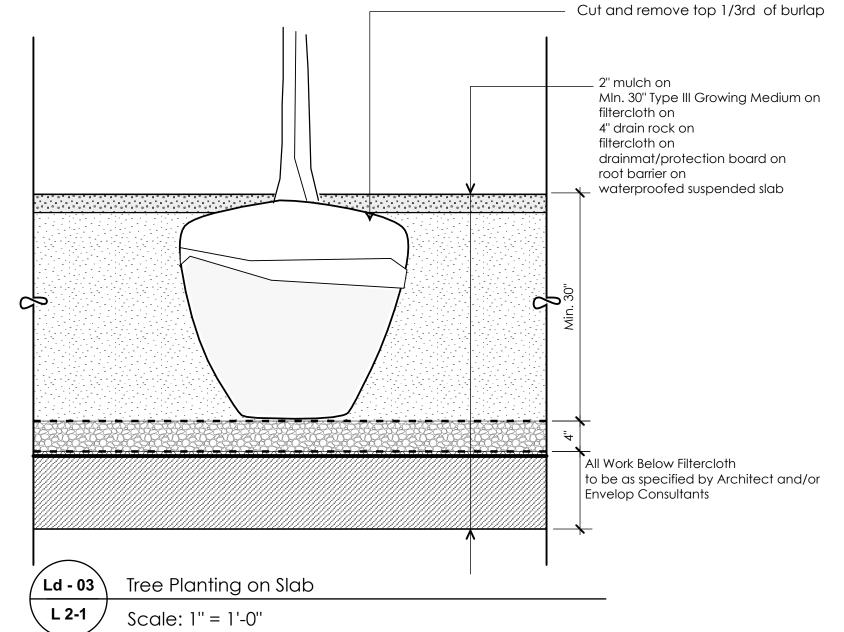

— 4" CIP concrete on

Control Joints 1.5m O.C. typ.

As shown on Plan

CIP Concrete Paving on Grade (Slab)

(compacted tp 95% MPD) on

Architectural Roof Assembly

Expansion Joints 6m O.C. typ. — Troweled Control Joint:

CIP Concrete Notes:

1. Refer to plans for

layout, type and finish.

2. Pedestrian surfaces

only, refer to others for

all vehicular surfaces.

3. Refer to structual for

reinforcing schedule.

Scale: 1" = 1'-0"

Typical Expansion Joint: 1/2" thk asphalt impregnated fibreboard

minimum every 1.5m o.c. (unless otherwise indicated) and at all

slope to drain

locations where CIP concrete paving abutts with walls or stairs


compacted road base (min. 6" road base)


(depths vary according to sloping slab) on


material w/ sealant recessed 1/8" below finished suface. Provide at


Provide at minimum every 1.5m

o.c. (unless otherwise indicated)

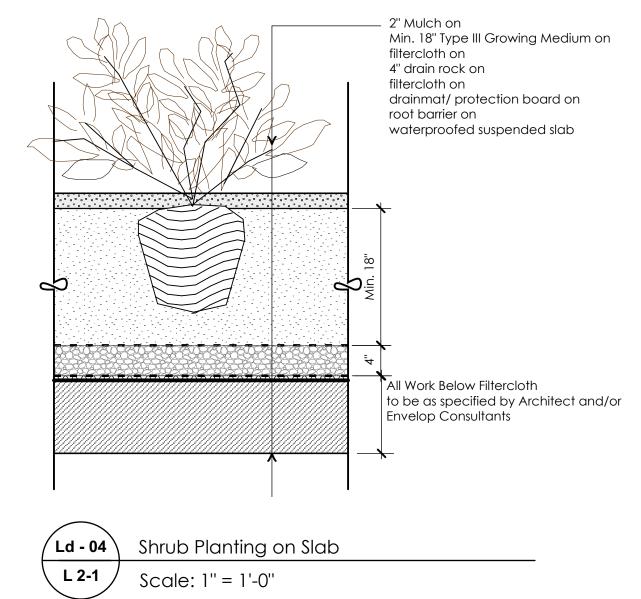

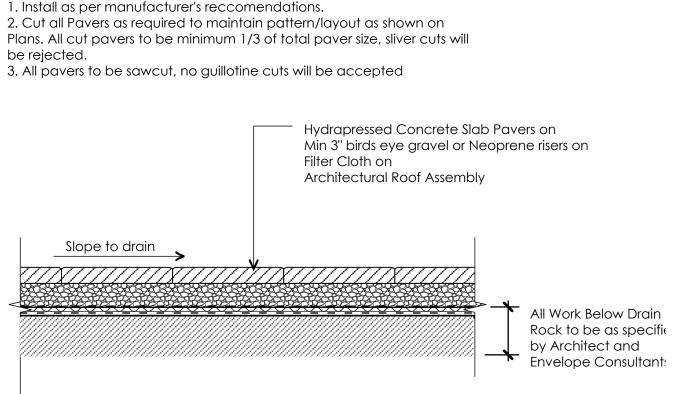

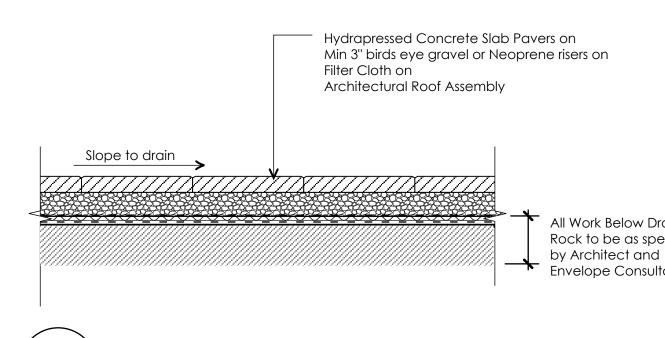

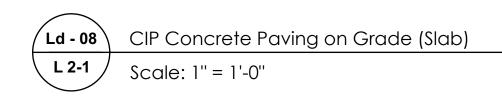



1 Jan.27 - 22 DP

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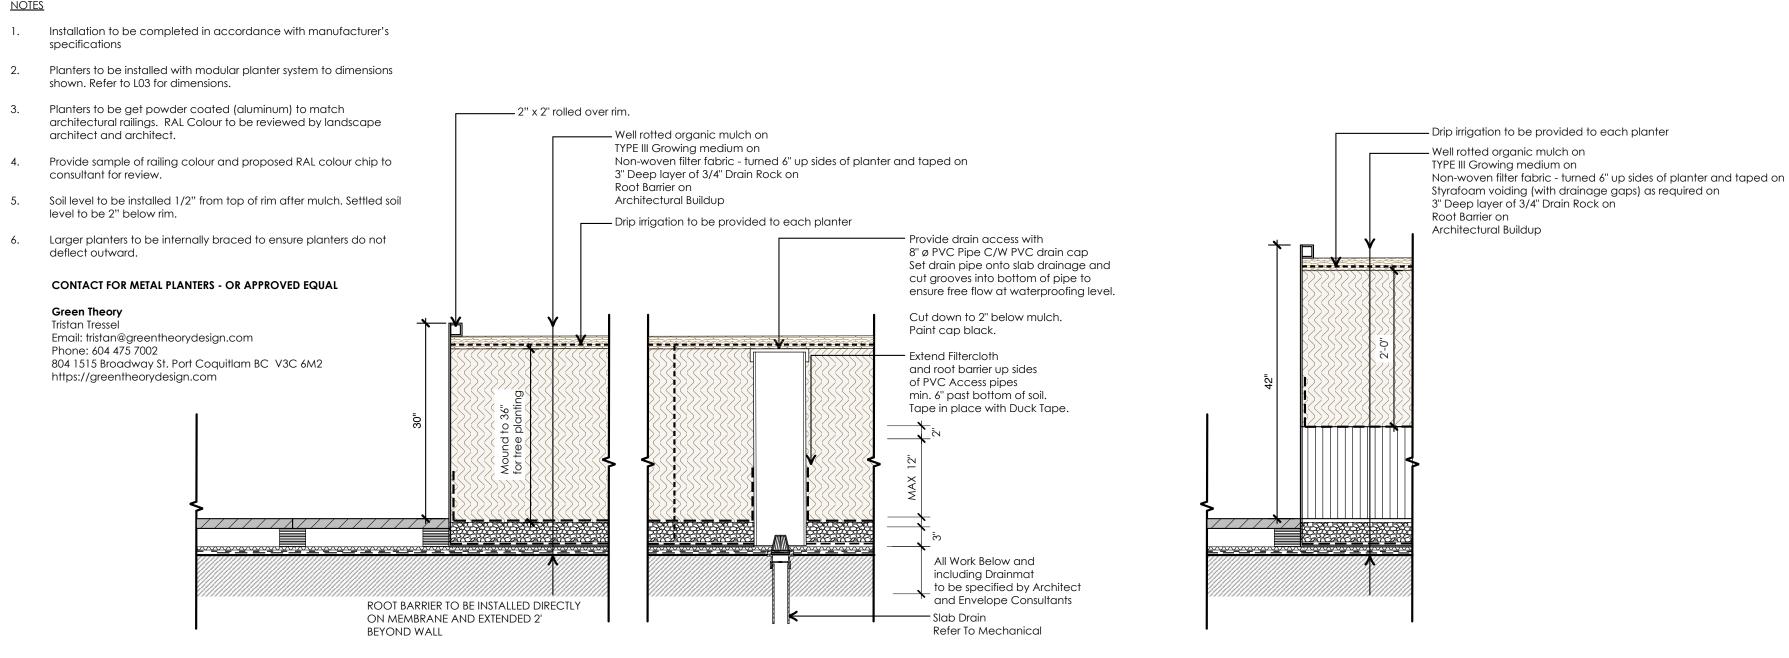
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no.: |date:


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All Work Below Drain

Rock to be as specified by Architect and

Envelope Consultants



Landscape Details

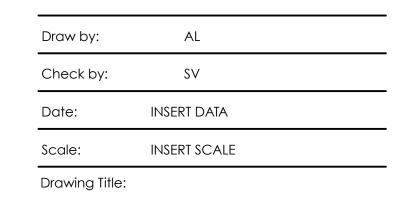Project No.: 21075 Sheet No.:

L- 2.1